

TOWN OF SIMSBURY, CONNECTICUT


TRUCK WASH BAY DEPARTMENT OF PUBLIC WORKS 66 TOWN FOREST RD SIMSBURY, CONNETICUT

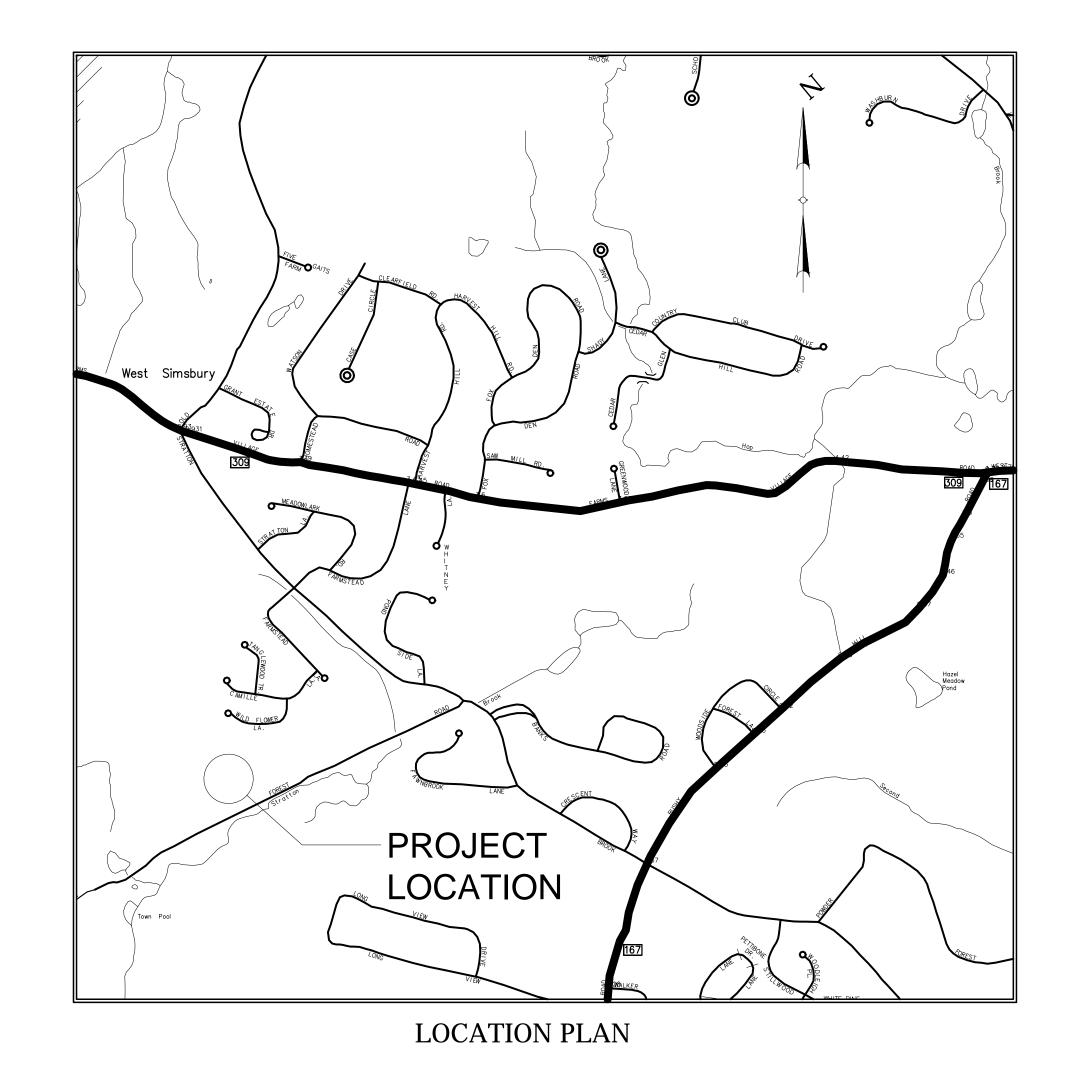


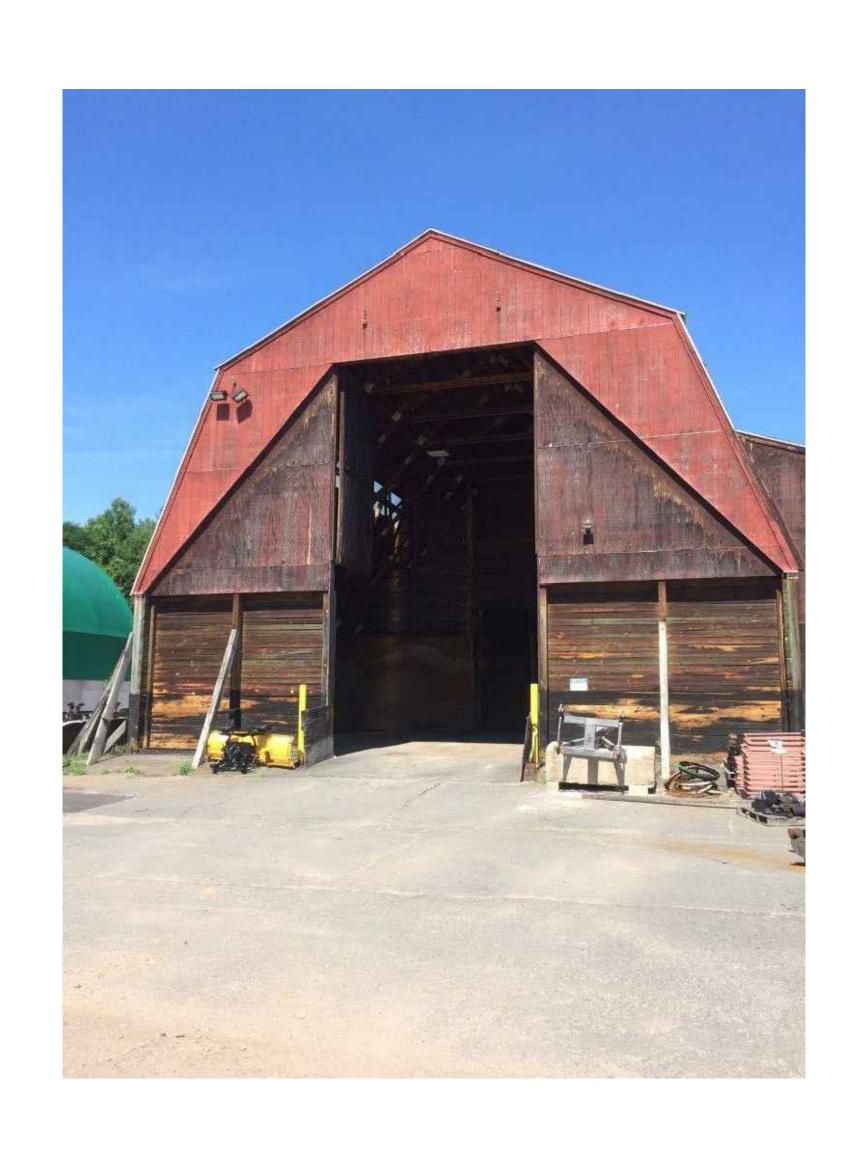




/:\Projects\2015\15-133_Simsbury_Public Works Salt Shed\CADD\currentedit.dwgPLO⁻

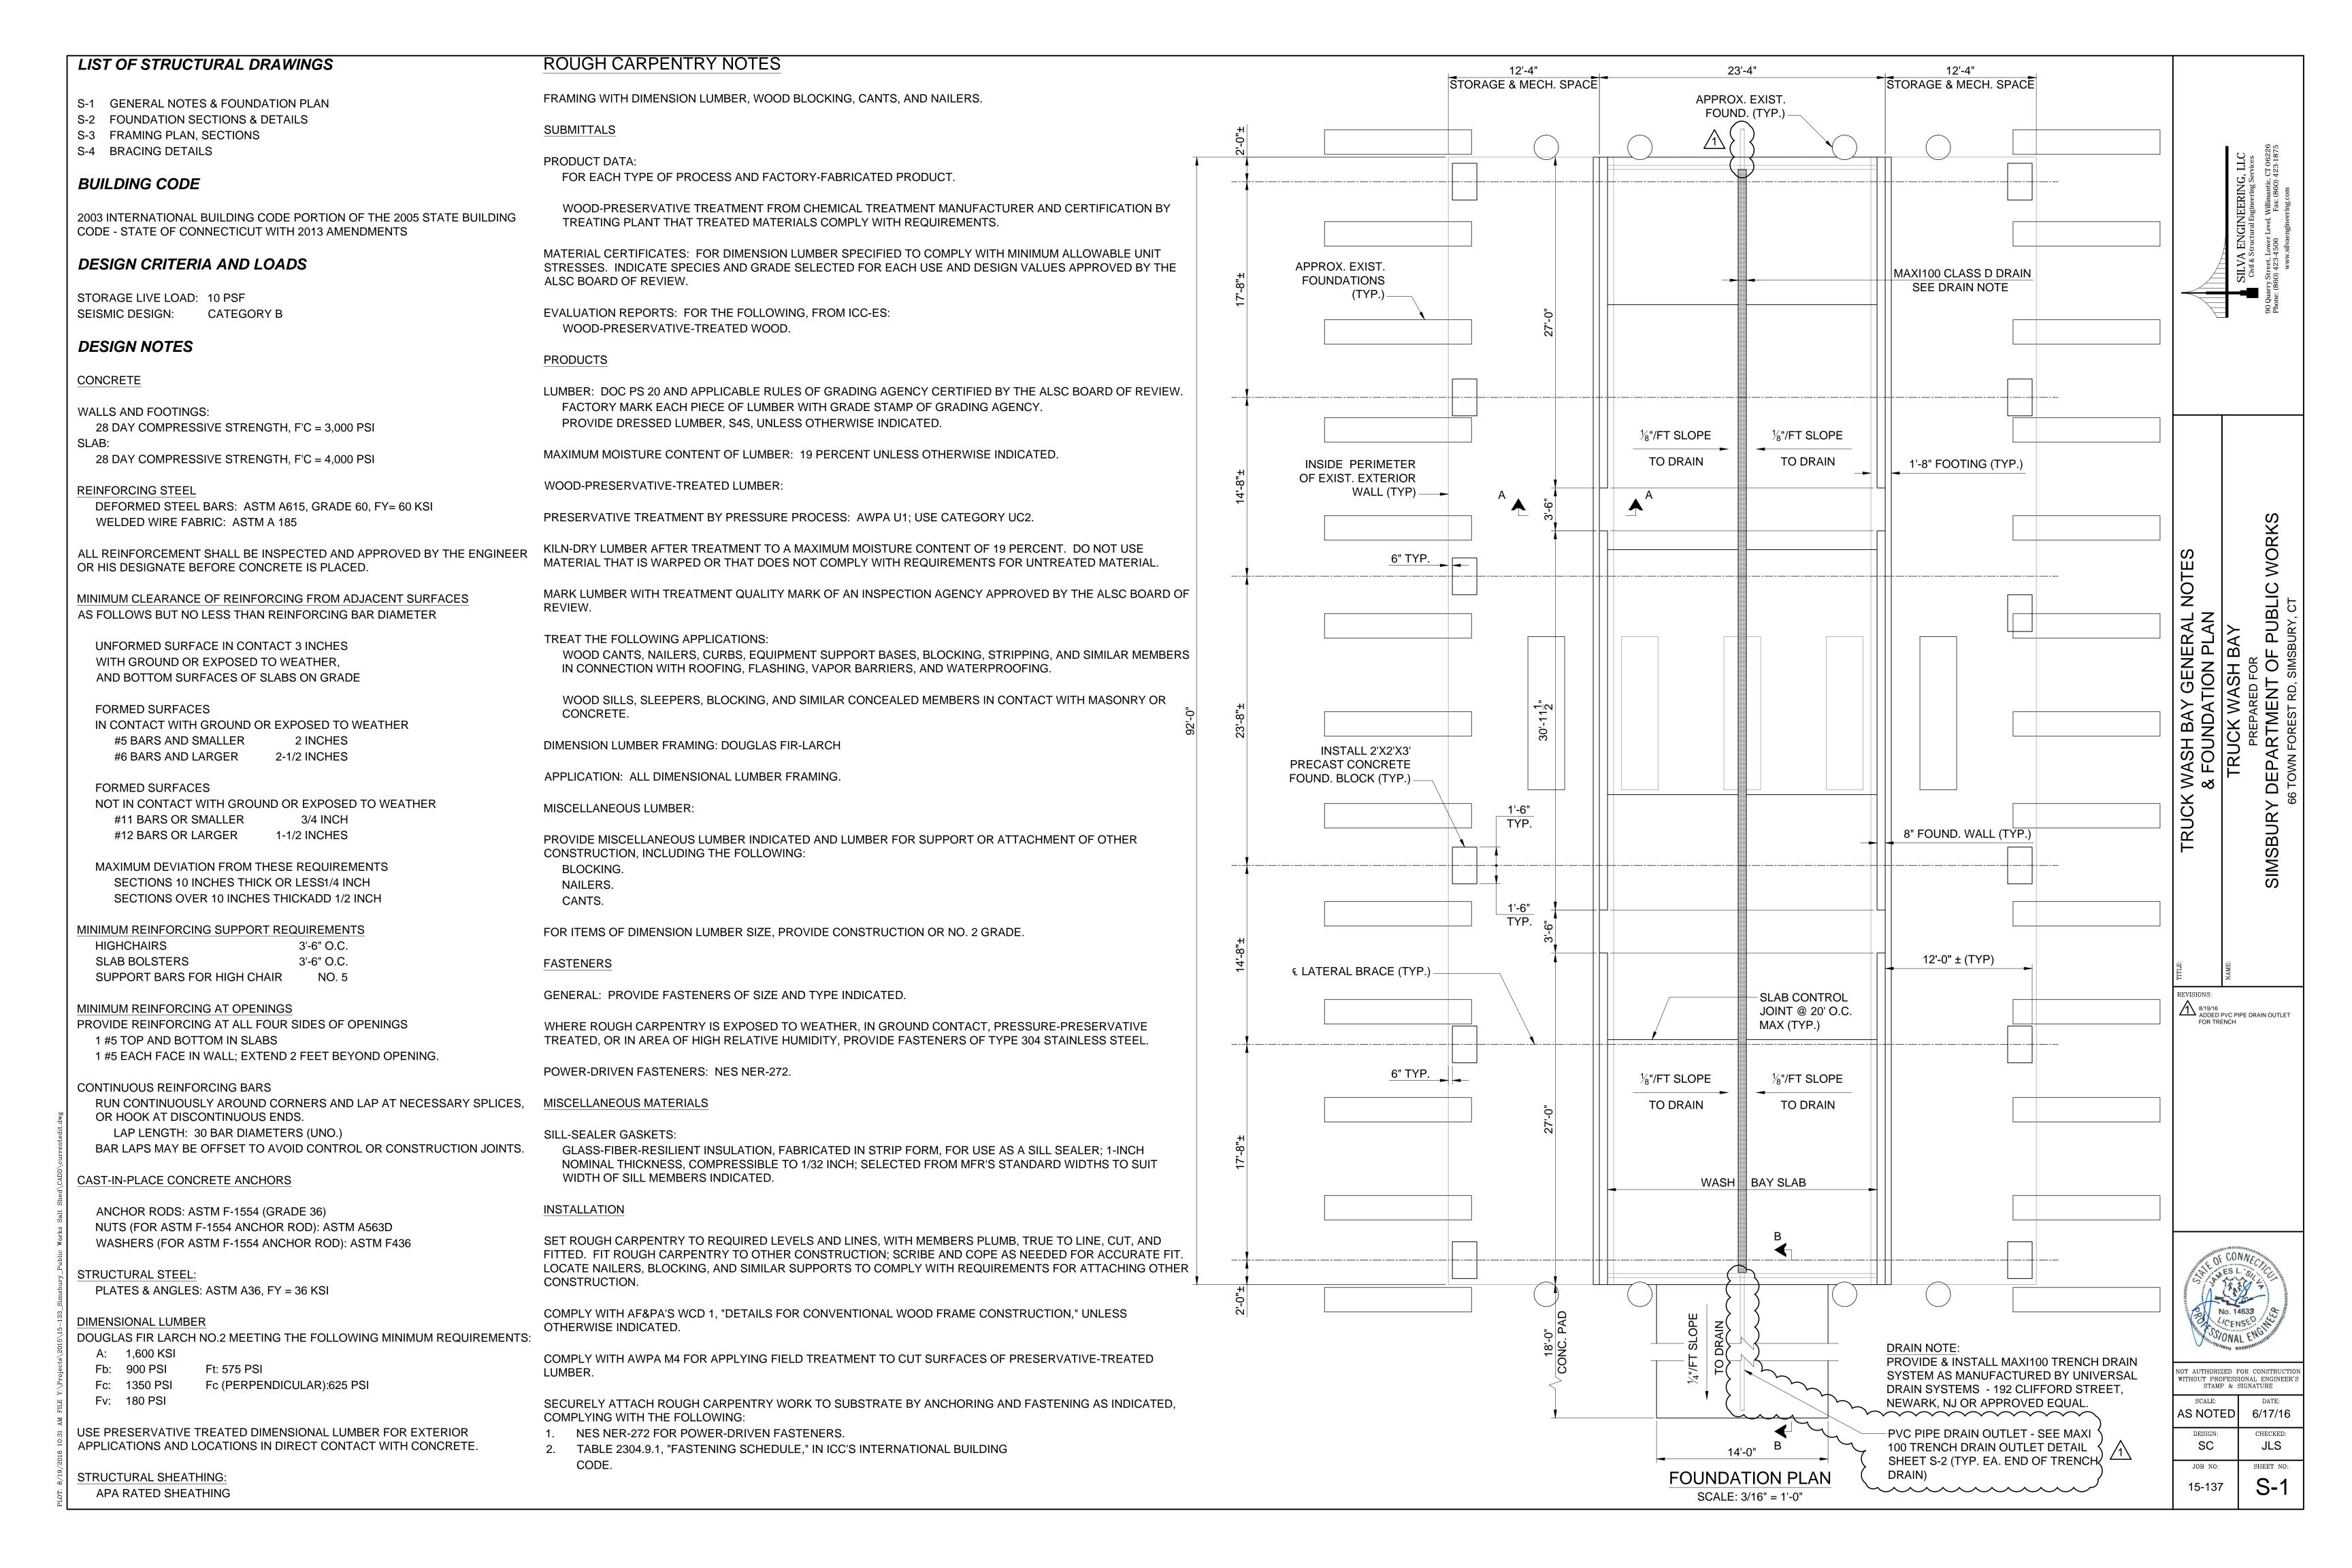


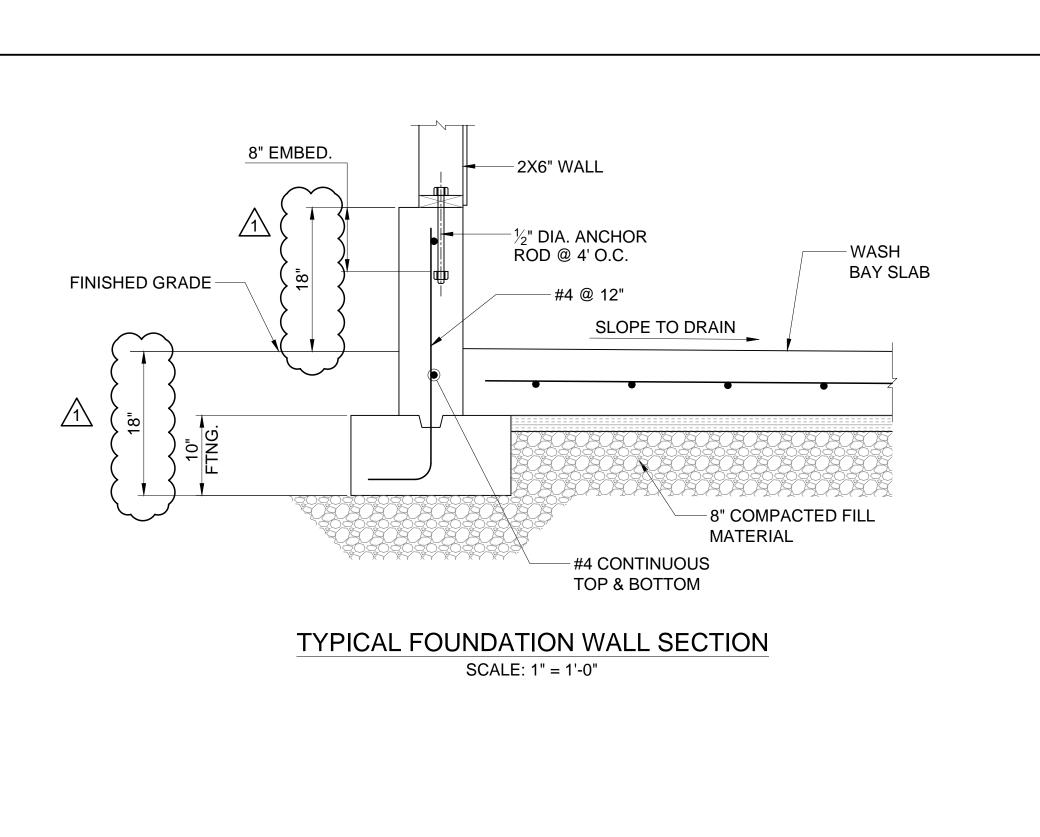


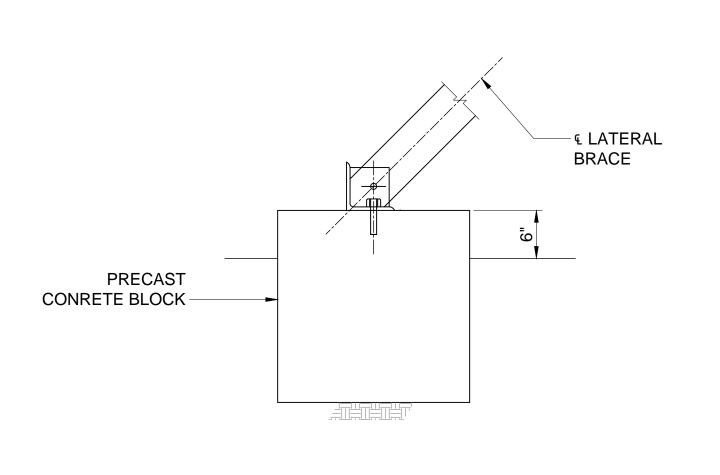

PRECAST CONCRETE FOUNDATION BLOCK

SCALE: 1" = 1'-0"

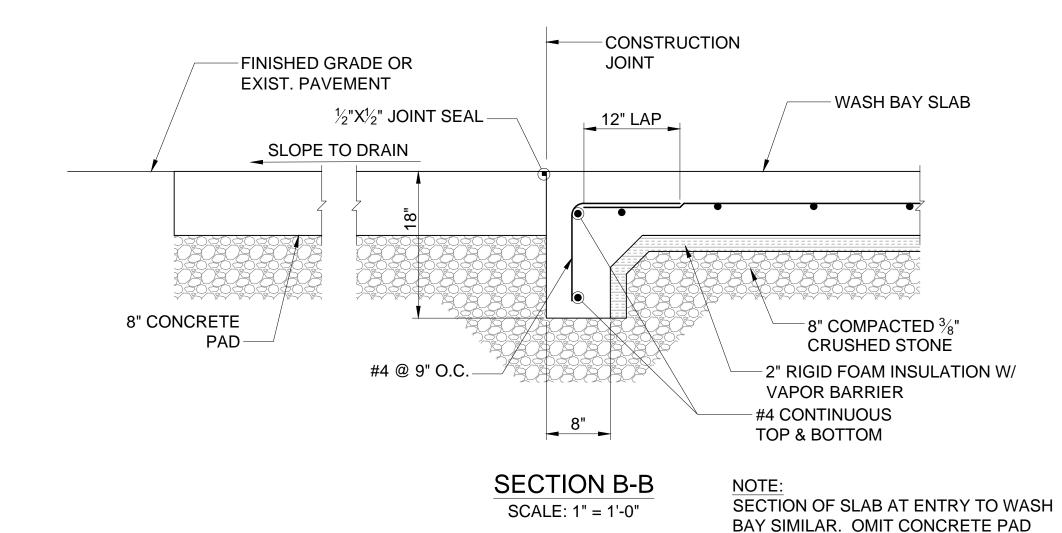

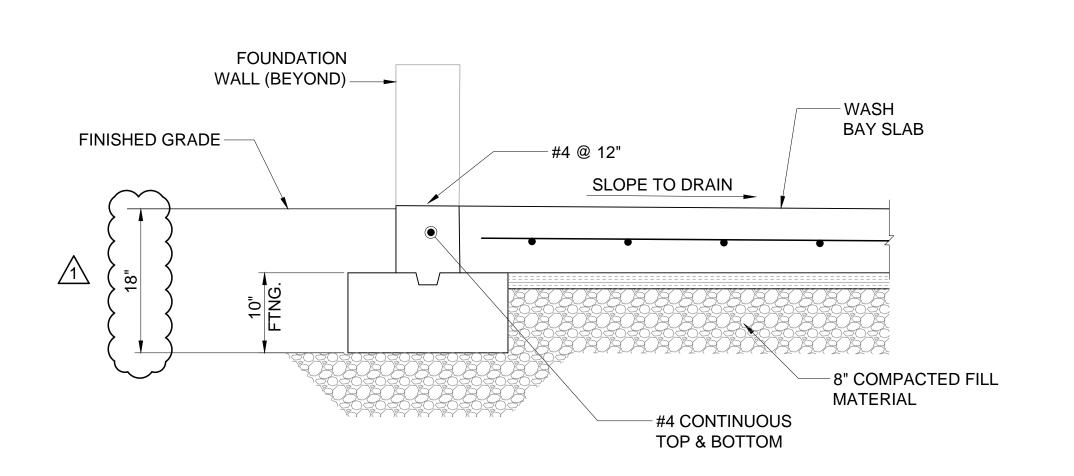

SECTION A-A (FOUND. AT DOORWAY) TYP.

SCALE: 1" = 1'-0"

NOTE:

CAMPACTED FILL MATERIAL SHALL CONSIST OF 8" OF 3/8"

CRUSHED WITHIN 5 FEET OF EACH END OF THE TRUCK WASH AND BELOW THE EXTERIOR CONCRETE PAD. FOR REMAINING INTERIOR PORTIONS OF THE FOUNDATION AND SLAB THE COMPACTED FILL SHALL CONSIST OF RECYCLED AGGREGATE SUPPLIED BY THE TOWN AND INSTALLED BY THE CONTRACTOR.

COMPACTION OF SOIL BACKFILLS


LAYER OF BACKFILL AT 95 PERCENT

PLACE BACKFILL MATERIALS IN LAYERS NOT MORE THAN 8 INCHES IN LOOSE DEPTH FOR MATERIAL COMPACTED BY HEAVY COMPACTION EQUIPMENT, AND NOT MORE THAN 4 INCHES IN LOOSE DEPTH FOR MATERIAL COMPACTED BY HAND-OPERATED TAMPERS.


PLACE BACKFILL EVENLY ON ALL SIDES OF STRUCTURES TO REQUIRED ELEVATIONS, AND UNIFORMLY ALONG THE FULL LENGTH OF EACH STRUCTURE.

COMPACT SOIL MATERIALS TO NOT LESS THAN THE FOLLOWING PERCENTAGES OF MAXIMUM DRY UNIT WEIGHT ACCORDING TO ASTM D1557:

UNDER STRUCTURES AND BUILDING SLABS: SCARIFY AND RECOMPACT TOP 12 INCHES OF EXISTING SUBGRADE AND EACH

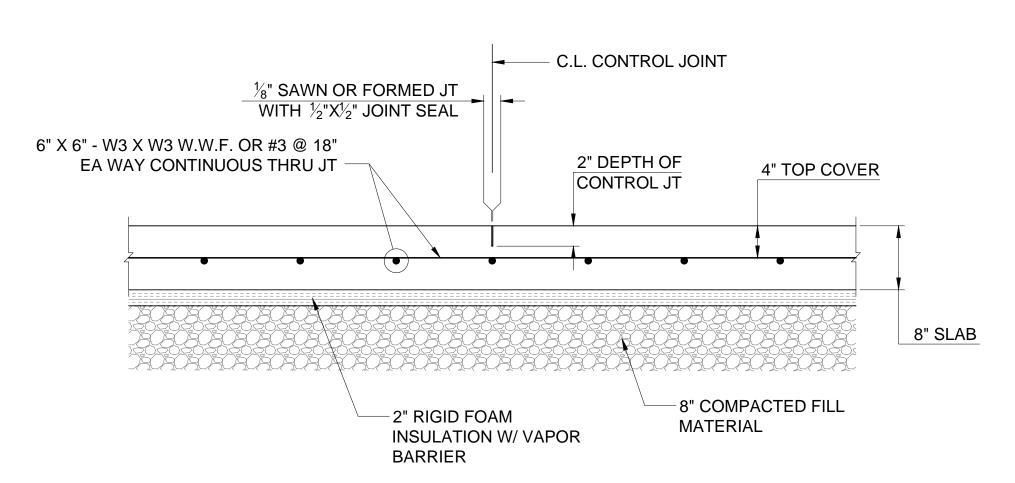

TYPICAL WASH BAY SLAB SECTION SCALE: 1" = 1'-0"

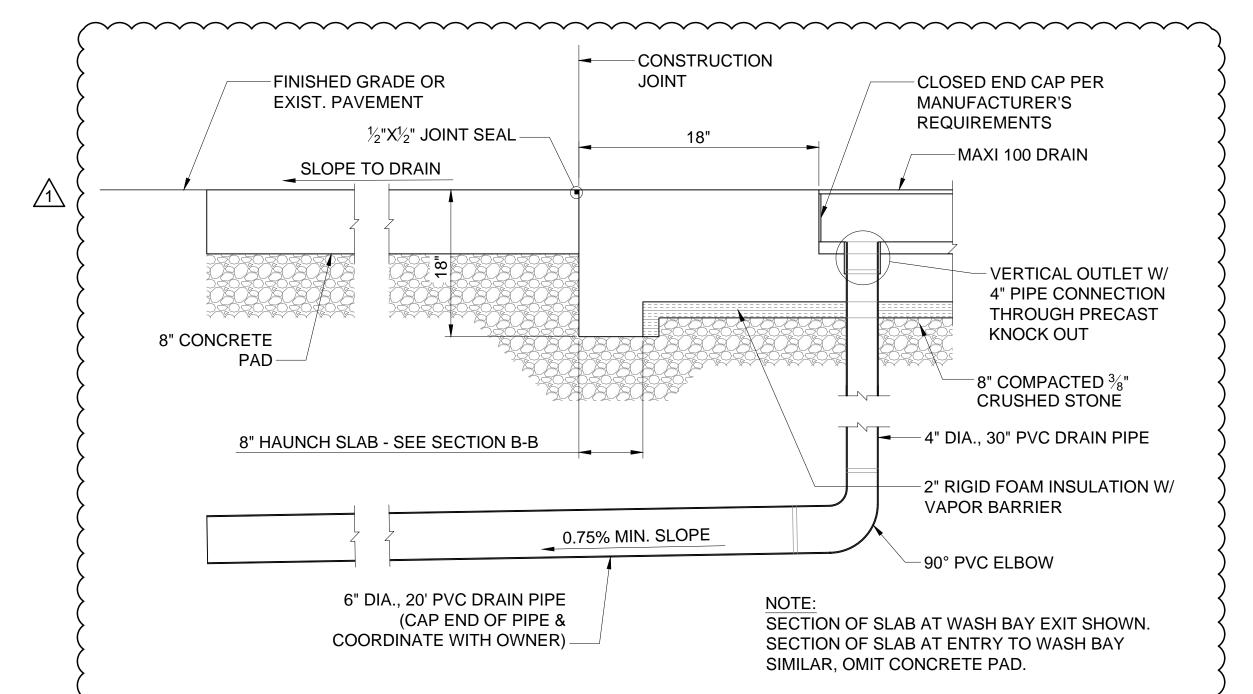

MAXI 100 TRENCH DRAIN OUTLET DETAIL

SCALE: 1" = 1'-0"





8/19/16
ADDED MAXI 100 TRENCH DRAIN
OUTLET DETAIL AND FTNG. DEPTH
DIMENSIONS (ADDENDUM NO.1)

WORKS

SIMSBUR


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SCALE: DATE:		
AS NOTED	6/17/16	
DESIGN:	CHECKED:	
SC	JLS	
JOB NO:	SHEET NO:	
15-137	S - 2	

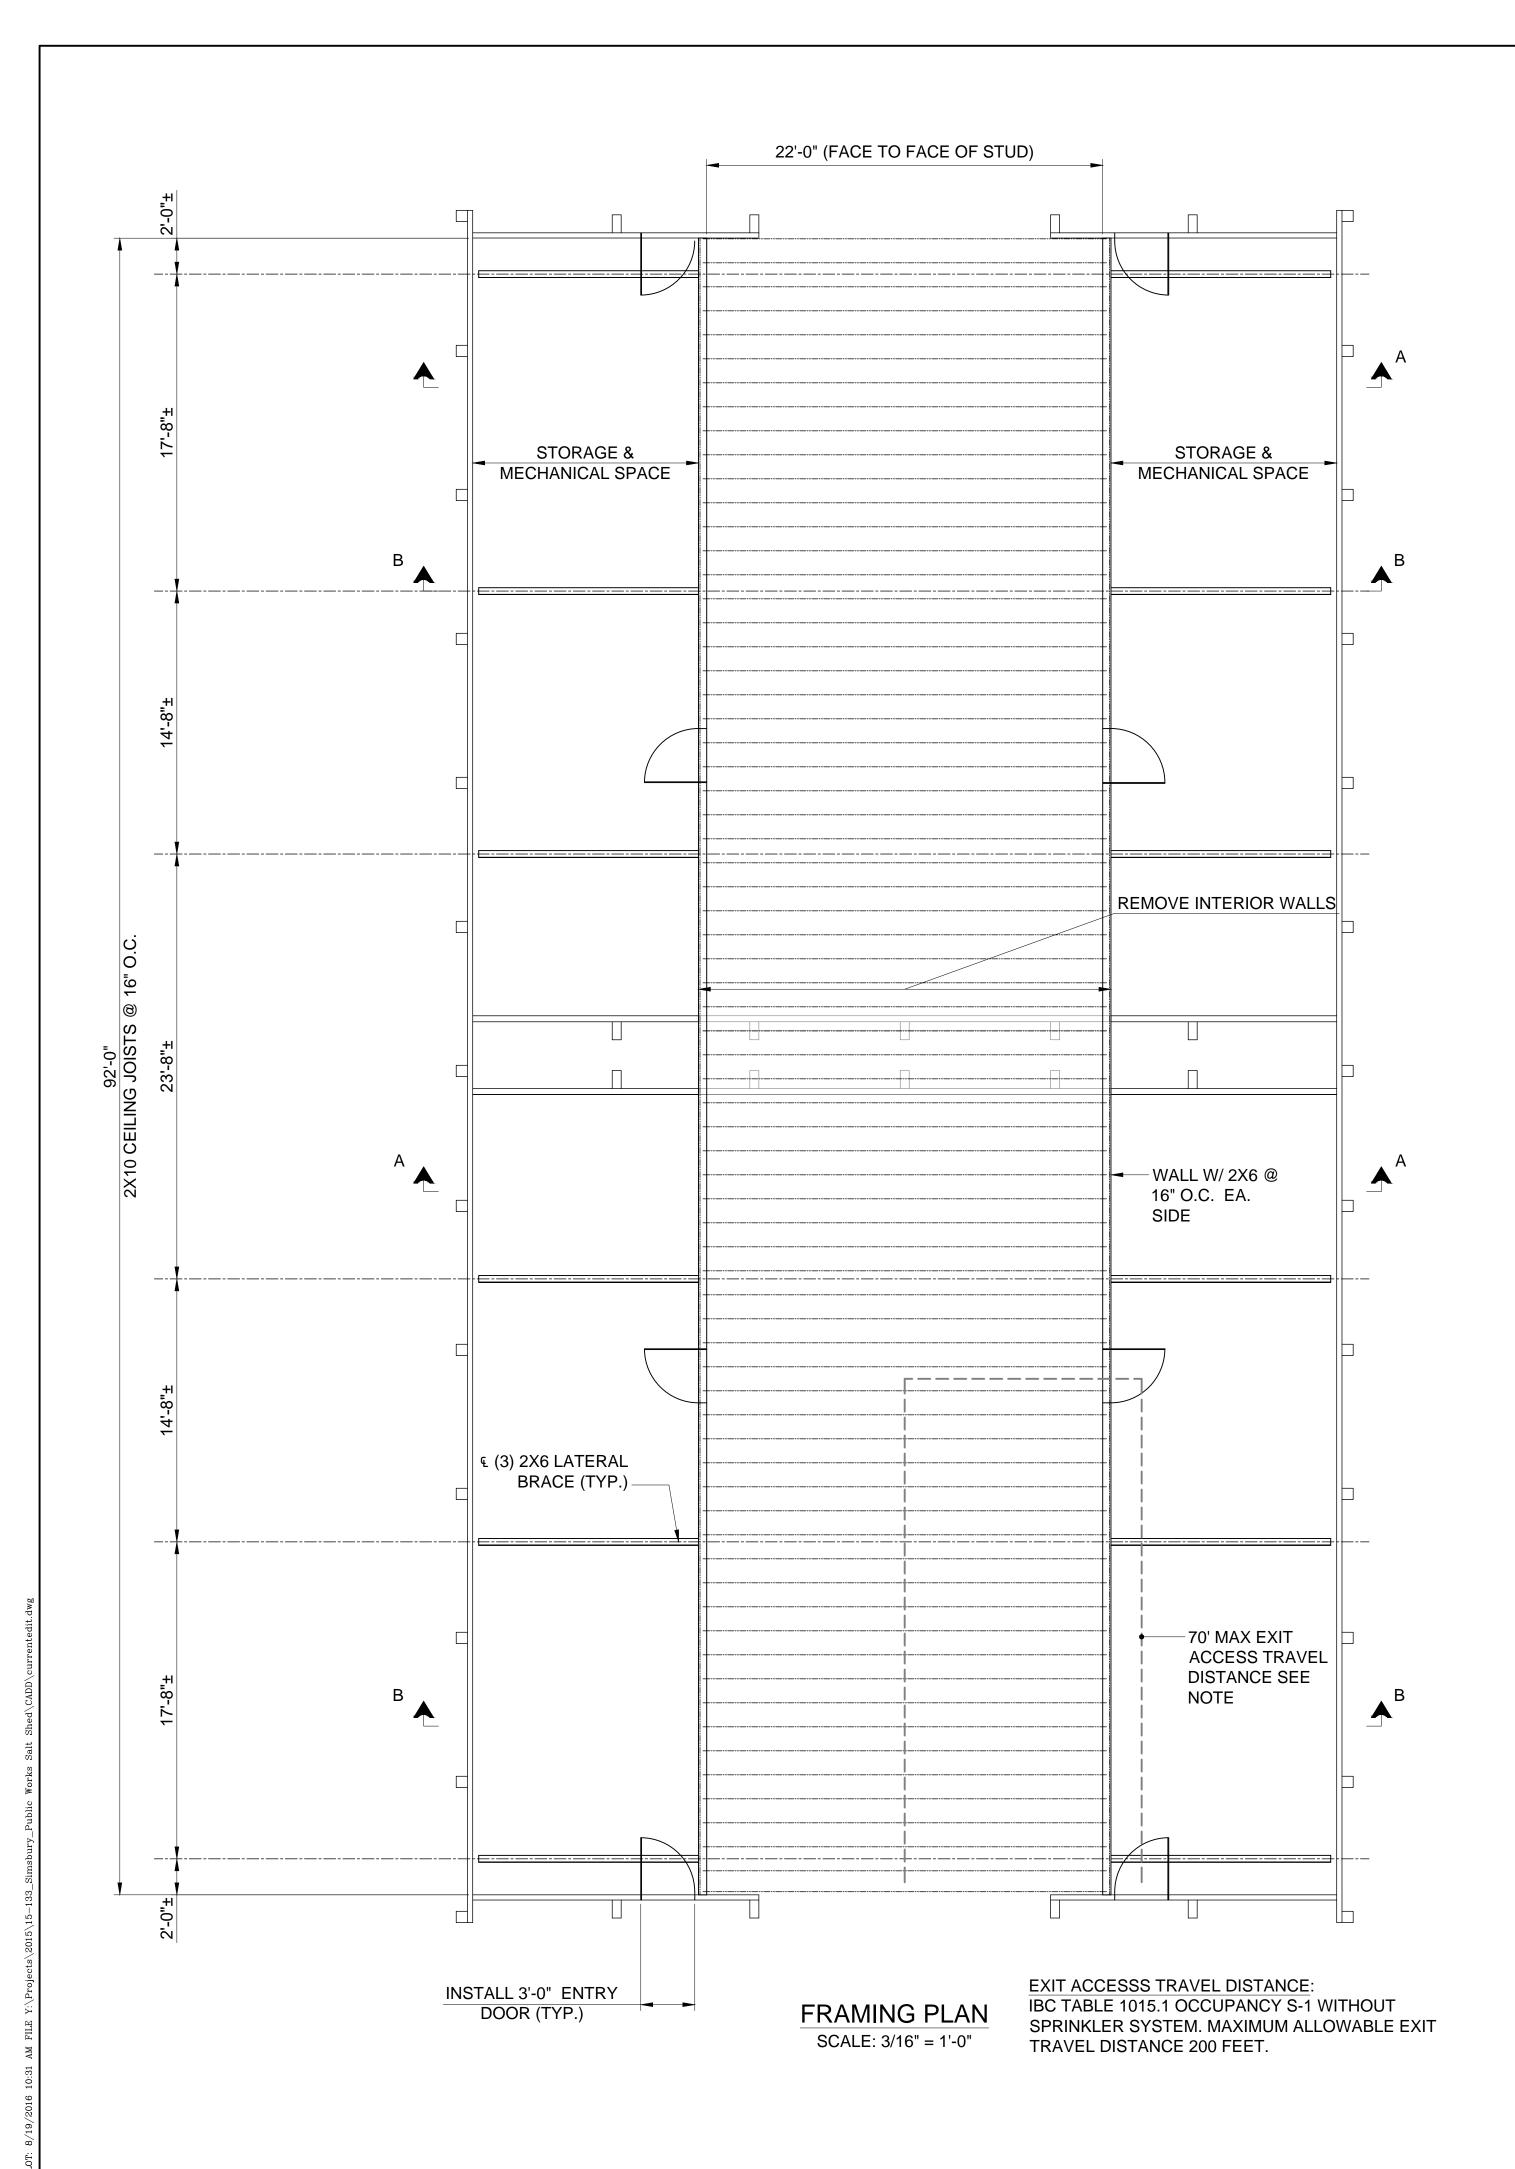

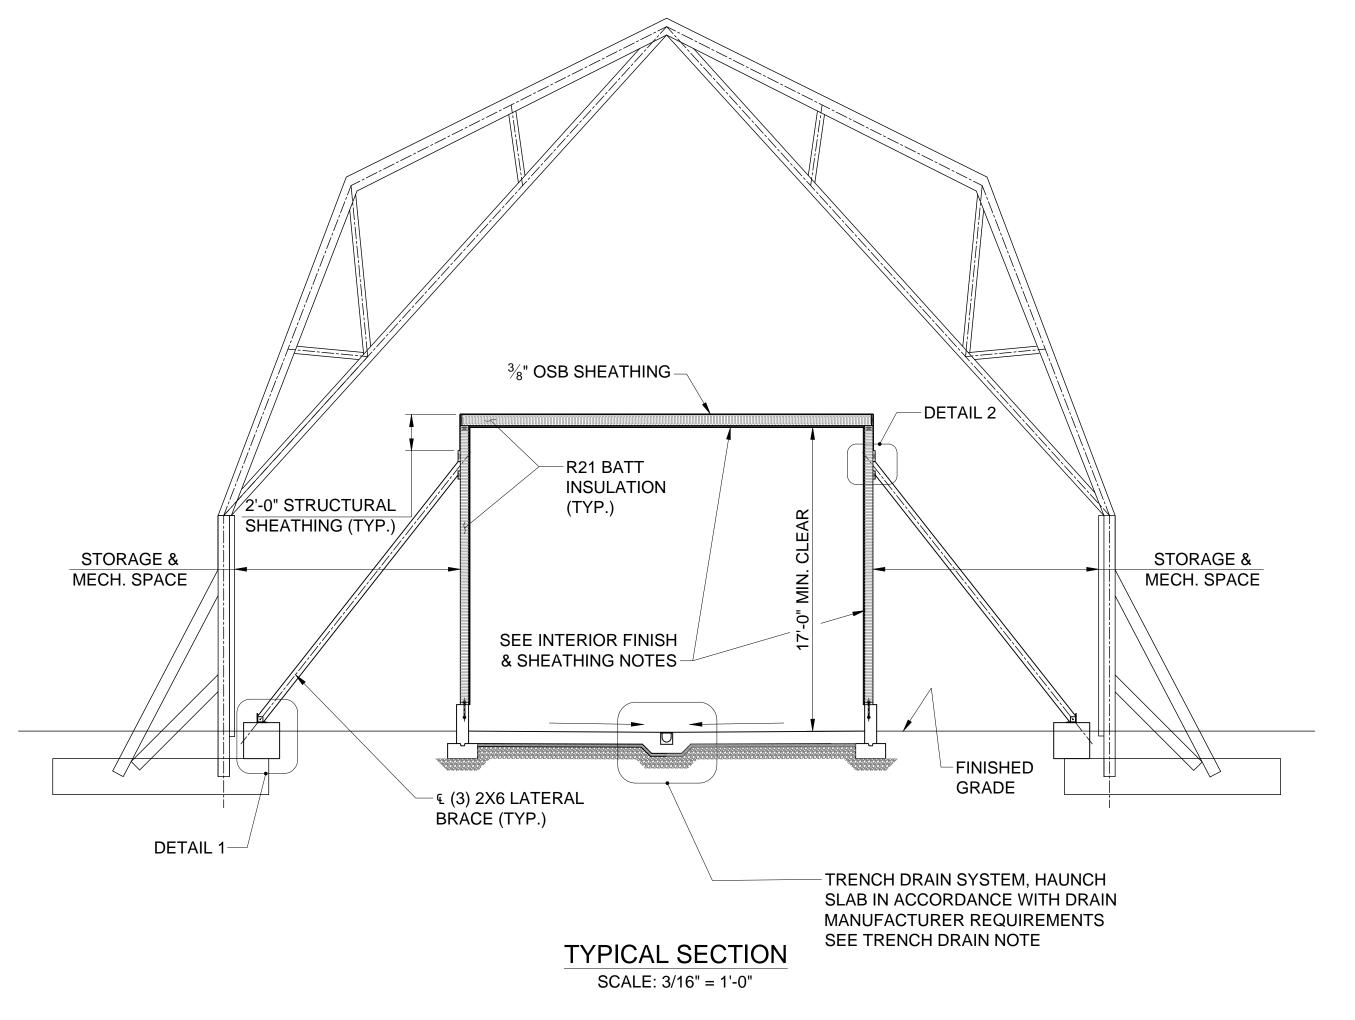


INTERIOR FINISH & SHEATHING NOTES:

- 1. INSTALL 3/8" ADVANTECH ZIP SYSTEM WALL SHEATHING OVER INTERIOR FACE OF WALL STUDS AND CEILING JOISTS. APPLY ADVANTECH TAPE TO ALL INTERIOR SHEATHING JOINTS.
- APPLY NUFORM RELINE PANEL SYSTEM TO INTERIOR FACE OF CEILINGS AND WALLS IN ACCORDANCE WITH MANUFACTURERS REQUIREMENTS.
- 3. SEE SPECIFICATIONS FOR ADDITIONAL REQUIREMENTS.

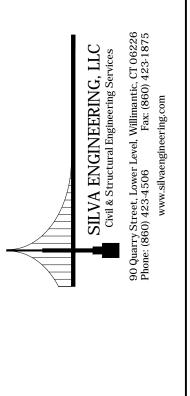



	FRAMING PLAN & SECTION	
AME:	TRUCK WASH BAY	
	PREPARED FOR	
	SIMSBURY DEPARTMENT OF PUBLIC WORKS	
	66 TOWN FOREST RD, SIMSBURY, CT	

REVISIONS:

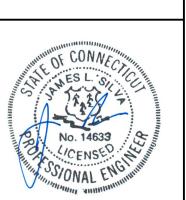


NOT AUTHORIZED FOR CONSTRUCTION WITHOUT PROFESSIONAL ENGINEER'S STAMP & SIGNATURE		
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707 110	OTTERM 110	
JOB NO:	SHEET NO:	
15-137	S - 3	

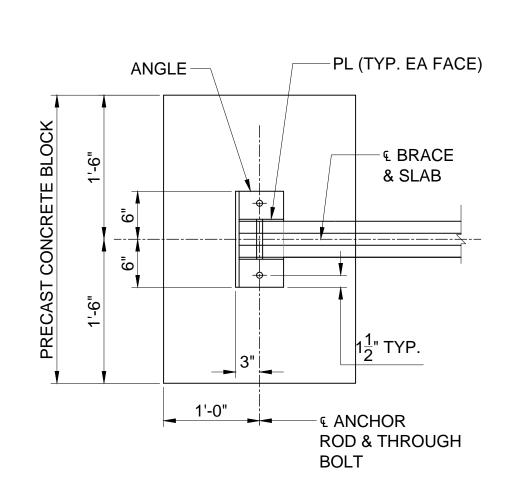


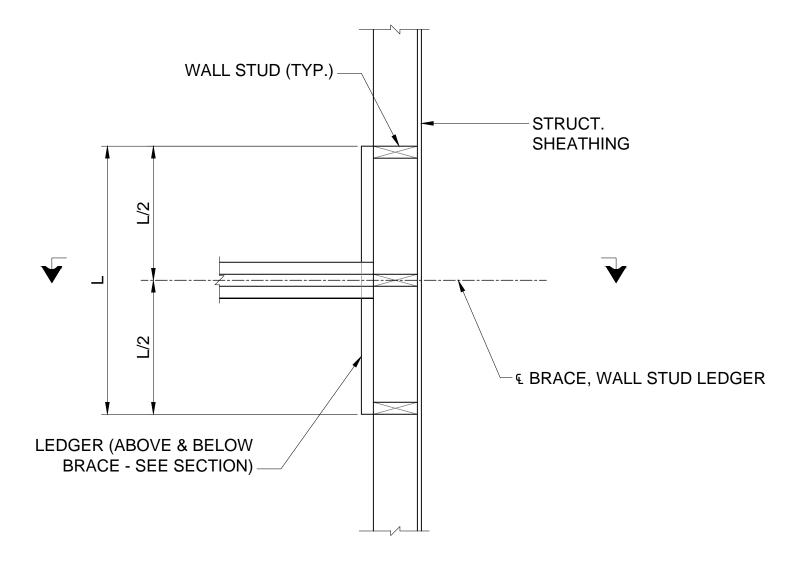

PLAN

PLAN

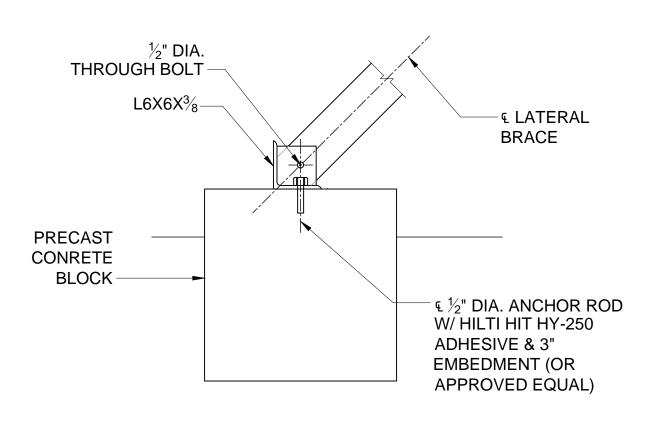


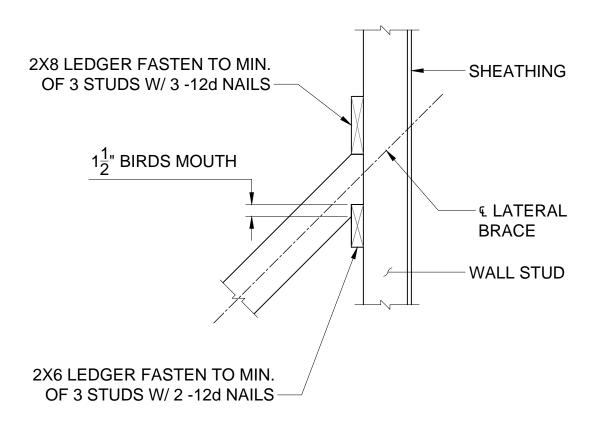

SECTION

DETAIL 1 SCALE: 3/16" = 1'-0" SECTION

DETAIL 2 SCALE: 3/16" = 1'-0"

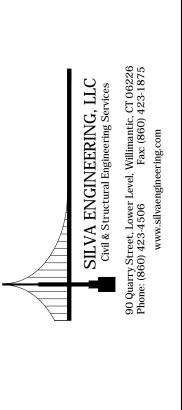

TRUCK WASH BAY	PREPARED FOR	SIMSBURY DEPARTMENT OF PUBLIC WORKS
TRUCK WASH	PREPARED FC	SIMSBURY DEPARTMENT (

No. 14633

No. 14633

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No. 14633

NOT AUTHORIZED FOR CONSTRUCTION WITHOUT PROFESSIONAL ENGINEER' STAMP & SIGNATURE				
SCALE:	DATE:			
AS NOTED	6/17/16			
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