


SITE DEVELOPMENT PLANS

VESSEL MULTI-FAMILY HOUSING

446 HOPMEADOW STREET, SIMSBURY, CT 06089


PREPARED FOR: VESSEL RE HOLDINGS, LLC

DATE: DECEMBER 16, 2022
 REVISED: FEBRUARY 24, 2023
 REVISED: MARCH 17, 2023

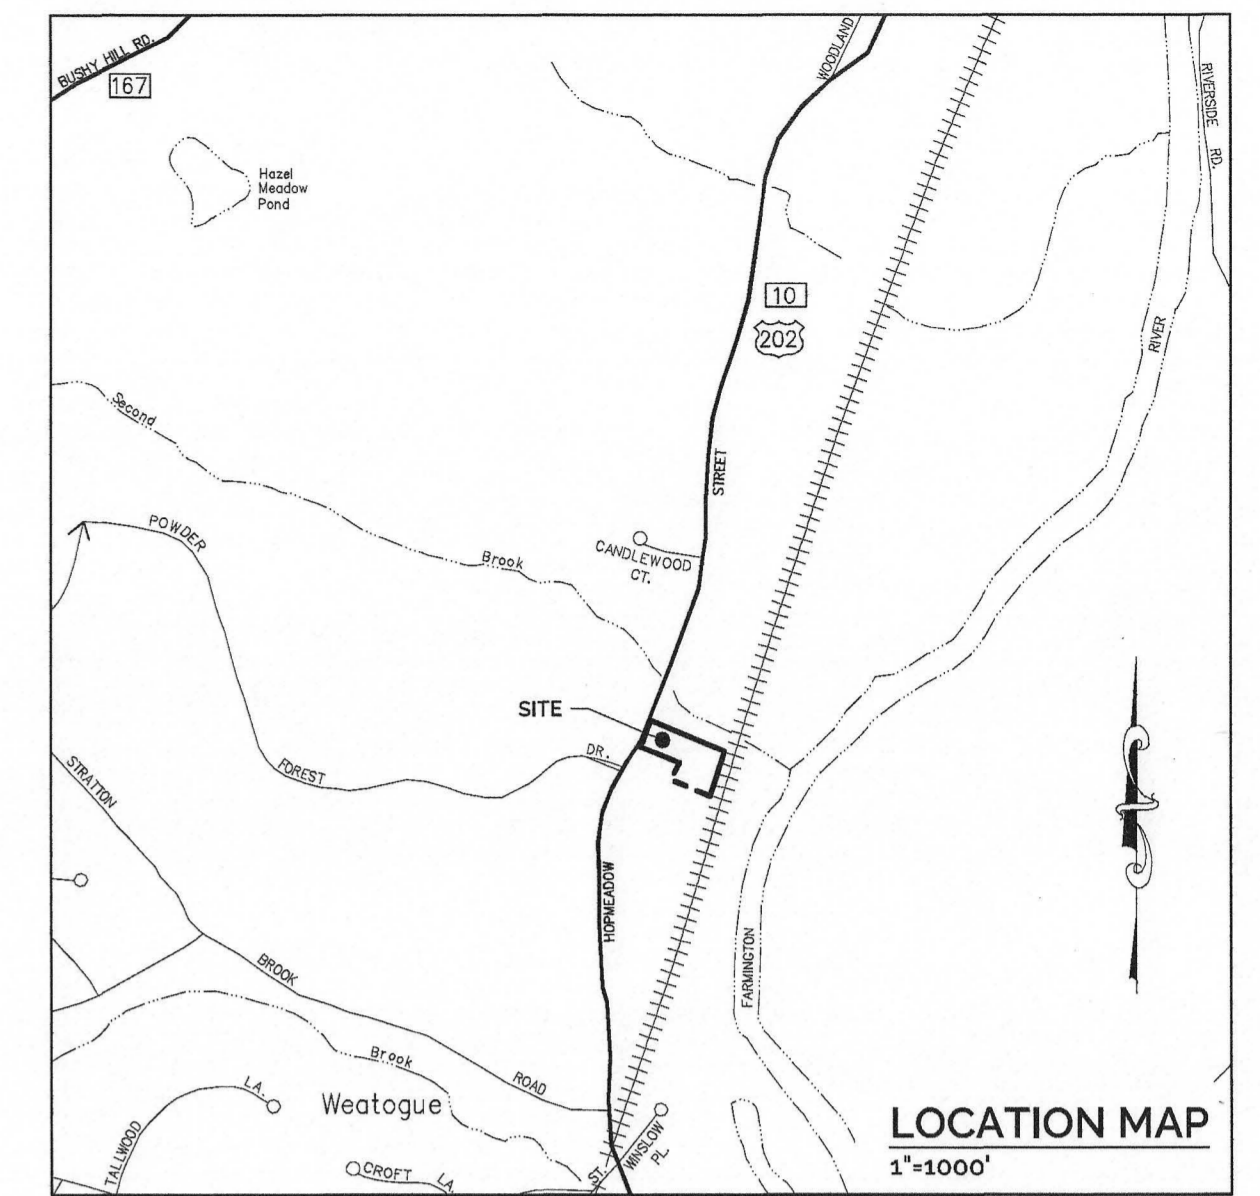

LEGEND

PROPERTY LINE	---
ADJOINER PROPERTY LINE	---
BUILDING SETBACK LINE	---
ZONE LINE	---
WATERCOURSE	---
INLAND WETLAND	---
100' INLAND WETLAND UPLAND REVIEW AREA	---
TREELINE	---
BRUSHLINE	---
GUIDERAIL	---
CHAINLINK FENCE	X-X
EX. INT. CONTOUR	-100
EX. INT. CONTOUR	99
PR. INT. CONTOUR	-100
PR. INT. CONTOUR	99
PR. SPOT GRADE	7.5
PR. SWALE	---
OVERHEAD ELECTRIC	OHE
UNDERGROUND ELECTRIC	UE
UNDERGROUND ELECTRIC, TELEPHONE, CABLE	ETC
SANITARY SEWER LINE	SAN
STORM PIPE	---
TELEPHONE LINE	TEL
WATER LINE	W
DOMESTIC WATER LINE	DW
FIRE PROTECTION LINE	FP
SILT FENCE	---
HAYBALES	---
TOP OF WALL	TW
BOTTOM OF WALL	BW
TOP OF CURB	TC
BOTTOM OF CURB	BC
UTILITY POLE	IP
IRON PIPE/IRON ROD	IP
BORING HOLES	B-2
TEST HOLES	TP-1

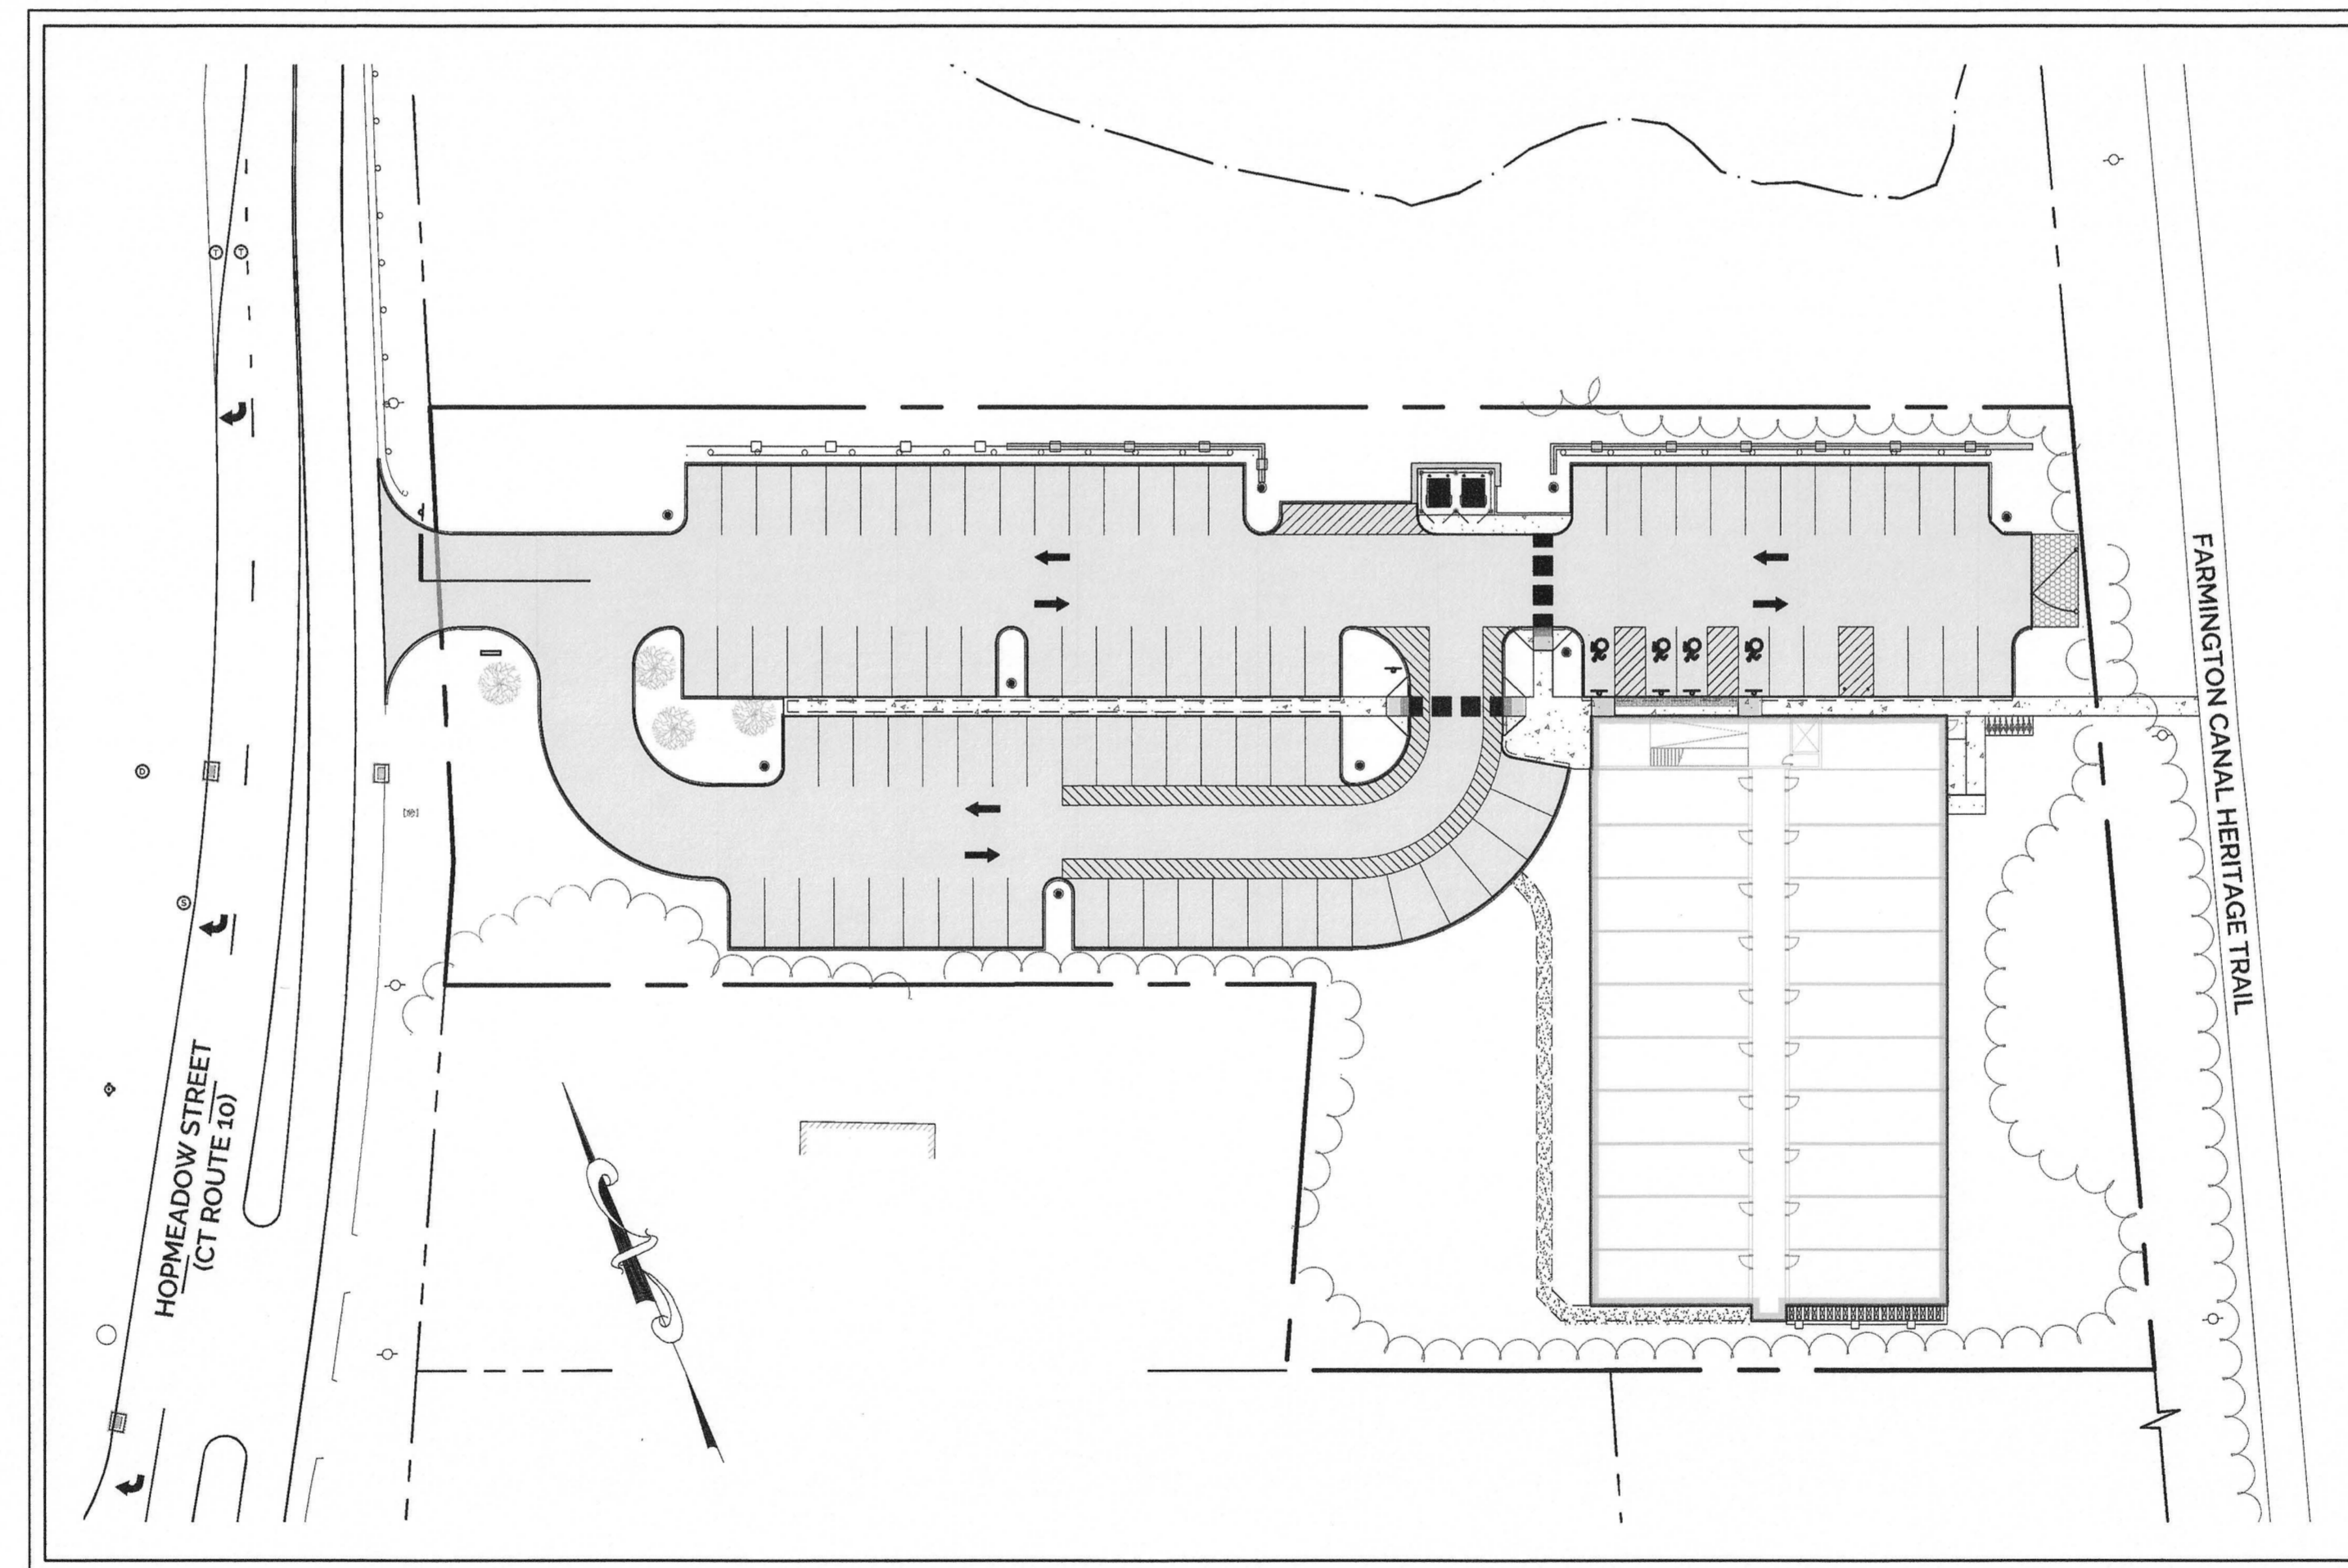

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APPLICANT:
 VESSEL RE HOLDINGS, LLC
 46 WEST 55TH STREET
 NEW YORK, NY 10019

PROPERTY OWNER:
 EAY PROPERTIES LLC
 540 HOPMEADOW STREET #6
 SIMSBURY, CT 06070

CIVIL ENGINEER:
 H+H ENGINEERING ASSOCIATES, LLC
 SEAMUS MORAN, P.E.
 232 GREENMANVILLE AVENUE, SUITE 201
 MYSTIC, CT 06355

LANDSCAPE ARCHITECT:
 THOMAS GRACEFFA LANDSCAPE ARCHITECT, LLC
 19 FLAG DRIVE
 MANCHESTER, CT 06040

LAND SURVEYOR:
 ROB HELLSTROM LAND SURVEYING LLC
 32 MAIN STREET
 HEBRON, CT 06248



PREPARED BY:
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GENERAL CONSTRUCTION NOTES:


1. THE CONTRACTOR SHALL CONTACT "CALL BEFORE YOU DIG" AT 800-922-4455 TO MARK OUT ALL UNDERGROUND UTILITIES A MINIMUM OF 3 BUSINESS DAYS PRIOR TO COMMENCING ANY CONSTRUCTION ACTIVITY. CONTRACTOR SHALL VERIFY ALL LOCATIONS, DIMENSIONS AND ELEVATIONS OF ALL UTILITIES PRIOR TO CONSTRUCTION. IF UTILITIES DIFFER FROM THOSE SHOWN ON THIS PLAN, ENGINEER SHALL BE NOTIFIED.
2. ALL PROPERTY LINES SHALL BE VERIFIED IN THE FIELD. NO PRIVATE PROPERTY SHALL BE DISTURBED UNLESS PROPER RIGHTS ARE OBTAINED PRIOR TO CONSTRUCTION.
3. THE CONTRACTOR SHALL OBTAIN ALL REQUIRED PERMITS PRIOR TO CONSTRUCTION.
4. THE CONTRACTOR SHALL OBTAIN, REVIEW AND ADHERE TO ALL REQUIREMENTS AND ANY CONDITIONS OF APPROVAL OF THE TOWN OF SIMSBURY.
5. EXISTING DRAINAGE PATTERNS SHALL BE SUBSTANTIALLY MAINTAINED. THE CONTRACTOR SHALL GRADE THE PROPERTY IN SUCH A MANNER TO MAINTAIN EXISTING LOCAL DRAINAGE PATTERNS AND TO PREVENT EXCESS RUNOFF AND/OR PONDING ON ADJACENT PROPERTIES BOTH DURING AND AFTER CONSTRUCTION.
6. A CONNECTICUT DEPARTMENT OF TRANSPORTATION HIGHWAY ENCROACHMENT PERMIT IS REQUIRED FOR ALL IMPROVEMENTS, INCLUDING BUT NOT LIMITED TO APRONS, CURB CUTS, UTILITY LATERALS AND ROADWAY PAVEMENT PATCHING, WITHIN THE STATE RIGHT-OF-WAY.

STAMP

REV	DESCRIPTION OF REVISION	DATE	APPR.
3	REVISIONS PER ENGINEERING REVIEW COMMENTS & IWA COMMENTS	3/30/2023	SHM
2	REVISIONS PER ENGINEERING REVIEW COMMENTS & IWA COMMENTS	3/17/2023	SHM
1	REVISIONS PER REVIEW COMMENTS	2/24/2023	SHM

EXISTING CONDITIONS & DEMOLITION PLAN


VESSEL MULTI-FAMILY HOUSING
PROPERTY ADDRESS
446 HOPMEADOW STREET, SIMSBURY, CT 06089
PREPARED FOR
VESSEL RE HOLDINGS, LLC
46 WEST 55TH STREET, NEW YORK, NY 10019

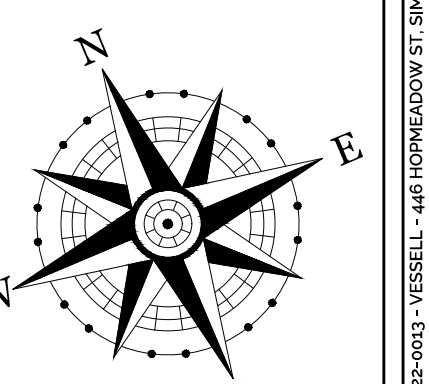

PROJECT NO. 2022-0013	SCALE 1" = 20'
DRAWN BY: SMM	DATE 12/16/2022
CHECKED BY: SMM	DATE 12/16/2022

DRAWING
XD-1

SHEET NUMBER: 1 OF 12

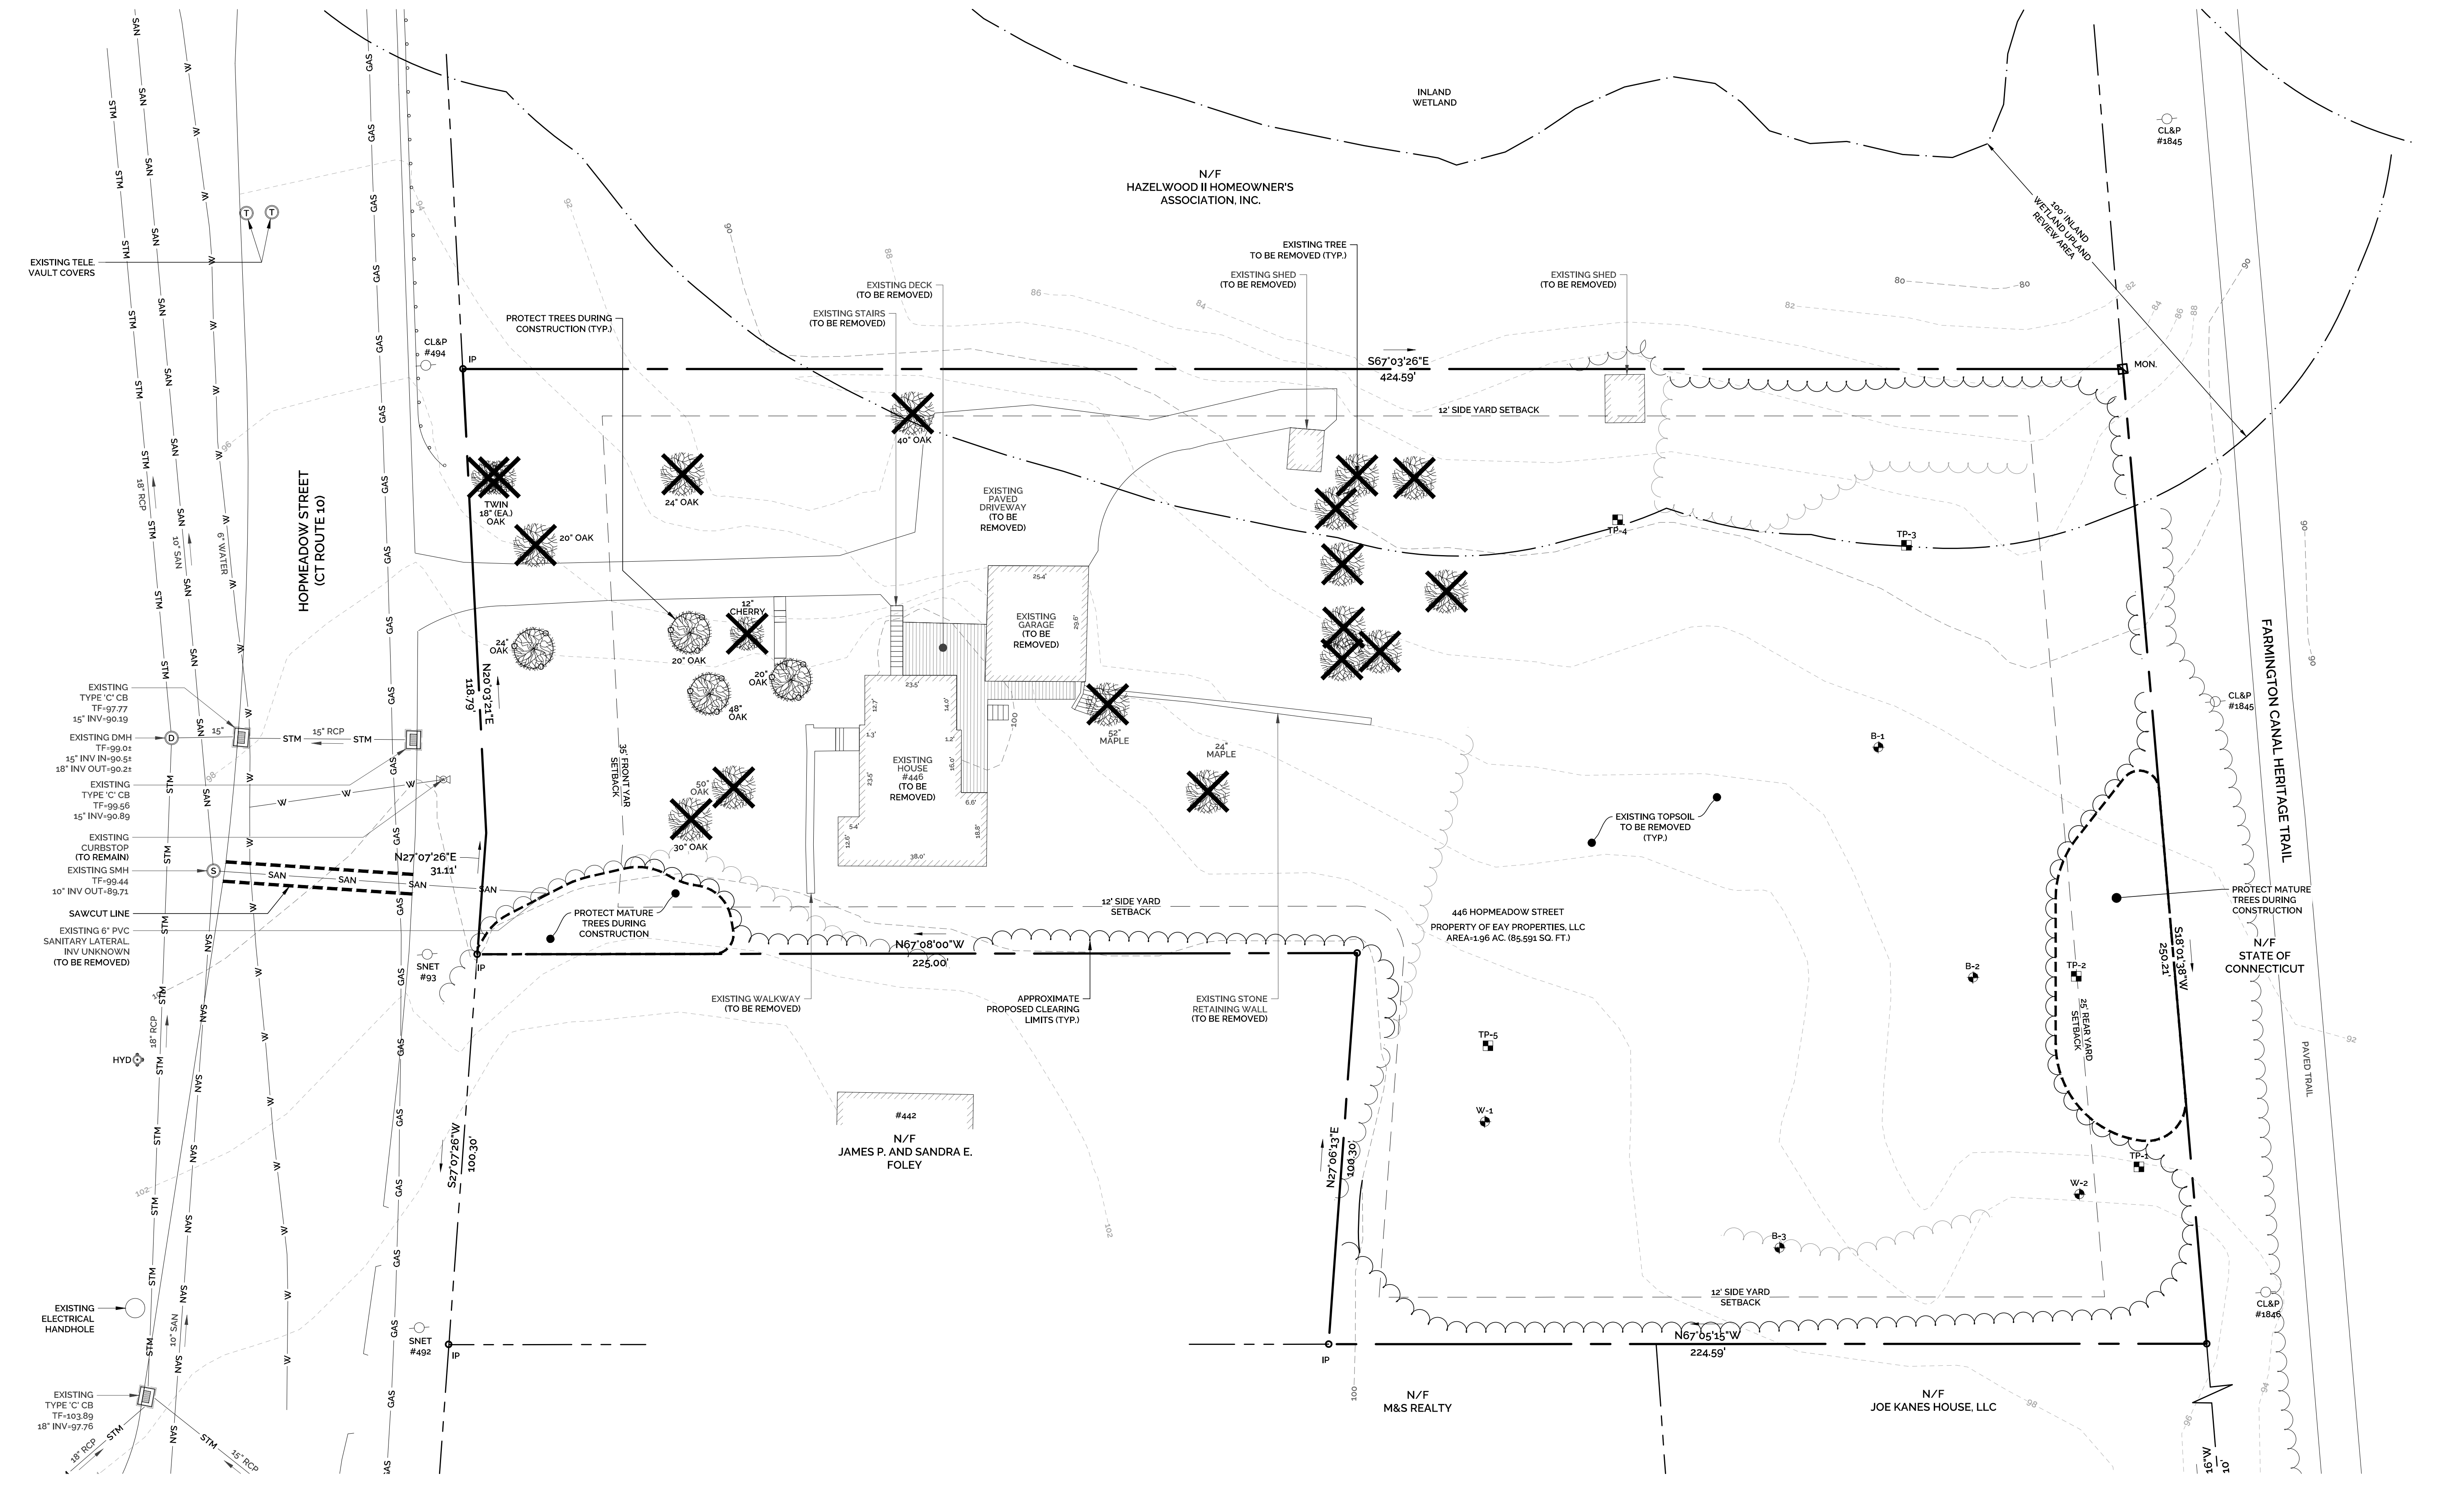

Z:\SIMSBURY\ENGINEERING ASSOCIATES\PROJECTS\2022\2022-0013 - VESSEL - 446 HOPMEADOW ST SIMSBURY\DWGS\06-DEMOL.DWG (Rev: DEMOL) Saved: 3/27/2023 1:31:04 PM Plotted: 3/27/2023 1:31:04 PM

- GENERAL NOTES:**
- THIS PLAN WAS COMPILED USING THE FOLLOWING REFERENCE INFORMATION:
 - A CLASS A-2 & CLASS T-2 SURVEY MAP ENTITLED, "PROPERTY SURVEY, PREPARED FOR VESSEL TECHNOLOGIES INC., 446 HOPMEADOW STREET, SIMSBURY, CONNECTICUT," SCALE: 1"=30', DATED: NOVEMBER 9, 2022, PREPARED BY ROB HELLSTROM LAND SURVEYING, LLC
 - A MAP ENTITLED, "TOWN OF SIMSBURY, CONNECTICUT TOWN ACAD WETLAND MAP 2014, MAP G13," SCALE: 1"=100', PREPARED BY NEW ENGLAND GEOSYSTEMS.
 - THE APPLICANT IS VESSEL TECHNOLOGIES INC. OF 46 WEST 55TH STREET, NEW YORK, NY 10019. THE PROPERTY OWNER IS EAV PROPERTIES LLC OF 540 HOPMEADOW STREET #6, SIMSBURY, CT 06091.
 - THE SUBJECT PARCEL IS IDENTIFIED AS LOT 00C3 ON TAX ASSESSORS MAP G13, BLOCK 142. THE DEED REFERENCE OF THE PROPERTY IS VOLUME 882 PAGE 222. THE AREA OF THE PARCEL IS 85,591 SQ. FT. (1.961 ACRES).
 - THE SUBJECT PROPERTY IS LOCATED IN THE HIGH DENSITY RESIDENTIAL 'R-15' ZONING DISTRICT.
 - THE EXISTING PARCEL IS DEVELOPED AS A SINGLE-FAMILY RESIDENCE. THE APPLICANT IS PROPOSING TO DEMOLISH THE EXISTING BUILDING AND IMPROVEMENTS AND CONSTRUCT A NEW FOUR-STORY, 14,063 SQ. FT. MULTI-FAMILY RESIDENTIAL BUILDING, CONSISTING OF 77 ONE-BEDROOM UNITS AND 3 TWO-BEDROOM UNITS FOR A TOTAL OF 80 UNITS. SITE IMPROVEMENTS WILL INCLUDE A NEW TWO-WAY ACCESS DRIVE FROM HOPMEADOW ROAD (CT ROUTE 10). A NEW 95 VEHICLE PARKING LOT, NEW UTILITY CONNECTIONS, NEW LANDSCAPING IMPROVEMENTS, AND A NEW STORMWATER MANAGEMENT SYSTEM. THE DEVELOPMENT IS BEING PROPOSED IN ACCORDANCE WITH GENERAL STATUTES 8-30G.
 - THE PURPOSE OF THESE PLANS IS FOR REVIEW BY THE TOWN OF SIMSBURY INLAND WETLANDS & WATERCOURSES COMMISSION FOR A WETLANDS PERMIT, THE TOWN OF SIMSBURY PLANNING & ZONING COMMISSION FOR A SITE PLAN APPLICATION, AND THE CONNECTICUT DEPARTMENT OF TRANSPORTATION FOR WORK WITHIN THE CT ROUTE 10 RIGHT-OF-WAY. THESE PLANS ARE FOR PERMIT PURPOSES ONLY AND ARE NOT TO BE USED FOR CONTRACT DOCUMENTS.
 - REFER TO ARCHITECTURAL DRAWINGS FOR PROPOSED BUILDING INFORMATION.

- SITE NOTES:**
- ALL SITE LIGHTING SHALL BE FULL CUT OFF FIXTURES AND ARRANGED TO MINIMIZE GLARE BEYOND PROPERTY BOUNDARY AND SHALL PROVIDE ADEQUATE GROUND LEVEL ILLUMINATION FOR SAFE VEHICULAR AND PEDESTRIAN CIRCULATION.
 - ALL WORK TO CONFORM TO THE TOWN OF SIMSBURY, CT CONSTRUCTION STANDARDS.
 - ALL TRAFFIC CONTROL SIGNS AND PAVEMENT MARKINGS SHALL BE INSTALLED IN THE LOCATIONS SHOWN AND IN ACCORDANCE WITH THE MANUAL FOR UNIFORM TRAFFIC CONTROL DEVICES (M.U.T.C.D.). ALL PARKING LOT STRIPING (EXCEPT FIRE LANE MARKINGS) SHALL BE INSTALLED WITH DURABLE WHITE PAVEMENT MARKING PAINT. THE HANDICAP PARKING SYMBOLS SHALL BE WHITE WITH STANDARD HANDICAP BLUE BACKGROUNDS.
 - FIRE LANES SHALL BE INSTALLED AND MAINTAINED IN ACCORDANCE WITH TOWN OF SIMSBURY FIRE DEPARTMENT.
 - ALL DISTURBED AREAS NOT COVERED BY BUILDINGS, ASPHALT, STONE SURFACE OR WALKS SHALL BE LANDSCAPED OR GRASSED. GRASSED AREAS SHALL BE LOAMED (4" MIN) FERTILIZED, SEEDED AND MULCHED AS REQUIRED TO SUIT SOIL CONDITIONS.
 - ANY AND ALL SIGNAGE SHALL BE REVIEWED AND APPROVED BY THE TOWN PLANNER/ZONING OFFICIAL AND/OR PLANNING & ZONING COMMISSION PRIOR TO INSTALLATION. NO UNAPPROVED SIGNAGE SHALL BE PLACED ON LIGHT POLES, BUILDINGS, OR GROUNDS SUBJECT TO THIS APPROVAL.
 - TRASH COLLECTION SHALL BE LIMITED TO 7:00 A.M. TO 6:00 P.M. MONDAY THROUGH FRIDAY.
 - HOURS OF CONSTRUCTION SHALL BE LIMITED TO 7:00 A.M. TO 6:00 P.M. MONDAY THROUGH FRIDAY, AND 8:00 A.M. TO 6:00 P.M. SATURDAY. NO CONSTRUCTION ACTIVITY SHALL TAKE PLACE ON SUNDAYS. ADDITIONALLY, NO EXTERIOR LIGHTING FOR CONSTRUCTION PURPOSES, FREESTANDING OR OTHERWISE, IS APPROVED WITH THIS APPLICATION.
 - DELIVERIES OF MATERIALS/EQUIPMENT TO THE SITE RELATED TO THIS CONSTRUCTION PROJECT ARE LIMITED TO 7:00 A.M. TO 5:00 P.M. MONDAY TO SATURDAY.
 - PRIOR TO ISSUANCE OF A CERTIFICATE OF OCCUPANCY, AN AS-BUILT DRAWING SHALL BE SUBMITTED FOR THE FILE.
 - SNOW STORAGE AREAS ARE INDICATED ON THE PLAN. DURING LARGE STORM EVENTS, UP TO 11 TOTAL PARKING SPACES MAY BE USED FOR SNOW STORAGE (10 SHOWN). HOWEVER, AT NO POINT SHALL THE MINIMUM NUMBER OF AVAILABLE PARKING SPACES BE REDUCED TO LESS THAN THE MINIMUM REQUIRED 83 PARKING SPACES (SEE ZONING NOTE #2).
- IN THE EVENT THAT SURPLUS SNOW CANNOT BE STORED ON SITE IN THE DESIGNATED AREAS, THE SURPLUS SNOW SHALL BE REMOVED FROM THE SITE AND STOCKPILED AT AN APPROVED LOCATION IN ACCORDANCE WITH ANY AND ALL APPLICABLE LAWS AND REGULATIONS. ANY PLANTINGS DAMAGED DURING ON-SITE SNOW STOCKPILING SHALL BE REPLACED IN KIND.
REFER TO SNOW STORAGE TABLE BELOW FOR STORAGE DEPTH CALCULATIONS.

- GENERAL CONSTRUCTION NOTES:**
- THE CONTRACTOR SHALL CONTACT "CALL BEFORE YOU DIG" AT 800-922-4455 TO MARK OUT ALL UNDERGROUND UTILITIES A MINIMUM OF 3 BUSINESS DAYS PRIOR TO COMMENCING ANY CONSTRUCTION ACTIVITY. CONTRACTOR SHALL VERIFY ALL LOCATIONS, DIMENSIONS AND ELEVATIONS OF ALL UTILITIES PRIOR TO CONSTRUCTION. IF UTILITIES DIFFER FROM THOSE SHOWN ON THIS PLAN, ENGINEER SHALL BE NOTIFIED.
 - ALL PROPERTY LINES SHALL BE VERIFIED IN THE FIELD. NO PRIVATE PROPERTY SHALL BE DISTURBED UNLESS PROPER RIGHTS ARE OBTAINED PRIOR TO CONSTRUCTION.
 - THE CONTRACTOR SHALL OBTAIN ALL REQUIRED PERMITS PRIOR TO CONSTRUCTION.
 - THE CONTRACTOR SHALL OBTAIN, REVIEW AND ADHERE TO ALL REQUIREMENTS AND ANY CONDITIONS OF APPROVAL OF THE TOWN OF SIMSBURY.
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 - A CONNECTICUT DEPARTMENT OF TRANSPORTATION HIGHWAY ENCROACHMENT PERMIT IS REQUIRED FOR ALL IMPROVEMENTS, INCLUDING BUT NOT LIMITED TO APRONS, CURB CUTS, UTILITY LATERALS AND ROADWAY PAVEMENT PATCHING, WITHIN THE STATE RIGHT-OF-WAY.

SNOW STORAGE TABLE			
SNOWFALL DEPTH (INCHES)	"IN PLACE" SNOW VOLUME (CUBIC FEET)	50% COMPACTED SNOW VOLUME (CUBIC FEET)	STORAGE DEPTH (INCHES/FEET)
1	2,842	1,421	(3.3 / 0.28)
3	8,524	4,262	(10.0 / 0.83)
6	17,047	8,524	(20.0 / 1.66)
9	25,571	12,785	(29.9 / 2.49)
12	34,094	17,047	(39.9 / 3.33)
18	51,141	25,571	(59.9 / 4.99)

- NOTES:**
- SNOW REMOVAL AREA (PARKING LOT) - 34,094 SQ. FT.
 - SNOW STORAGE AREAS - 570 SQ. FT. + 265 SQ. FT. + 1,030 SQ. FT. + 230 SQ. FT. + 2,240 SQ. FT. + 690 SQ. FT. - 5,125 SQ. FT.

- ZONING NOTES:**
- PER SECTION 17.4 OF THE SIMSBURY ZONING REGULATIONS, MAXIMUM BUILDING HEIGHT IS MEASURED FROM THE AVERAGE FINISHED GRADE AT THE PERIMETER OF THE BUILDING TO THE HIGHEST POINT OF THE BUILDING.
 - THE ELEVATION OF THE AVERAGE FINISHED GRADE AT THE PERIMETER OF THE BUILDING IS 94.2'
 - THE ELEVATION OF THE TOP OF THE PARAPET IS 94.0' (ENTRY ELEVATION) + 42.75' (HEIGHT TO TOP OF PARAPET - SEE ARCHITECTURAL PLANS) = 136.75'
 - THEREFORE, THE HEIGHT OF THE BUILDING = 136.75' - 94.2' = 42.55'
 - PARKING CALCULATION:
 - PER SECTION 10.2 OF THE SIMSBURY ZONING REGULATIONS, TWO PARKING SPACES SHALL BE PROVIDED FOR EACH DWELLING UNIT. THEREFORE, 80 UNITS X 2 SPACES/UNIT = 160 PARKING SPACES REQUIRED
 - PER CT PUBLIC ACT 21-29, THE MAXIMUM PARKING LIMITATIONS FOR MULTI-FAMILY DEVELOPMENTS ARE 3 PARKING SPACE FOR EACH ONE-BEDROOM UNIT, AND 2 PARKING SPACES FOR EACH TWO-BEDROOM UNIT.
 - ONE-BR UNITS: 77 ONE-BR UNITS X 1 SPACE/UNIT = 77 PARKING SPACES
 - TWO-BR UNITS: 3 TWO-BR UNITS X 2 SPACES/UNIT = 6 PARKING SPACES
 - TOTAL: 77 SPACES + 6 SPACES = 83 PARKING SPACES
 - PARKING SPACES PROVIDED: 95 PARKING SPACES
 - THE DEVELOPMENT IS BEING PROPOSED IN ACCORDANCE WITH GENERAL STATUTES 8-30G.

ZONING DATA TABLE		
HIGH DENSITY RESIDENTIAL 'R-15' ZONING DISTRICT		
ITEM	REQUIRED	PROVIDED
MIN. LOT AREA	15,000 SQ. FT.	85,591 SQ. FT.
LOT FRONTAGE	100 FT.	149.91 FT.
FRONT YARD SETBACK	35 FT.	294.2 FT.
SIDE YARD SETBACK	12 FT.	86.0 FT. (N) 18.8 FT. (S)
REAR YARD SETBACK	25 FT.	38.9 FT.
MAX. BUILDING HEIGHT (SEE ZONING NOTE #1)	35 FT.	42.55 FT. (SEE ZONING NOTE #4)
IMPERVIOUS COVERAGE	N/A	51,849 SQ. FT.
MIN. REQUIRED PARKING (SEE ZONING NOTE #2)	160 PARKING SPACES	94 PARKING SPACES

H+H+H ENGINEERING ASSOCIATES
 232 Greenmanville Avenue
 Suite 201
 Mystic, CT 06355
 860-980-8008 (C) 413-279-4488 (M)
 www.hh-engineers.com

STAMP

REV	DATE	DESCRIPTION OF REVISION
3	3/30/2023	REVISIONS PER ENGINEERING REVIEW COMMENTS & IWA COMMENTS
2	3/17/2023	REVISIONS PER ENGINEERING REVIEW COMMENTS & IWA COMMENTS
1	2/24/2023	REVISIONS PER REVIEW COMMENTS

SITE LAYOUT PLAN

VESEL MULTI-FAMILY HOUSING
 PROPERTY ADDRESS
 446 HOPMEADOW STREET, SIMSBURY, CT 06089
 PREPARED FOR
VESEL RE HOLDINGS, LLC
 46 WEST 55TH STREET, NEW YORK, NY 10019


STATE OF CONNECTICUT

SCALE IN FEET
 1" = 20'

PROJECT NO: 2022-0013
 SCALE: 1" = 20'
 DRAWN BY: SMM
 DATE: 12/16/2022
 CHECKED BY: SMM
 DATE: 12/16/2022

DRAWING
SL-1

SHEET NUMBER: 2 OF 12

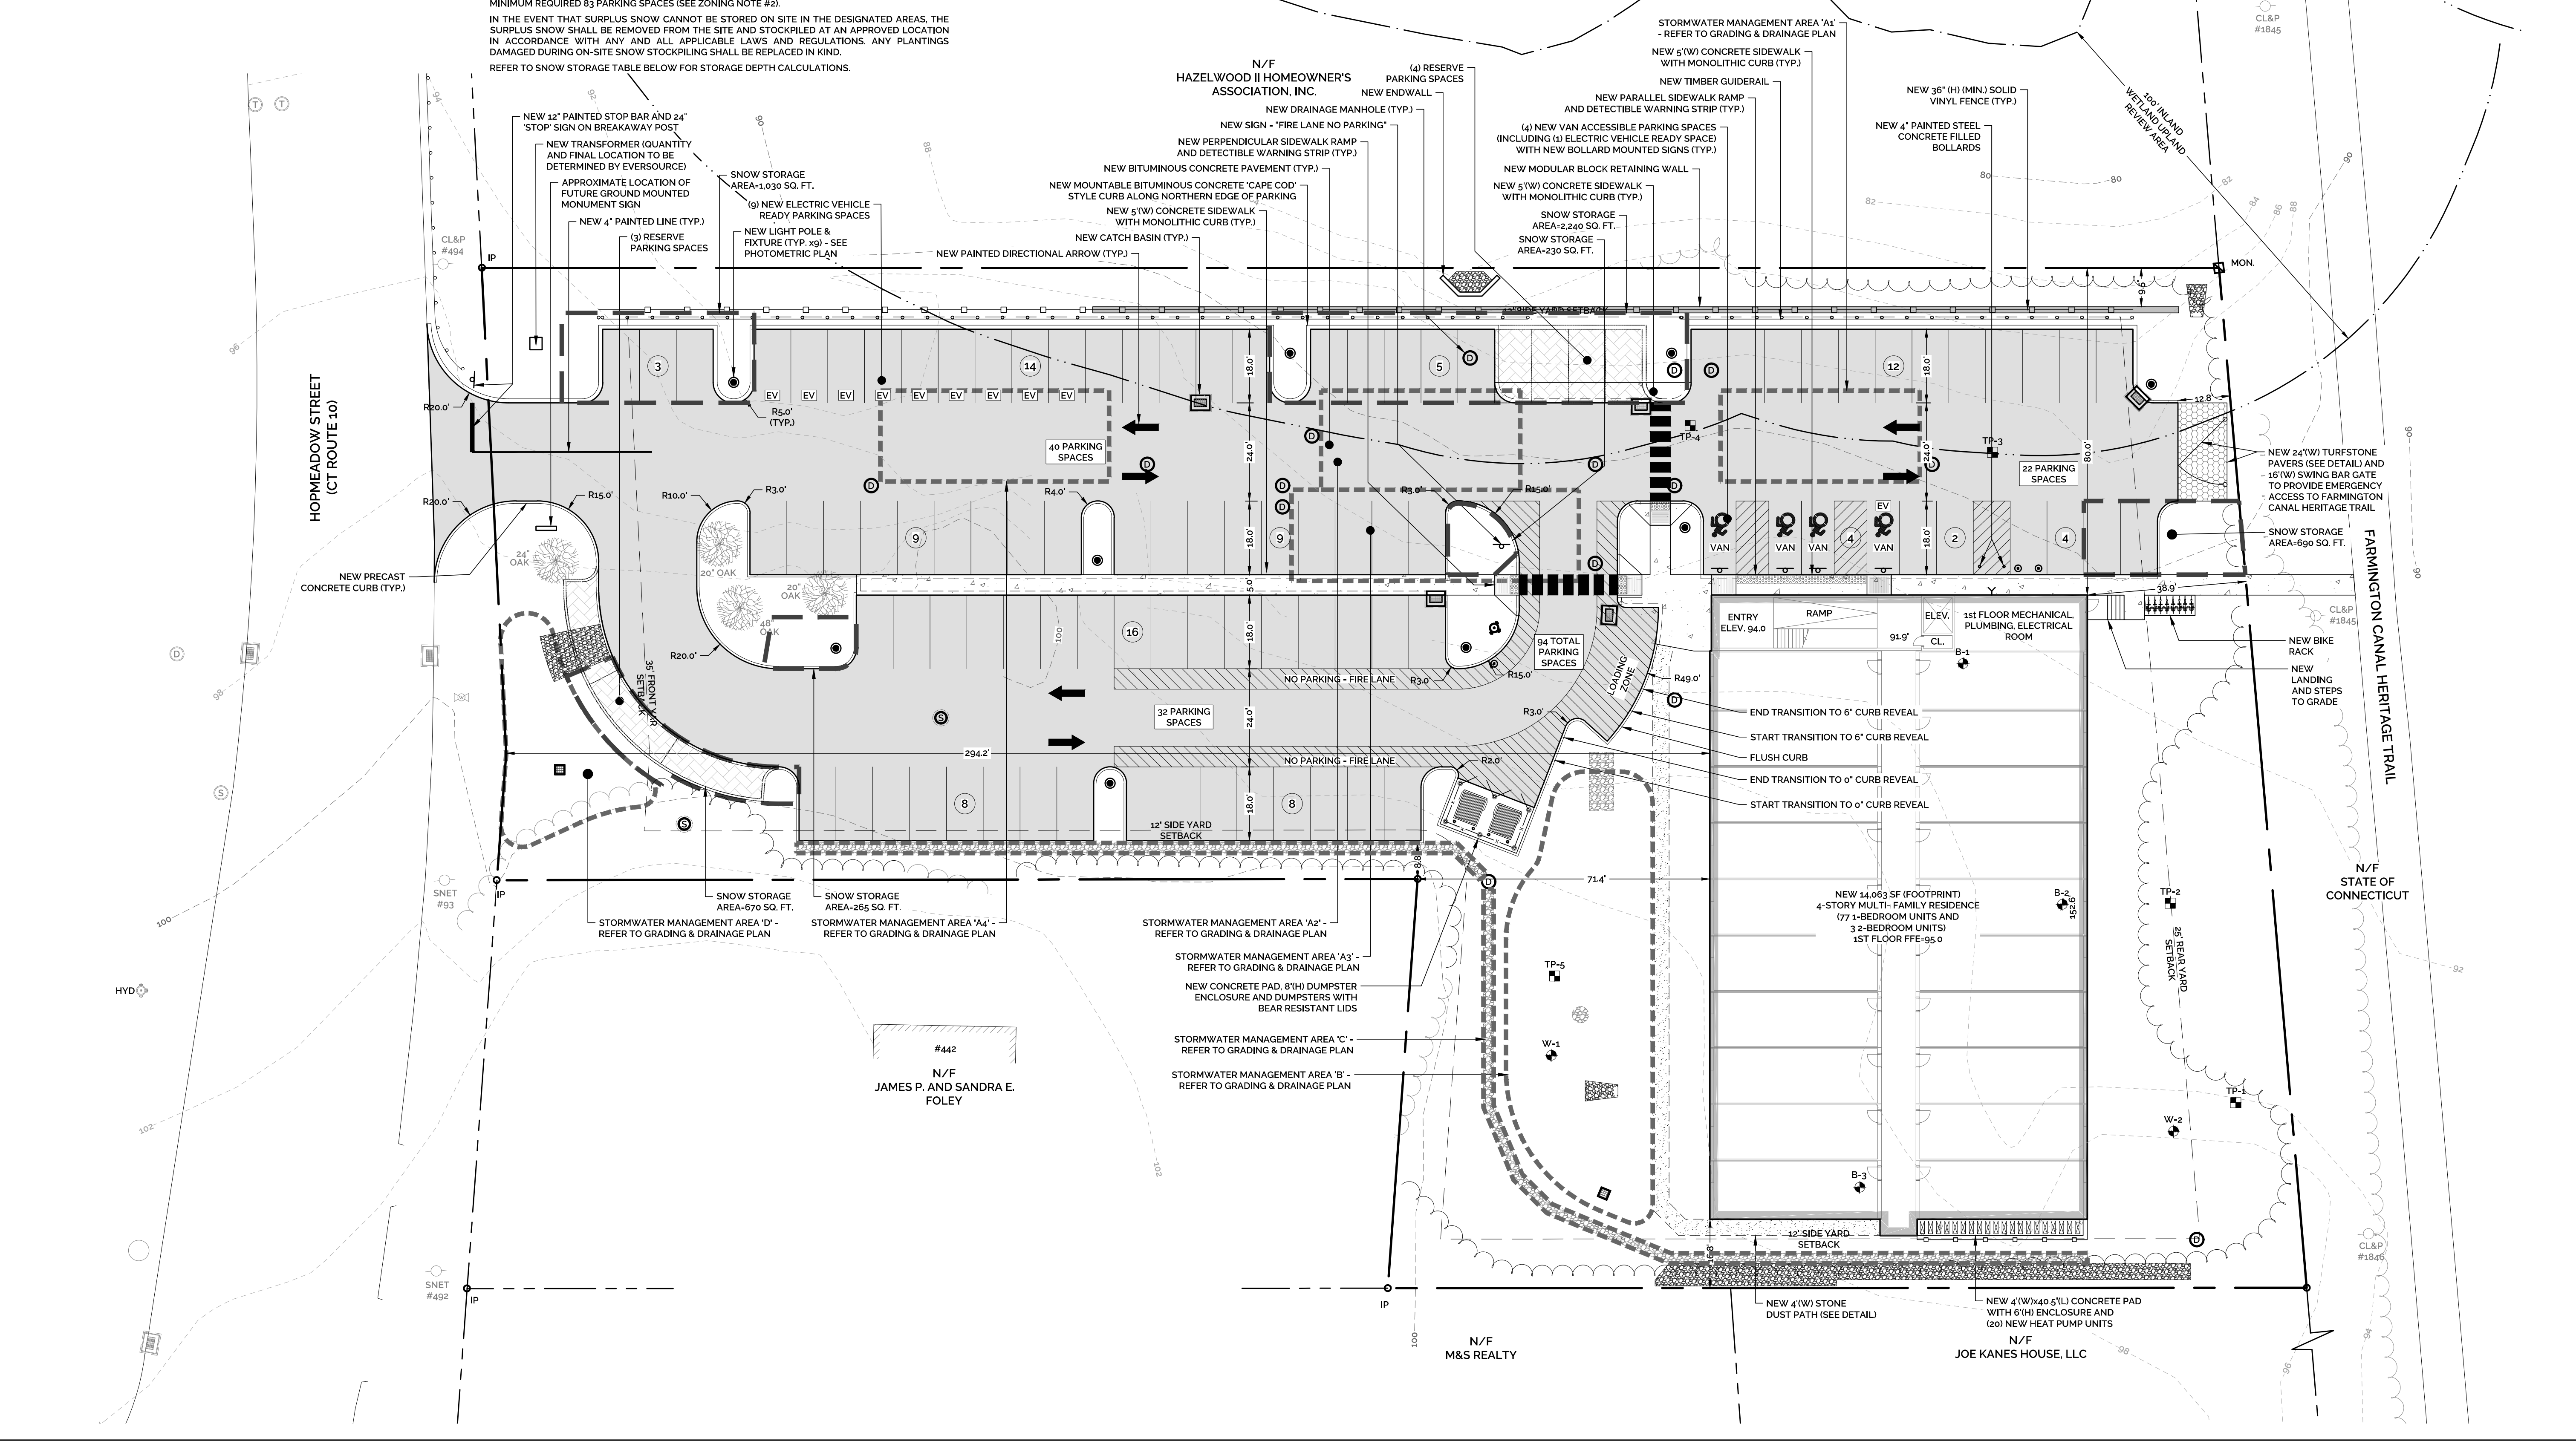

Z:\SIMSBURY\ENGINEERING\ASSOCIATES\PROJECTS\2022\0013\0013 - VESSEL - 446 HOPMEADOW ST. SIMSBURY\DWGS\02-SITE LAYOUT\PLANDWG\Tab: SITE LAYOUT\Sheet: 2 of 12.dwg (3/30/2023 12:03 PM)

GRADING & DRAINAGE NOTES:

1. CONTRACTOR SHALL CLEAN ALL EXISTING AND PROPOSED STRUCTURES AND PIPES UPON COMPLETION OF CONSTRUCTION.
2. THE SITE CONTRACTOR SHALL REVIEW THE SITE GRADES AND FEATURES TO ENSURE THAT THE PROPOSED WORK IS CONSISTENT WITH THE EXISTING CONDITIONS AS PRESENTED ON THE PLANS. AT LEAST ONE NEW BENCHMARK WILL NEED TO BE ESTABLISHED ON THE SITE PRIOR TO CONSTRUCTION.
3. CONTRACTOR TO VERIFY ALL EXISTING PIPE CONNECTIONS AND INVERTS. ANY CONFLICTS SHOULD BE EXPRESSED TO OWNER AND THE DESIGN ENGINEER.

GENERAL CONSTRUCTION NOTES:

1. THE LOCATIONS OF SUBSURFACE UTILITIES SHOWN HEREON ARE APPROXIMATE. THE ACTUAL LOCATION OF SUBSURFACE UTILITIES MAY VARY FROM THOSE INDICATED AND ALL UNDERGROUND UTILITIES MAY NOT BE SHOWN.
2. THE CONTRACTOR SHALL CONTACT "CALL BEFORE YOU DIG" AT 800-922-4455 TO MARK OUT ALL UNDERGROUND UTILITIES A MINIMUM OF 3 BUSINESS DAYS PRIOR TO COMMENCING ANY CONSTRUCTION ACTIVITY. CONTRACTOR SHALL VERIFY ALL LOCATIONS, DIMENSIONS AND ELEVATIONS OF ALL UTILITIES PRIOR TO CONSTRUCTION. IF UTILITIES DIFFER FROM THOSE SHOWN ON THIS PLAN, ENGINEER SHALL BE NOTIFIED.
3. ALL PROPERTY LINES SHALL BE VERIFIED IN THE FIELD. NO PRIVATE PROPERTY SHALL BE DISTURBED UNLESS PROPER RIGHTS ARE OBTAINED PRIOR TO CONSTRUCTION.
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6. EXISTING DRAINAGE PATTERNS SHALL BE SUBSTANTIALLY MAINTAINED. THE CONTRACTOR SHALL GRADE THE PROPERTY IN SUCH A MANNER TO MAINTAIN EXISTING LOCAL DRAINAGE PATTERNS AND TO PREVENT EXCESS RUNOFF AND/OR PONDING ON ADJACENT PROPERTIES BOTH DURING AND AFTER CONSTRUCTION.
7. A CONNECTICUT DEPARTMENT OF TRANSPORTATION HIGHWAY ENCROACHMENT PERMIT IS REQUIRED FOR ALL IMPROVEMENTS, INCLUDING BUT NOT LIMITED TO APRONS, CURB CUTS, UTILITY LATERALS AND ROADWAY PAVEMENT PATCHING, WITHIN THE STATE RIGHT-OF-WAY.

STORMWATER MANAGEMENT SYSTEM MAINTENANCE PLAN:

1. GENERAL
 - A. THE ACCESS DRIVE AND PARKING AREAS SHOULD BE SWEEPED AT LEAST ONCE PER YEAR, PREFERABLY AFTER THE END OF THE WINTER SANDING SEASON.
2. CATCH BASINS AND MANHOLES
 - A. A CONNECTICUT-LICENSED HAULER SHALL PUMP THE SUMPS OF ON-SITE CATCH BASINS AND MANHOLES, AND SHALL DISPOSE OF THE PUMPING LEGALLY. ROAD SAND MAY BE REUSED FOR WINTER SANDING, BUT MAY NOT BE STORED ON-SITE AS PART OF THE HAULING CONTRACT. THE HAULER SHALL NOTIFY THE PROPERTY OWNER IN WRITING WHERE THE MATERIAL IS BEING DISPOSED.
 - B. EACH CATCH BASIN SHALL BE INSPECTED EVERY FOUR MONTHS, WITH ONE INSPECTION OCCURRING DURING THE MONTH OF APRIL. ANY DEBRIS OCCURRING WITHIN ONE FOOT FROM THE BOTTOM OF EACH SUMP SHALL BE REMOVED BY VACUUM "VACUOR" TYPE OF MAINTENANCE EQUIPMENT.
3. STORMTECH UNDERGROUND INFILTRATION SYSTEM
 - A. THE ISOLATOR ROWS SHALL BE CLEANED AT THE END OF CONSTRUCTION ONCE THE CONTRIBUTING AREAS ARE FULLY STABILIZED FOR THE FIRST YEAR OF OPERATION FOLLOWING CONSTRUCTION. THE CHAMBER ROWS SHALL BE INSPECTED ONCE EVERY 6 MONTHS.
 - B. AFTER THE FIRST YEAR OF OPERATION, THE CHAMBERS SHALL BE INSPECTED A MINIMUM OF ONCE PER YEAR. IF UPON VISUAL INSPECTION IT IS FOUND THAT SEDIMENT HAS ACCUMULATED, A STADIA ROD SHOULD BE INSERTED TO DETERMINE THE DEPTH OF THE SEDIMENT. WHEN THE AVERAGE DEPTH OF ACCUMULATION EXCEEDS 3", A CLEAN-OUT SHOULD BE PERFORMED AND PROPERLY DISPOSED OFF-SITE. CLEAN-OUT SHOULD BE ACCOMPLISHED USING A JETVAC PROCESS.
 - C. A DETAILED MAINTENANCE LOGBOOK SHALL BE KEPT ON-SITE FOR THE UNITS BY THE PROPERTY OWNER/MANAGER. INFORMATION IS TO INCLUDE, BUT NOT BE LIMITED TO, THE DATE OF INSPECTION, RECORD OF SEDIMENT DEPTH, GENERAL OBSERVATIONS, AND DATE OF CLEANING PERFORMED.

BIORETENTION BASIN

- A. PRUNE SHRUBS AS NEEDED.
 - B. BASIN FLOOR AND SLOPES SHALL BE MOWED 6" TO 8" AS NEEDED. GRASS CLIPPINGS, LEAVES AND ACCUMULATED SEDIMENT AND DEBRIS SHALL BE REMOVED DURING THE SUMMER. HOWEVER, PLANT MATTER SHALL BE LEFT IN PLACE OVER WINTER MONTHS TO INSULATE THE SOIL AND ADD ORGANIC MATTER TO THE SOIL. REMOVAL CRITERIA SHALL INCLUDE WHEN PLANT MATTER IS SMOTHERING PLANTS, CAUSING VISUAL AND AESTHETIC ISSUES.
 - C. REMOVE SEDIMENT GREATER THAN 1.0 INCH DEEP IN MARCH-APRIL IN THE FILTER MEDIA BED IN A MANNER TO MINIMIZE DAMAGE TO VEGETATION.
 - D. INSPECT SOIL AND REPAIR ERODED AREAS SEASONALLY OR AS NECESSARY.
 - E. REMOVE ANY INVASIVE SPECIES (INCLUDING ROOTS) THAT HAVE BECOME ESTABLISHED WITHIN THE BASIN AND EMBANKMENTS.
 - F. IF THERE IS AN ACCUMULATION OF ORGANIC DEBRIS OR SEDIMENT ON THE FLOOR OF THE BASIN, OR IF PONDED WATER IS REGULARLY OBSERVED MORE THAN 48 HOURS AFTER A RAINFALL EVENT, THE TOP 6" SHALL BE REMOVED AND THE EXPOSED SOIL SURFACE ROTOTILLED TO A DEPTH OF 12". SEDIMENTATION SHOULD BE REMOVED WHEN IT IS VISIBLY DRY AND READILY SEPARATES FROM THE BASIN FLOOR TO MINIMIZE SMEARING. AFTER THIS WORK HAS BEEN DONE, THE BOTTOM OF THE BASIN SHALL BE RESTORED TO ITS ORIGINAL CONDITION.
 - G. NO PESTICIDES OR NON-ORGANIC FERTILIZERS SHALL BE USED IN AREAS DRAINING TO THE BIORETENTION BASIN.
- DRYWELL AND COLLECTION BASIN**
- A. THE DRYWELL SHALL BE CLEANED AT THE END OF CONSTRUCTION ONCE THE CONTRIBUTING AREAS ARE FULLY STABILIZED. FOR THE FIRST YEAR OF OPERATION FOLLOWING CONSTRUCTION, THE DRYWELLS SHALL BE INSPECTED ONCE EVERY 6 MONTHS.
 - B. AFTER THE FIRST YEAR OF OPERATION, THE DRYWELLS SHALL BE INSPECTED A MINIMUM OF ONCE PER YEAR. IF UPON VISUAL INSPECTION IT IS FOUND THAT SEDIMENT HAS ACCUMULATED, A STADIA ROD SHOULD BE INSERTED TO DETERMINE THE DEPTH OF THE SEDIMENT. WHEN THE AVERAGE DEPTH OF ACCUMULATION EXCEEDS 3", A CLEAN-OUT SHOULD BE PERFORMED AND PROPERLY DISPOSED OFF-SITE. CLEAN-OUT SHOULD BE ACCOMPLISHED USING A JETVAC PROCESS.
 - C. COLLECTION BASIN SHALL BE ROUTINELY CHECKED FOR SEDIMENT ACCUMULATION, TRASH AND DEBRIS. BASIN SHALL BE MOWED TO 4-6" AS NEEDED. GRASS CLIPPINGS, LEAVES AND ACCUMULATED SEDIMENT AND DEBRIS SHALL BE REMOVED. REMOVE ANY INVASIVE SPECIES (INCLUDING ROOTS) THAT HAVE BECOME ESTABLISHED WITHIN THE BASIN AND EMBANKMENTS.
 - D. A DETAILED MAINTENANCE LOGBOOK SHALL BE KEPT ON-SITE FOR THE UNITS BY THE PROPERTY OWNER/MANAGER. INFORMATION IS TO INCLUDE, BUT NOT BE LIMITED TO, THE DATE OF INSPECTION, RECORD OF SEDIMENT DEPTH, GENERAL OBSERVATIONS, AND DATE OF CLEANING PERFORMED.


DRAINAGE STRUCTURE TABLE			
STRUCTURE ID	STRUCTURE TYPE	TOP OF FRAME	INVERT
CB-1	TYPE 'C' CB W/ 4' SUMP AND TRAP HOOD	89.70	86.20 (12" OUT) (W)
ICS-1	INLET CONTROL STRUCTURE	94.35	85.90 (12" IN) (E) 86.86 (12" OUT) (W) 86.86 (12" OUT) (N)
STORMWATER MANAGEMENT AREA 'A2'	ADS STORMTECH MC-3500 SUBSURFACE INFILTRATION SYSTEM	---	86.86 (12" IN) 85.86 (12" OUT)
OCS-1	OUTLET CONTROL STRUCTURE	92.70	85.86 (12" IN) (S) 85.80 (12" OUT) (N)
CB-2	TYPE 'C' CB W/ 4' SUMP AND TRAP HOOD	92.90	87.80 (12" OUT) (S)
ICS-2	INLET CONTROL STRUCTURE	93.30	87.70 (12" IN) (E) 87.66 (12" OUT) (W) 87.66 (12" OUT) (N)
STORMWATER MANAGEMENT AREA 'A2'	ADS STORMTECH MC-3500 SUBSURFACE INFILTRATION SYSTEM	---	87.66 (12" IN) 87.66 (12" OUT)
OCS-2	OUTLET CONTROL STRUCTURE	94.20	87.66 (12" IN) (N & E) 87.60 (12" OUT) (S)

DRAINAGE STRUCTURE TABLE			
STRUCTURE ID	STRUCTURE TYPE	TOP OF FRAME	INVERT
CB-3	TYPE 'C' CB W/ 2' SUMP	94.40	88.50 (12" OUT) (E)
CB-4	TYPE 'C' CB W/ 4' SUMP AND TRAP HOOD	93.25	88.20 (12" IN) (W) 88.10 (12" OUT) (N)
ICS-3	INLET CONTROL STRUCTURE	93.40	88.10 (12" IN) (S) 88.06 (12" OUT) (W) 88.06 (12" OUT) (N)
STORMWATER MANAGEMENT AREA 'A3'	ADS STORMTECH MC-3500 SUBSURFACE INFILTRATION SYSTEM	---	88.06 (12" IN) 88.06 (12" OUT)
OCS-3	OUTLET CONTROL STRUCTURE	94.50	88.06 (12" IN) (S & E) 88.00 (12" OUT) (N)
CB-5	TYPE 'C' CB W/ 4' SUMP AND TRAP HOOD	94.50	89.00 (12" OUT) (S)
ICS-4	INLET CONTROL STRUCTURE	95.00	88.90 (12" IN) (E) 88.86 (12" OUT) (W) 88.86 (12" OUT) (N)
STORMWATER MANAGEMENT AREA 'A4'	ADS STORMTECH MC-3500 SUBSURFACE INFILTRATION SYSTEM	---	88.86 (12" IN) 88.86 (12" OUT)
OCS-4	OUTLET CONTROL STRUCTURE	96.25	88.86 (12" IN) (N) 88.80 (12" OUT) (E)

DRAINAGE STRUCTURE TABLE			
STRUCTURE ID	STRUCTURE TYPE	TOP OF FRAME	INVERT
DMH-1	DRAINAGE MANHOLE	94.45	87.90 (12" IN) (S) 87.50 (12" IN) (N) 86.50 (12" IN) (W) 86.65 (12" OUT) (E)
DMH-2	DRAINAGE MANHOLE	93.10	85.45 (8" IN) (S) 84.85 (15" IN) (W) 84.75 (15" OUT) (N)
DMH-3	DRAINAGE MANHOLE	93.30	85.70 (12" IN) (E) 84.70 (15" IN) (S) 84.25 (15" IN) (E) 84.25 (15" OUT) (N)
DMH-4	DRAINAGE MANHOLE	92.50	84.25 (15" IN) (E) 84.10 (15" OUT) (N)
EW-1	CONCRETE ENDWALL	87.00 (TW)	84.10 (15")
OCS-5	OUTLET CONTROL STRUCTURE	93.60	89.00 (12" OUT) (S)
DMH-5	DRAINAGE MANHOLE	95.20	88.25 (12" IN) (S) 88.25 (12" OUT) (N)
FES-1	FLARED END SECTION	---	87.00 (12")
STORMWATER MANAGEMENT AREA 'C'	CURTAIN DRAIN/ GROUNDWATER DRAIN	---	88.30 (W END IN) 88.65 (E END IN) 87.40 (OUT)
OCS-6	OUTLET CONTROL STRUCTURE	96.00	87.40 (6" IN) (N & S) 87.20 (8" OUT) (E)
DMH-6	DRAINAGE MANHOLE	94.20	86.20 (8" IN) (SW) 86.20 (8" OUT) (N)

DRAINAGE PIPE TABLE					
STRUCTURES	LENGTH (FT)	MATERIAL	PIPE SIZE	SLOPE (FT/FT)	REV
CB-1 - ICS-1	50	CLASS IV RCP	12"	S-0.006	
SWM-A1 OUTLET MANIFOLD - OCS-1	15	CORRUGATED HDPE SMOOTH INTERIOR	12"	S-0.000	
OCS-1 - DMH-3	6	CORRUGATED HDPE SMOOTH INTERIOR	12"	S-0.017	
CB-2 - ICS-2	14	CORRUGATED HDPE SMOOTH INTERIOR	12"	S-0.007	
SWM-A2 OUTLET MANIFOLD - OCS-2	6	CORRUGATED HDPE SMOOTH INTERIOR	12"	S-0.000	
OCS-2 - DMH-1	9	CORRUGATED HDPE SMOOTH INTERIOR	12"	S-0.011	
CB-3 - CB-4	38	CORRUGATED HDPE SMOOTH INTERIOR	12"	S-0.008	
CB-4 - ICS-3	39	CORRUGATED HDPE SMOOTH INTERIOR	12"	S-0.011	
SWM-A3 OUTLET MANIFOLD - OCS-3	6	CORRUGATED HDPE SMOOTH INTERIOR	12"	S-0.000	
OCS-3 - DMH-1	2	CORRUGATED HDPE SMOOTH INTERIOR	12"	S-0.050	
CB-5 - ICS-4	17	CORRUGATED HDPE SMOOTH INTERIOR	12"	S-0.006	
SWM-A4 OUTLET MANIFOLD - OCS-4	18	CORRUGATED HDPE SMOOTH INTERIOR	12"	S-0.000	
OCS-4 - DMH-1	98	CORRUGATED HDPE SMOOTH INTERIOR	12"	S-0.019	
DMH-1 - DMH-2	93	CORRUGATED HDPE SMOOTH INTERIOR	15"	S-0.019	
DMH-2 - DMH-3	25	CORRUGATED HDPE SMOOTH INTERIOR	15"	S-0.006	
DMH-3 - DMH-4	47	CORRUGATED HDPE SMOOTH INTERIOR	15"	S-0.010	
DMH-4 - EW-1	15	CORRUGATED HDPE SMOOTH INTERIOR	15"	S-0.010	
OCS-5 - DMH-5	145	CORRUGATED HDPE SMOOTH INTERIOR	12"	S-0.005	
DMH-5 - FES-1	225	CORRUGATED HDPE SMOOTH INTERIOR	12"	S-0.006	
SWM-C PERF. PIPE (W)	172	SDR-35 PVC PERFORATED PIPE	6"	S-0.005	
SWM-C PERF. PIPE (E)	245	SDR-35 PVC PERFORATED PIPE	6"	S-0.005	
OCS-6 - DMH-6	61	CORRUGATED HDPE SMOOTH INTERIOR	8"	S-0.016	
DMH-6 - DMH-2	49	CORRUGATED HDPE SMOOTH INTERIOR	8"	S-0.015	

REV	DATE	DESCRIPTION OF REVISION
3	3/20/2023	REVISIONS PER ENGINEERING REVIEW COMMENTS & IWA COMMENTS
2	3/17/2023	REVISIONS PER ENGINEERING REVIEW COMMENTS & IWA COMMENTS
1	2/24/2023	REVISIONS PER REVIEW COMMENTS

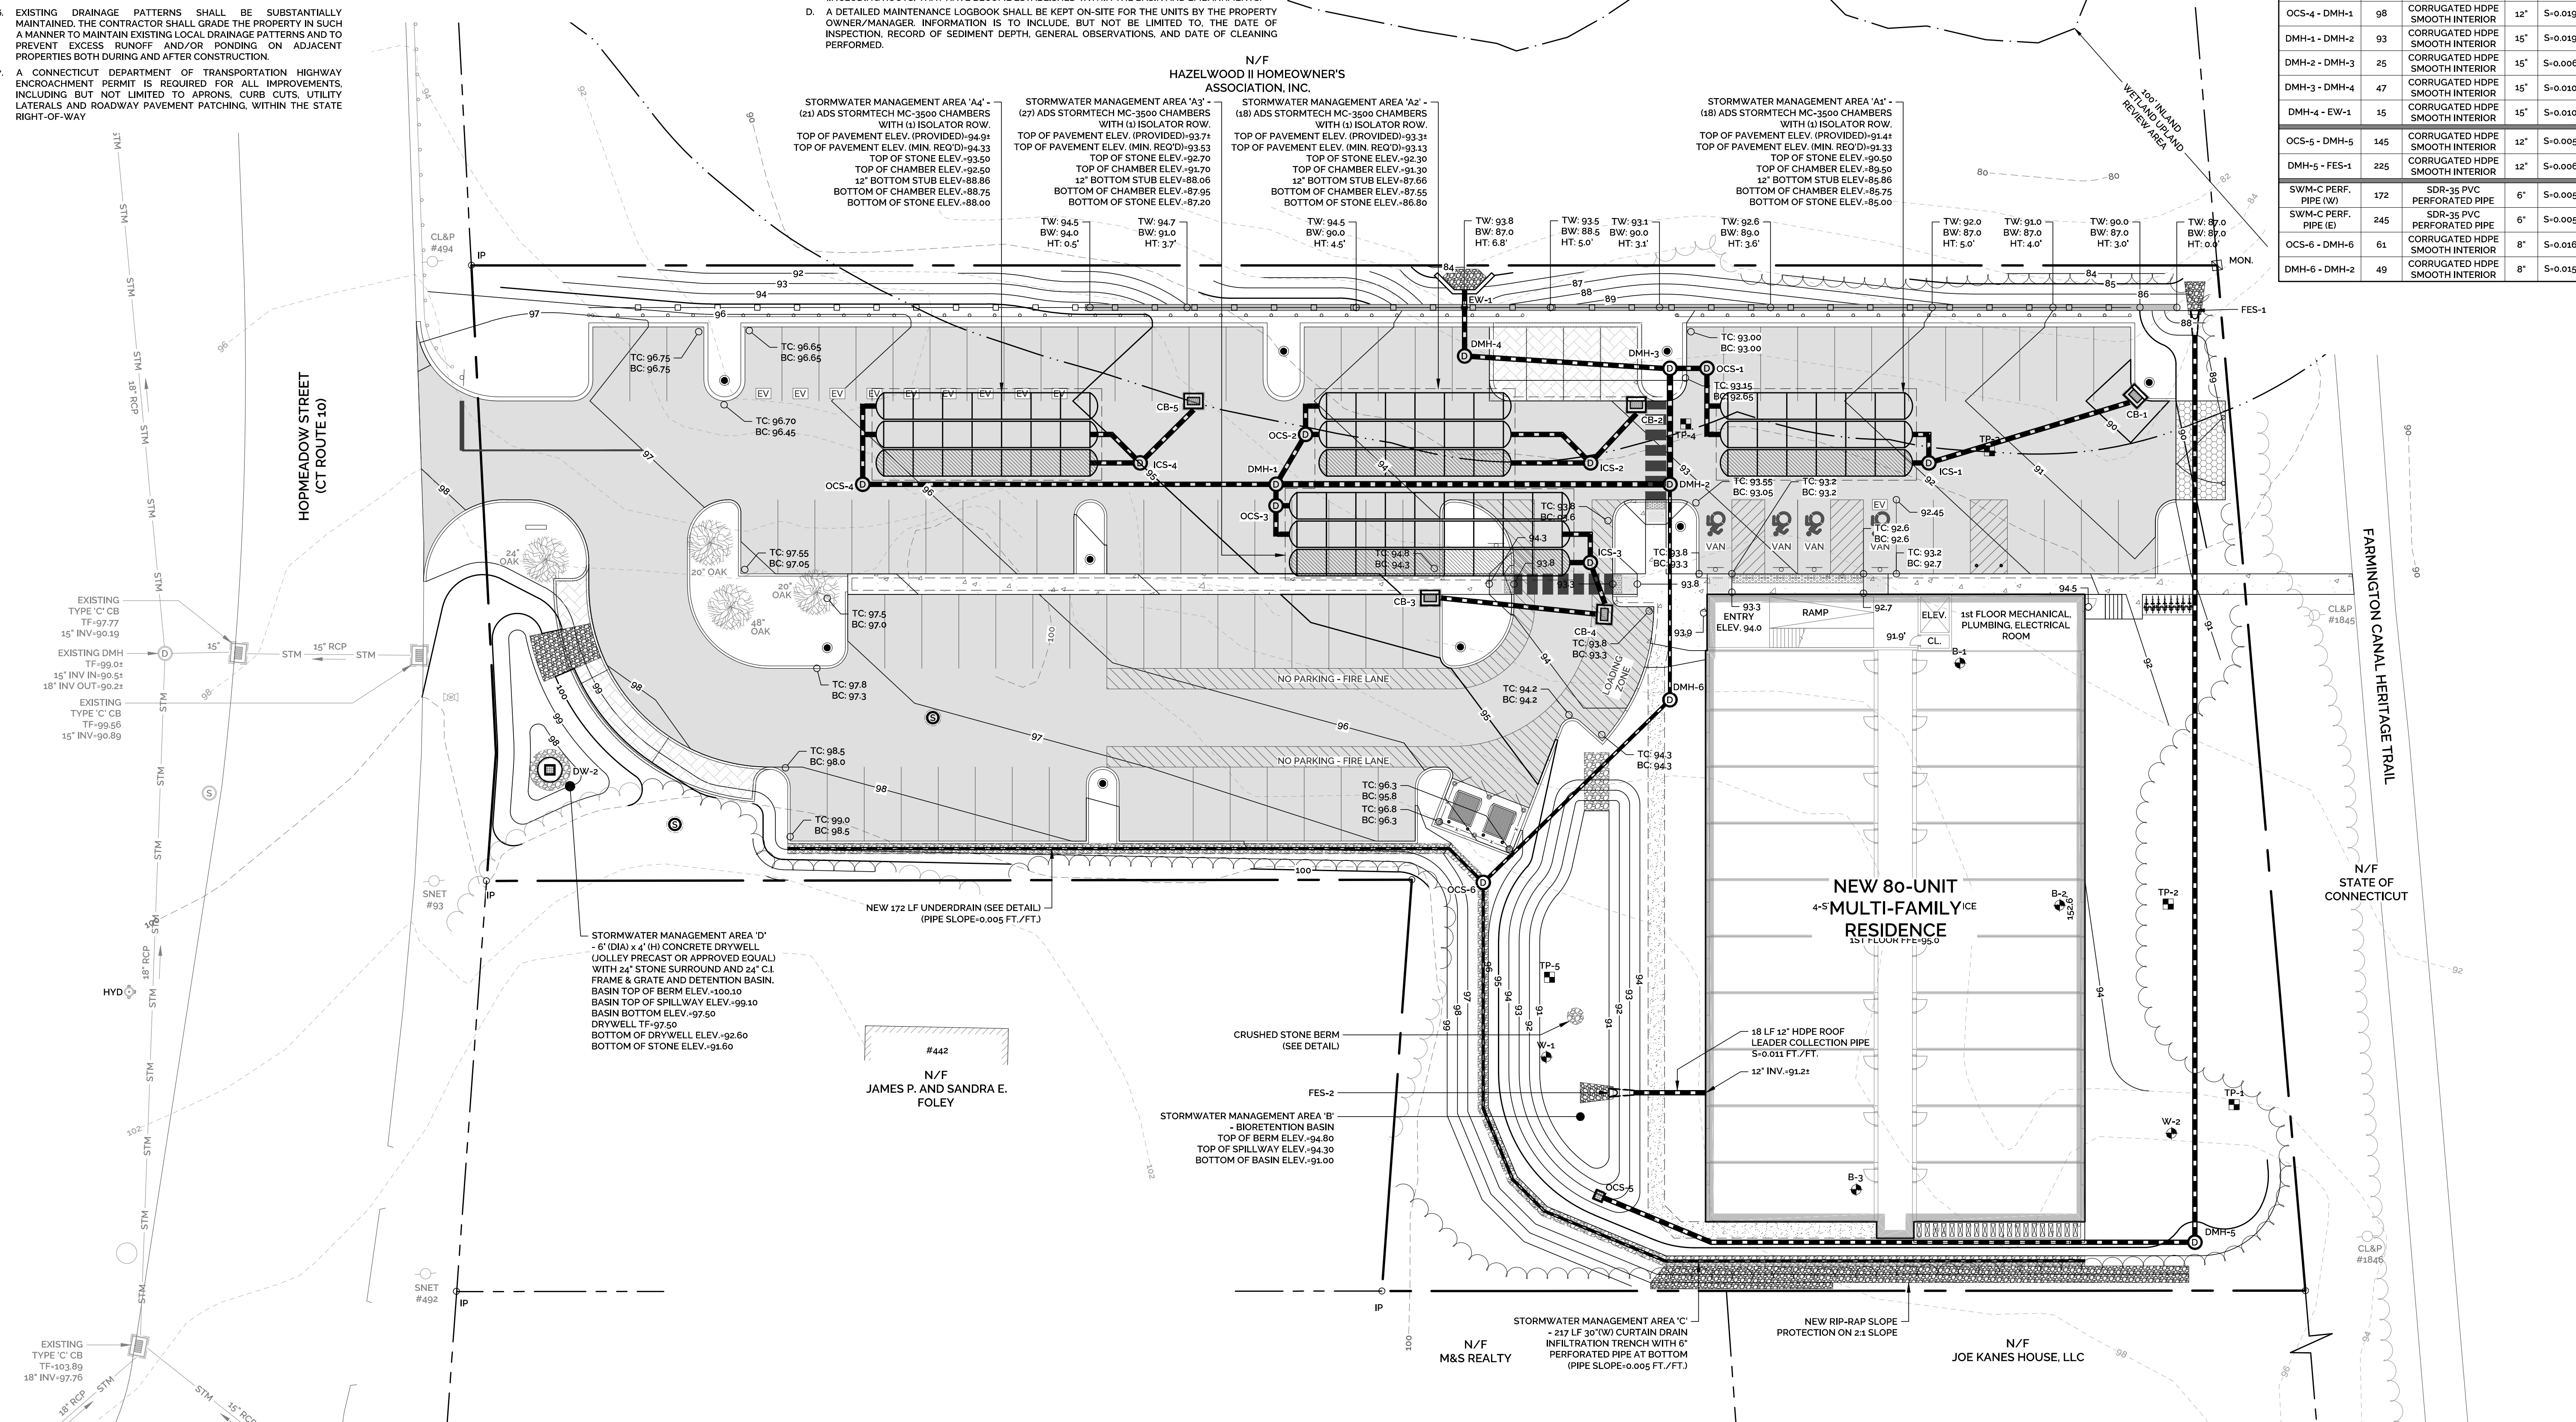

GRADING & DRAINAGE PLAN

VESSEL MULTI-FAMILY HOUSING
 PROPERTY ADDRESS
 446 HOPMEADOW STREET, SIMSBURY, CT 06089

PREPARED FOR
VESSEL RE HOLDINGS, LLC
 46 WEST 55TH STREET, NEW YORK, NY 10019

DRAWING GD-1

SHEET NUMBER: 3 OF 12

SCALE IN FEET: 1" = 20'

PROJECT NO: 2022-0013 SCALE: SMM

DRAWN BY: SMM DATE: 12/16/2022

CHECKED BY: SMM DATE: 12/16/2022

DATE: 12/16/2022

3: SIMSBURY ENGINEERING ASSOCIATES PROJECTS 0322-0322-0013 - VESSEL - 446 HOPMEADOW ST. SIMSBURY CT 06089 GRADING & DRAINAGE PLAN. DRAWING NO: GD-1. DATE: 12/16/2022. 12/16/2022 3:33 PM

UTILITY NOTES:


- ALL NEW UTILITIES, INCLUDING CATV, WILL BE LOCATED UNDERGROUND.
- ALL UTILITY WORK TO CONFORM TO TOWN OF SIMSBURY STANDARDS AND POLICIES AND PRACTICES OF THE DEPARTMENT OF PUBLIC WORKS.
- ELECTRIC, TELEPHONE, CABLE, WATER, AND SANITARY SEWER SERVICES SHALL CONFORM TO THE POLICIES AND PRACTICES OF THE APPROPRIATE UTILITY AUTHORITY. ELECTRICAL SERVICES ARE PROVIDED BY EVERSOURCE. WATER SERVICES ARE PROVIDED BY AQUARION WATER COMPANY. SANITARY SEWER SERVICES ARE PROVIDED BY THE TOWN OF SIMSBURY.
- ALL UTILITIES AND ON-SITE STORM DRAINAGE SHALL BE STRUCTURALLY SUPPORTED TO MINIMIZE DISRUPTION FROM SETTLEMENT OF UNDERLYING SOIL.
- SANITARY SEWER SERVICES SHALL BE SDR35 PVC PIPE. SEWER MANHOLES SHALL BE 5' DIA. PRECAST CONCRETE WITH HEAVY DUTY CAST IRON GRATES.
- UTILITY SERVICE SIZES, MATERIALS, AND INSTALLATIONS SHALL BE APPROVED AND INSPECTED BY THE APPROPRIATE UTILITY COMPANY.
- LIGHTING SHALL BE DIRECTED INTERNALLY TOWARDS PARKING AREAS. LIGHT STANDARDS, LUMINARIES, WIRING & LOCATION SHALL BE DESIGNED BY A LICENSED ELECTRICAL ENGINEER.
- PROVIDE MINIMUM VERTICAL SEPARATION OF 12" FROM WATER MAIN TO DRAINAGE PIPING AND 18" TO SANITARY SEWER PIPING.
- LOCATION AND SIZE OF ALL BUILDING UTILITY CONNECTIONS SHALL BE COORDINATED WITH BUILDING ARCHITECTURAL PLANS AND APPROPRIATE UTILITY AUTHORITY.

UTILITY NOTES CONTINUED:

- WATER SERVICE INSTALLATION NOTES:
 - ALL WATER MAIN AND SERVICE INSTALLATIONS SHALL CONFORM TO THE POLICIES AND PRACTICES OF THE TOWN OF SIMSBURY DEPARTMENT OF PUBLIC WORKS AND ENGINEERING DIVISION.
 - APPROVED BACKFLOW PREVENTERS ARE REQUIRED ON ALL FIRE SPRINKLER AND DOMESTIC WATER LINES.
 - MINIMUM COVER OVER TOP OF WATER MAIN SHALL BE 4'-6" FROM FINISH GRADE.
 - PIPE SEPARATIONS:
 - 10' MINIMUM BETWEEN WATER AND SANITARY SEWER
 - 10' MINIMUM BETWEEN WATER AND BUILDINGS
 - 5' MINIMUM BETWEEN WATER AND CATCH BASINS OR DRAIN PIPES
 - SITE MUST BE AT SUBGRADE BEFORE WATER UTILITIES CAN BE INSTALLED.
 - ARCHITECTURAL PLANS SHALL SHOW UTILITY ROOM, ENTRY POINT OF WATER SERVICE, AND METER LOCATIONS.
 - ALL BRANCH LINE VALVES TO BE LOCATED AS CLOSE AS POSSIBLE TO MAIN LINES.
- MINIMUM 6" SEPARATION BETWEEN ELECTRIC AND ALL OTHER PIPES SUCH AS WATER, SEWER AND DRAINS. ALL ELECTRIC FACILITIES SUCH AS CONDUITS AND PRIMARY & SECONDARY HANDHOLES SHALL CONFORM TO THE REQUIREMENTS OF EVERSOURCE.
- SANITARY SEWER INSTALLATION NOTES:
 - ALL ABANDONED PIPES MUST BE TAKEN OUT AND REMOVED FROM THE JOB SITE. EXISTING SANITARY SEWER PIPES MAY NOT BE RE-USED ON SITE.
 - ANY CORED OPENINGS IN MANHOLES NOT BEING USED MUST BE PLUGGED.

GENERAL CONSTRUCTION NOTES:

- THE LOCATIONS OF SUBSURFACE UTILITIES SHOWN HEREON ARE APPROXIMATE. THE ACTUAL LOCATION OF SUBSURFACE UTILITIES MAY VARY FROM THOSE INDICATED AND ALL UNDERGROUND UTILITIES MAY NOT BE SHOWN.
- THE CONTRACTOR SHALL CONTACT "CALL BEFORE YOU DIG" AT 800-922-4455 TO MARK OUT ALL UNDERGROUND UTILITIES A MINIMUM OF 3 BUSINESS DAYS PRIOR TO COMMENCING ANY CONSTRUCTION ACTIVITY. CONTRACTOR SHALL VERIFY ALL LOCATIONS, DIMENSIONS AND ELEVATIONS OF ALL UTILITIES PRIOR TO CONSTRUCTION. IF UTILITIES DIFFER FROM THOSE SHOWN ON THIS PLAN, ENGINEER SHALL BE NOTIFIED.
- ALL PROPERTY LINES SHALL BE VERIFIED IN THE FIELD. NO PRIVATE PROPERTY SHALL BE DISTURBED UNLESS PROPER RIGHTS ARE OBTAINED PRIOR TO CONSTRUCTION.
- THE CONTRACTOR SHALL OBTAIN ALL REQUIRED PERMITS PRIOR TO CONSTRUCTION.
- THE CONTRACTOR SHALL OBTAIN, REVIEW AND ADHERE TO ALL REQUIREMENTS AND ANY CONDITIONS OF APPROVAL OF THE TOWN OF SIMSBURY.
- EXISTING DRAINAGE PATTERNS SHALL BE SUBSTANTIALLY MAINTAINED. THE CONTRACTOR SHALL GRADE THE PROPERTY IN SUCH A MANNER TO MAINTAIN EXISTING LOCAL DRAINAGE PATTERNS AND TO PREVENT EXCESS RUNOFF AND/OR PONDING ON ADJACENT PROPERTIES BOTH DURING AND AFTER CONSTRUCTION.
- A CONNECTICUT DEPARTMENT OF TRANSPORTATION HIGHWAY ENCROACHMENT PERMIT IS REQUIRED FOR ALL IMPROVEMENTS, INCLUDING BUT NOT LIMITED TO APRONS, CURB CUTS, UTILITY LATERALS AND ROADWAY PAVEMENT PATCHING, WITHIN THE STATE RIGHT-OF-WAY.

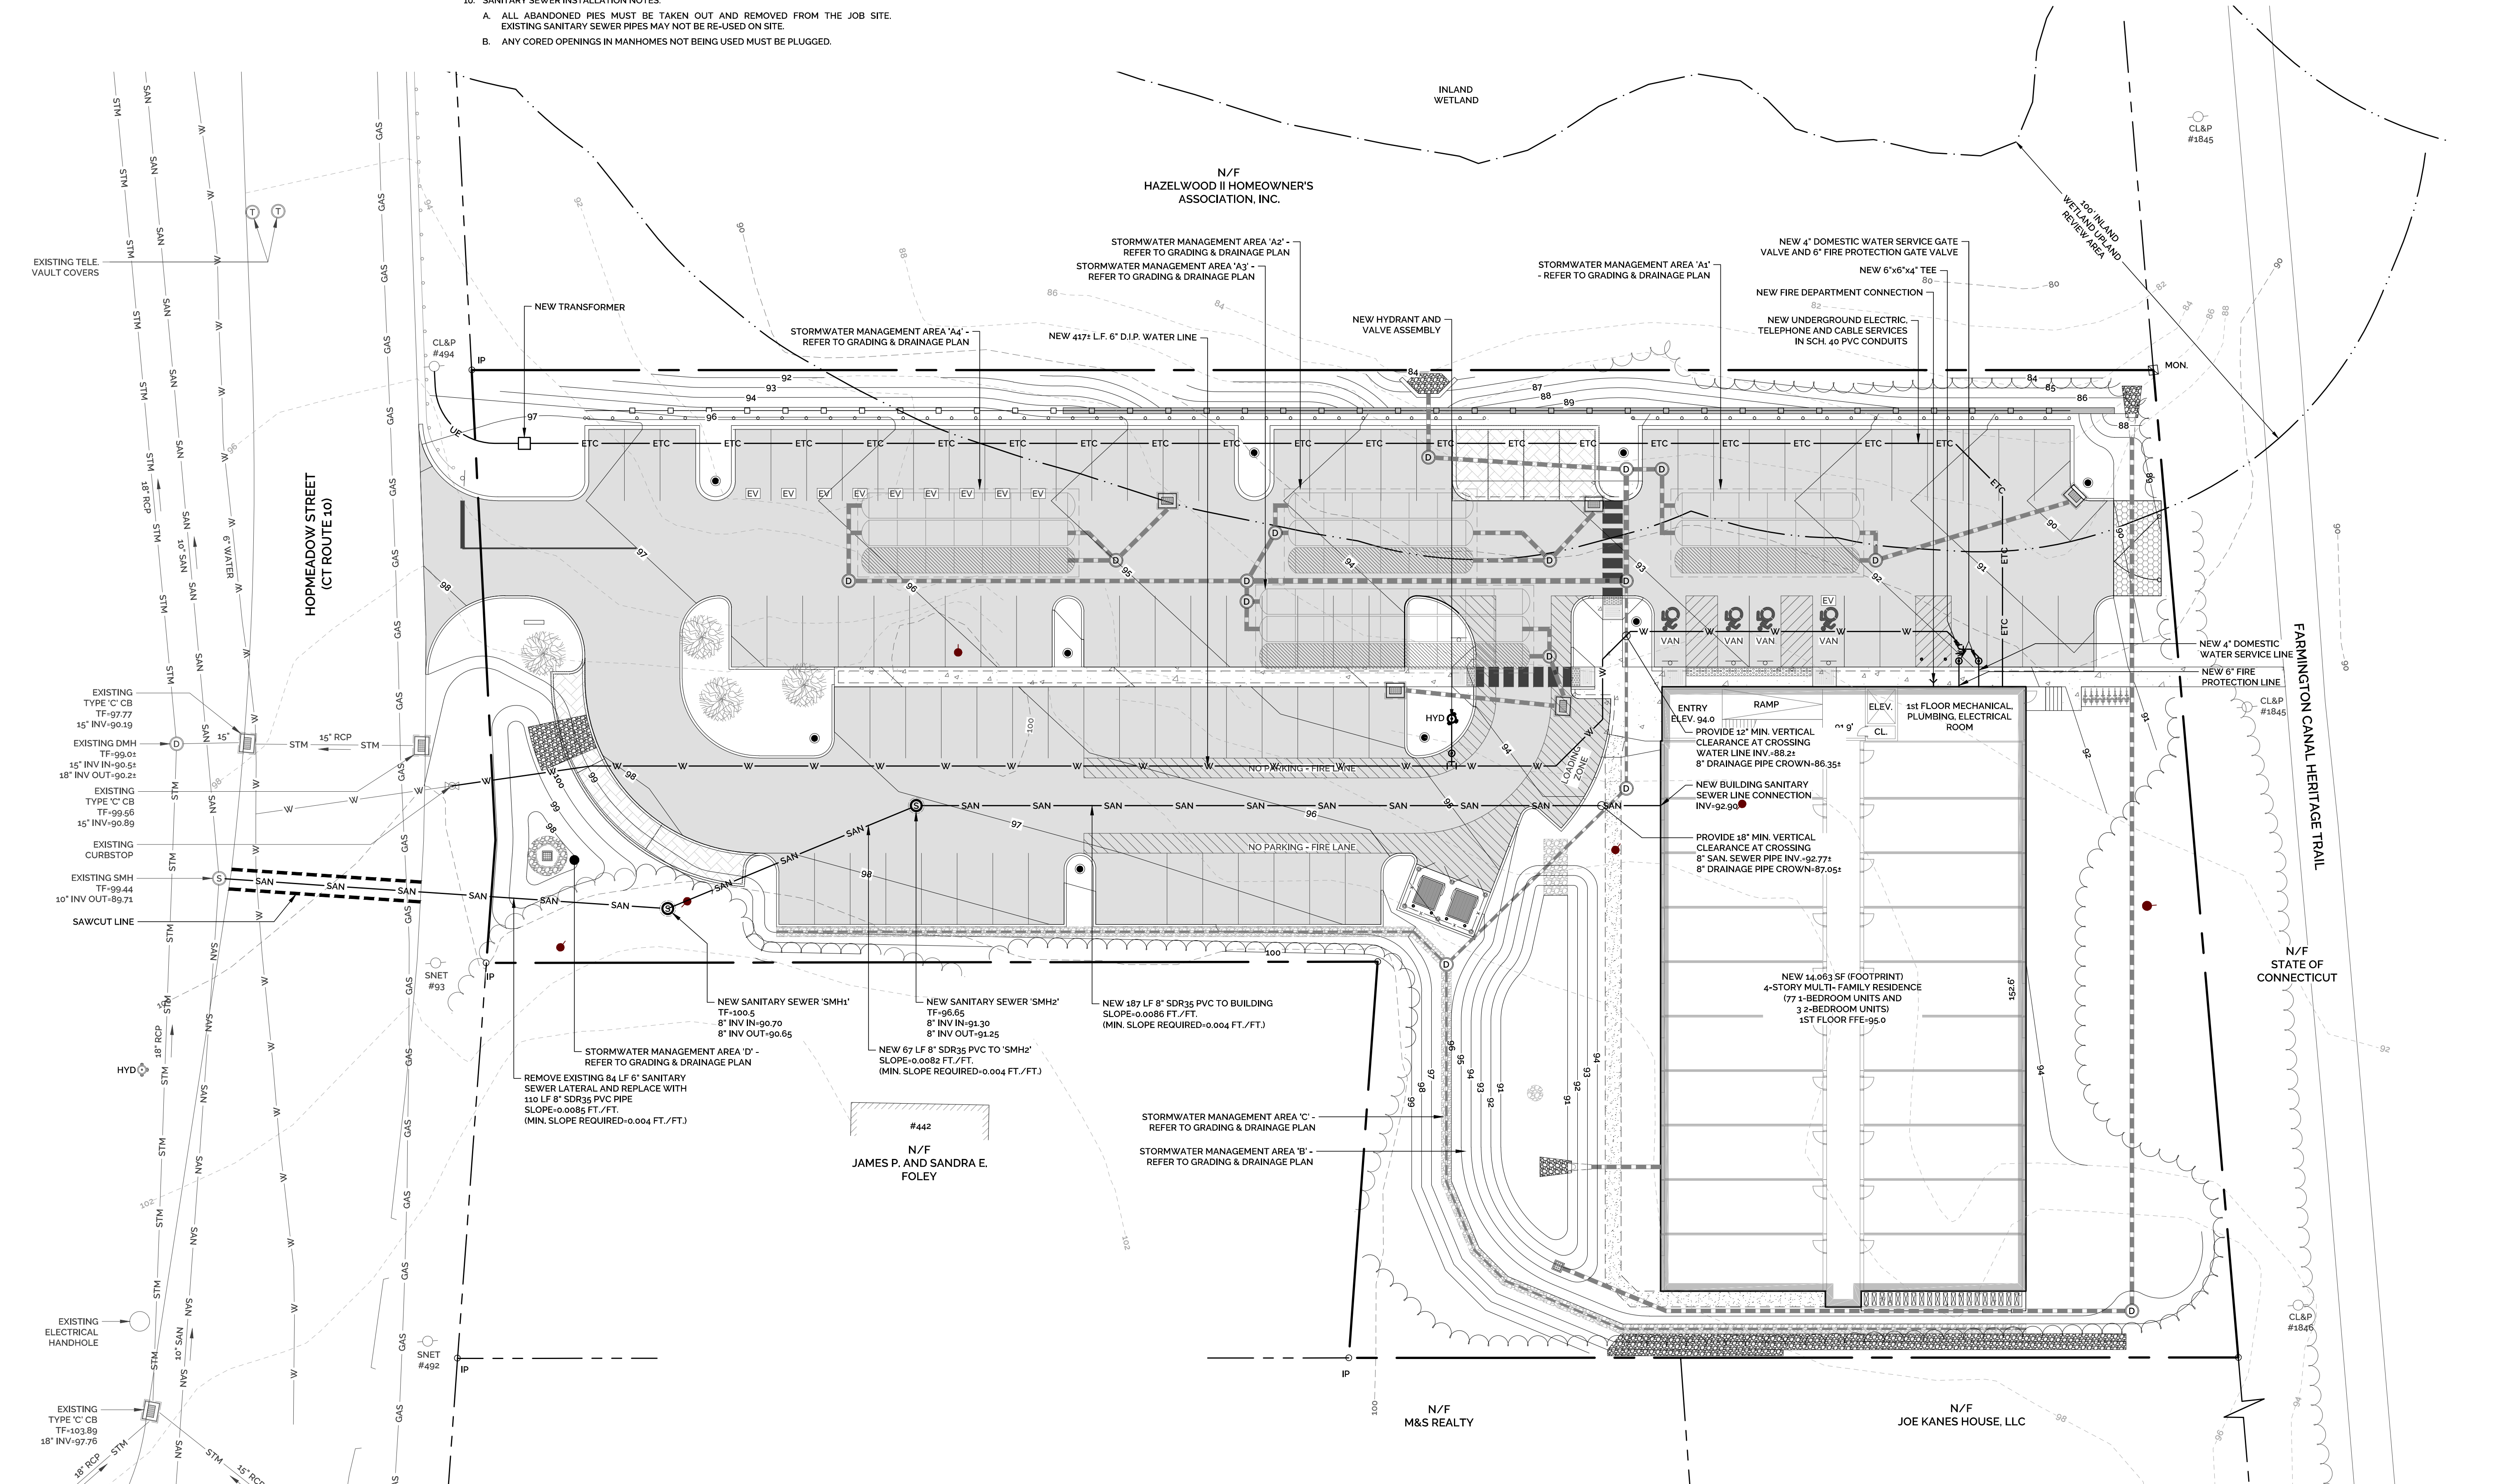

STAMP

REV	DATE	DESCRIPTION OF REVISION
3	3/30/2023	REVISIONS PER ENGINEERING REVIEW COMMENTS & IWA COMMENTS
2	3/17/2023	REVISIONS PER ENGINEERING REVIEW COMMENTS & IWA COMMENTS
1	2/24/2023	REVISIONS PER REVIEW COMMENTS

UTILITIES PLAN

VESSEL MULTI-FAMILY HOUSING
 PROPERTY ADDRESS
 446 HOPMEADOW STREET, SIMSBURY, CT 06089
 PREPARED FOR
VESSEL RE HOLDINGS, LLC
 46 WEST 55TH STREET, NEW YORK, NY 10019

UTILITY PLAN

SCALE IN FEET
 20 10 0 10 20
 1" = 20'

PROJECT NO. 2022-0013
 SCALE 1" = 20'
 DRAWN BY: SMM DATE 12/16/2022
 CHECKED BY: SMM DATE 12/16/2022

DRAWING
UT-1

SHEET NUMBER: 4 OF 12

Z:\SIMSBURY\ENGINEERING ASSOCIATES\PROJECTS\2022\0022-0013 - VESSEL - 446 HOPMEADOW ST. SIMSBURY\DWG\04 UTILITIES\Sheet UT-1.dwg Plot Date: 3/30/2023 11:30 AM Plotter: 3/30/2023 11:44 AM

SOIL EROSION & SEDIMENT CONTROL NOTES:

1. THE CONTRACTOR SHALL TAKE ALL NECESSARY MEASURES TO PROTECT ADJACENT PROPERTIES FROM ANY EROSION AND/OR SEDIMENTATION. REFER TO SOIL EROSION & SEDIMENT CONTROL PLAN AND NARRATIVE FOR PROPOSED SOIL EROSION & SEDIMENT CONTROL MEASURES.
2. REFER TO THE SOIL EROSION & SEDIMENT CONTROL NARRATIVE FOR ADDITIONAL INFORMATION.

GENERAL CONSTRUCTION NOTES:


1. THE LOCATIONS OF SUBSURFACE UTILITIES SHOWN HEREON ARE APPROXIMATE. THE ACTUAL LOCATION OF SUBSURFACE UTILITIES MAY VARY FROM THOSE INDICATED AND ALL UNDERGROUND UTILITIES MAY NOT BE SHOWN.
2. THE CONTRACTOR SHALL CONTACT "CALL BEFORE YOU DIG" AT 800-922-4455 TO MARK OUT ALL UNDERGROUND UTILITIES A MINIMUM OF 3 BUSINESS DAYS PRIOR TO COMMENCING ANY CONSTRUCTION ACTIVITY. CONTRACTOR SHALL VERIFY ALL LOCATIONS, DIMENSIONS AND ELEVATIONS OF ALL UTILITIES PRIOR TO CONSTRUCTION. IF UTILITIES DIFFER FROM THOSE SHOWN ON THIS PLAN, ENGINEER SHALL BE NOTIFIED.
3. ALL PROPERTY LINES SHALL BE VERIFIED IN THE FIELD. NO PRIVATE PROPERTY SHALL BE DISTURBED UNLESS PROPER RIGHTS ARE OBTAINED PRIOR TO CONSTRUCTION.
4. THE CONTRACTOR SHALL OBTAIN ALL REQUIRED PERMITS PRIOR TO CONSTRUCTION.
5. THE CONTRACTOR SHALL OBTAIN, REVIEW AND ADHERE TO ALL REQUIREMENTS AND ANY CONDITIONS OF APPROVAL OF THE TOWN OF SIMSBURY.
6. EXISTING DRAINAGE PATTERNS SHALL BE SUBSTANTIALLY MAINTAINED. THE CONTRACTOR SHALL GRADE THE PROPERTY IN SUCH A MANNER TO MAINTAIN EXISTING LOCAL DRAINAGE PATTERNS AND TO PREVENT EXCESS RUNOFF AND/OR PONDING ON ADJACENT PROPERTIES BOTH DURING AND AFTER CONSTRUCTION.
7. A CONNECTICUT DEPARTMENT OF TRANSPORTATION HIGHWAY ENCROACHMENT PERMIT IS REQUIRED FOR ALL IMPROVEMENTS, INCLUDING BUT NOT LIMITED TO APRONS, CURB CUTS, UTILITY LATERALS AND ROADWAY PAVEMENT PATCHING, WITHIN THE STATE RIGHT-OF-WAY.

STAMP

REV	DATE	DESCRIPTION OF REVISION	SHM	APPR.
3	3/30/2023	REVISIONS PER ENGINEERING REVIEW COMMENTS & IWA COMMENTS	SHM	
2	3/17/2023	REVISIONS PER ENGINEERING REVIEW COMMENTS & IWA COMMENTS	SHM	
1	2/24/2023	REVISIONS PER REVIEW COMMENTS	SHM	


SOIL EROSION & SEDIMENT CONTROL PLAN

VESSEL MULTI-FAMILY HOUSING
PROPERTY ADDRESS
446 HOPMEADOW STREET, SIMSBURY, CT 06089
PREPARED FOR
VESSEL RE HOLDINGS, LLC
46 WEST 55TH STREET, NEW YORK, NY 10019

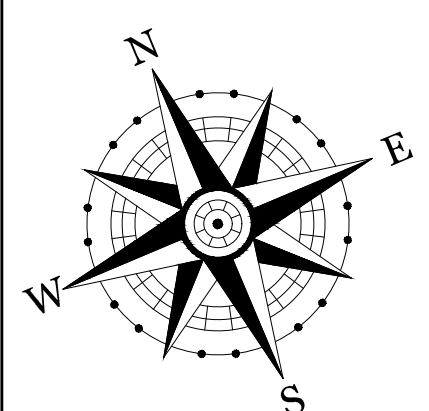

PROJECT NO: 2022-0013	SCALE: 1" = 20'
DRAWN BY: SMM	DATE: 12/16/2022
CHECKED BY: SMM	DATE: 12/16/2022

DRAWING
SE-1
SHEET NUMBER: 5 OF 12

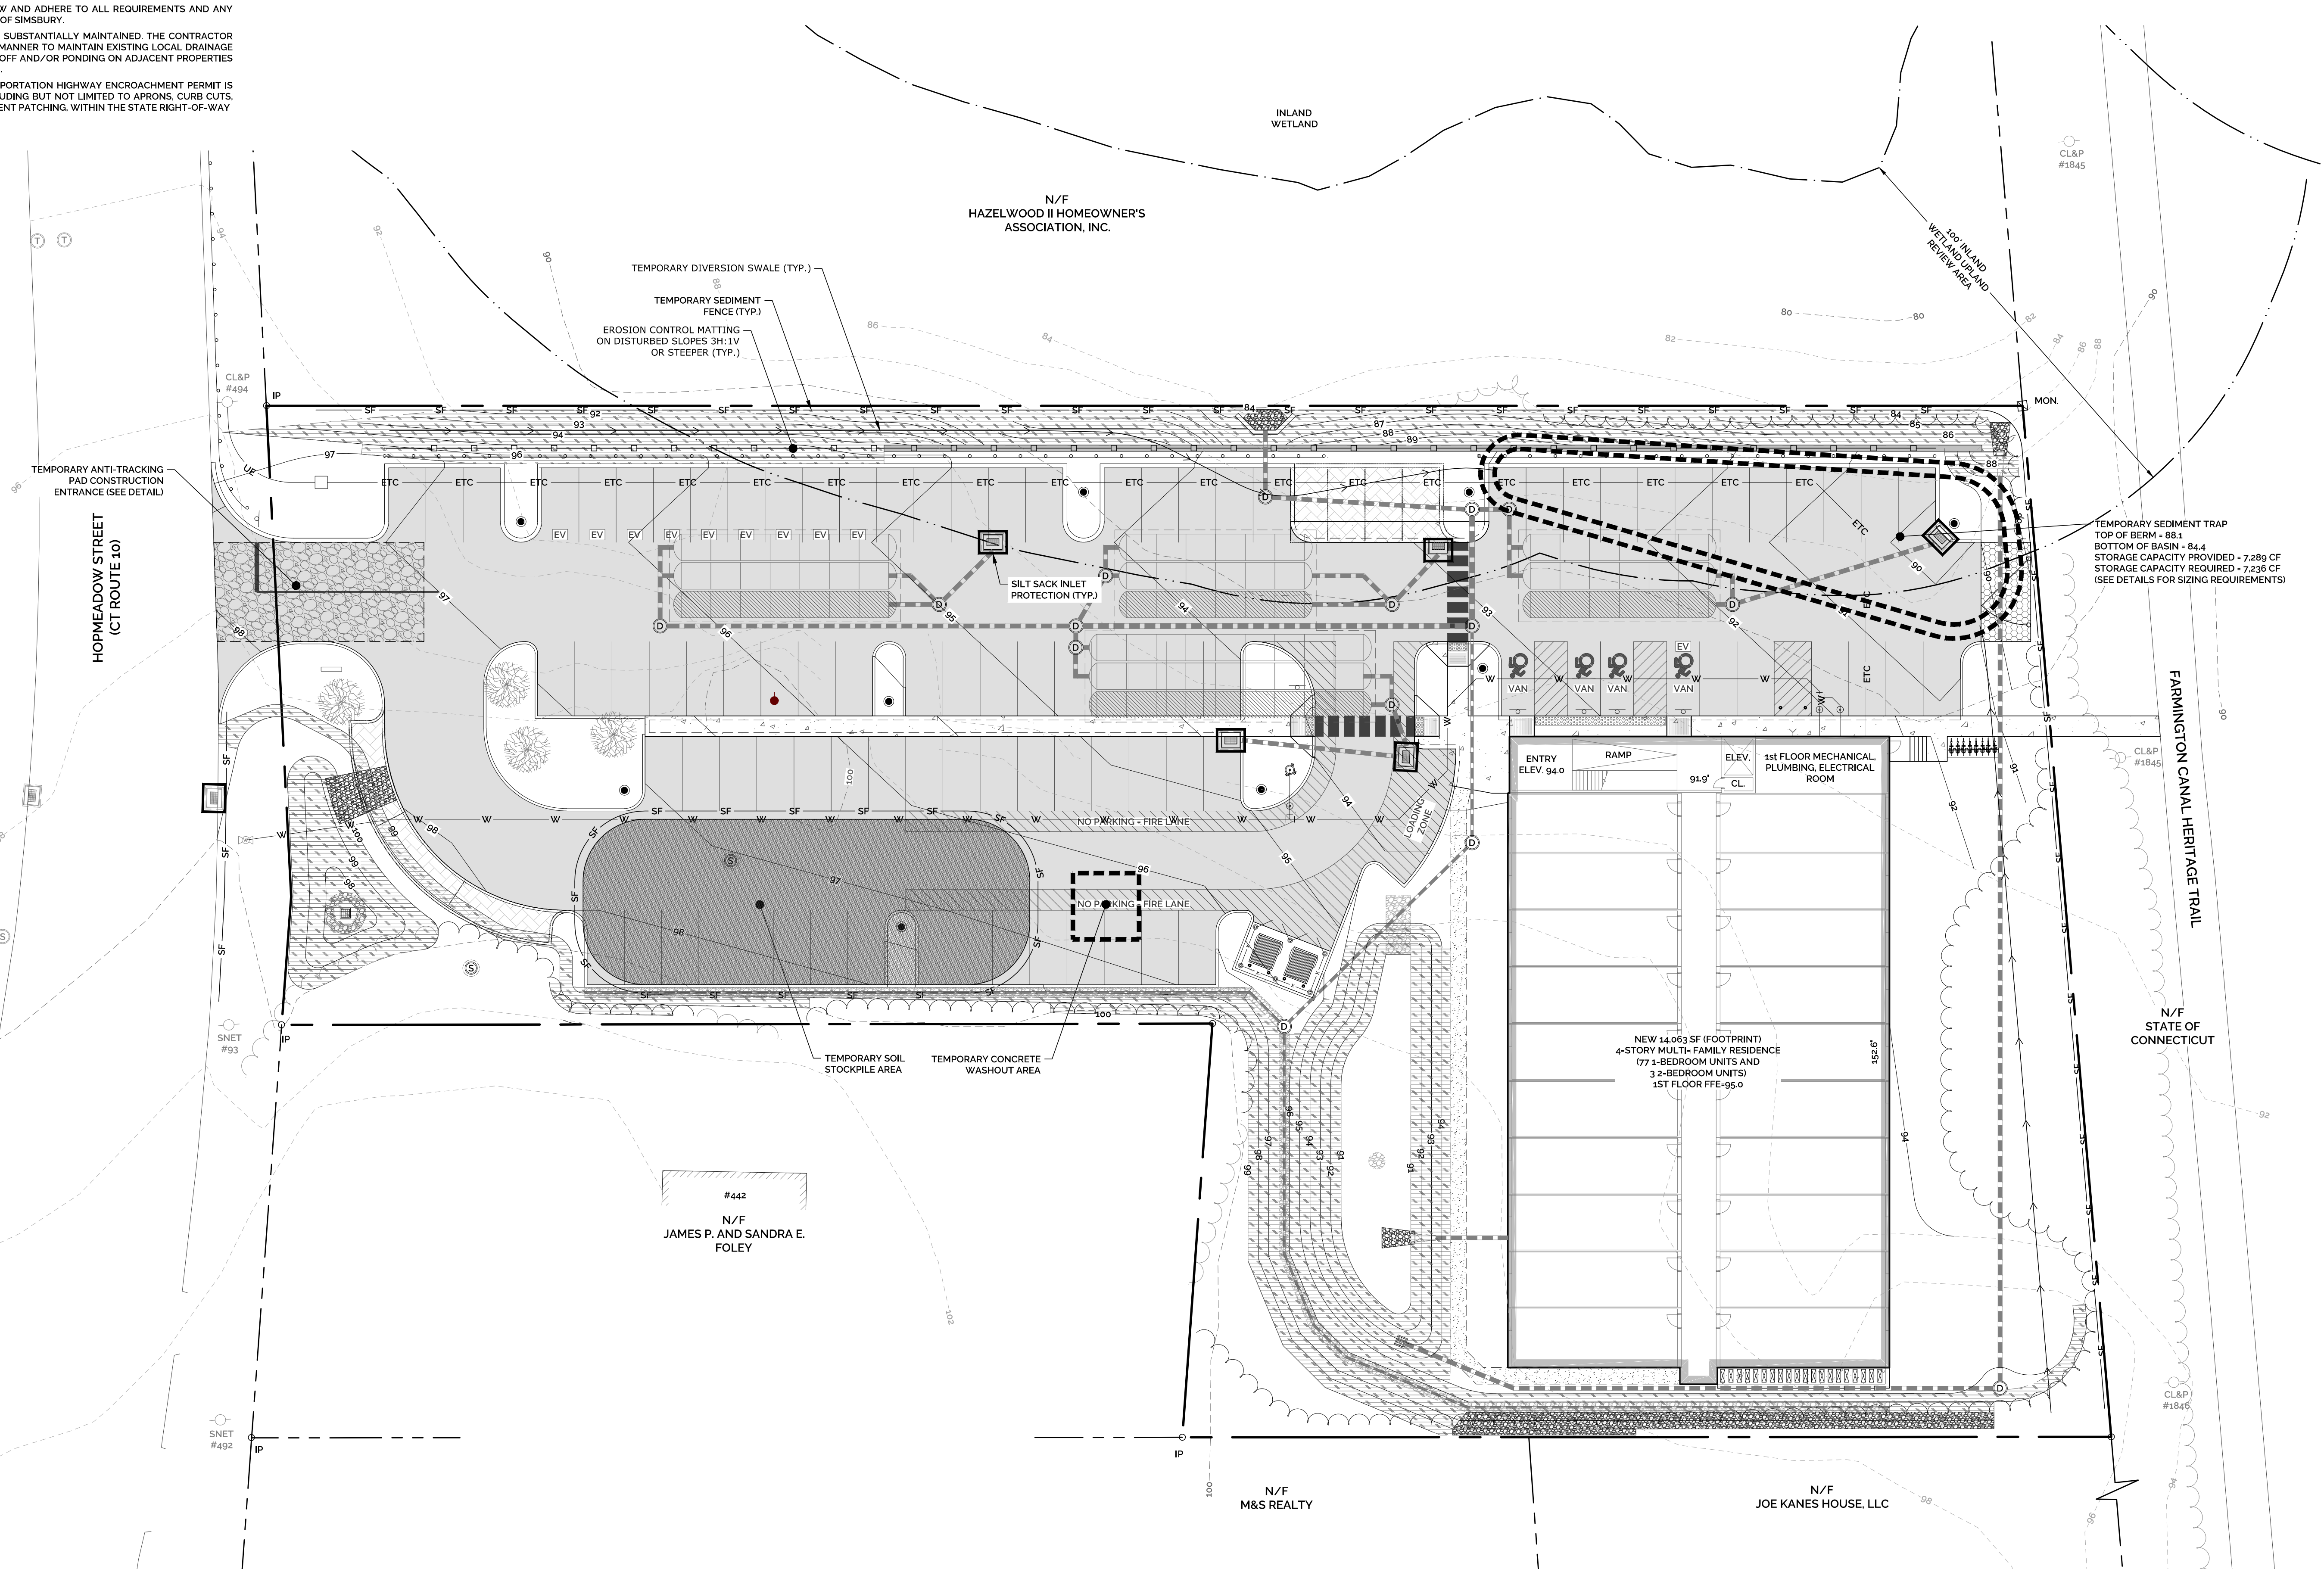

MERKUR
SOLAR OUTDOOR

photinus
brilliance in solar lighting

SPECIFICATIONS



Source LED
Efficiency 200lm/W
Power Max 100W
L80 Life > 75,000 hours
Location Label IP67
Solar Module Performance Monocrystalline silicon cells, processed by Photinus
 4 solar modules x 150 Vmp, modules also charge in cloudy conditions
Battery LiFePO4 / 42V, 9Ah (12.8 x 3.37Ah)
Operating Temperature -20°C to +60°C
Battery Life Up to 10 years
Protection Class IP68
Material Steel pole and aluminum parts
Finish Galvanized and powder coat
Weight 242.5 lb. (110kg)
Wind Load 65.3 mph, 90 mph**
Salt Spray Test ISO 9227:2012
Warranty 3 Years

*Vp = Watt Peak: maximum power supplied in standard conditions
 ** Other wind loads available upon request

ORDER CODE

Model	Modules	Head	C.C.T.	Optic	Time Management	Height	Wind Load	Mounting	Finish	Options
MERKUR	150 = 4 Solar Modules 150PLUS = 8 Solar Modules 300 = 8 Solar Modules	S = Single D = Dual	40 = Standard 4000K 20 = 3000K 30 = 3000K 50 = 3000K	ME PLACE T2 = 100° T2-L = 100° T3 = 100° T3-L = 100° T4 = 100° T4-B = 100° SCL DWCSCCL FW VM PX	V5 = Standard Setting V3 = Continuous lighting V4 = Night-time reduction to 40% V6 = Night-time reduction to 35%	HS = Standard Height W68 = Standard 68.3 mph HC = Custom** WC = Custom**	W68 = Standard 68.3 mph W90 = 90 mph WC = Custom**	FF = Pipe Foundation ABO = Anchor Base with Covering** ABC = Anchor Base Closed**	D = Dark Blnk = None PIR = PIR Sensor	

Example order code: MERKUR - 300 - S - 40 - DWCSCCL - V5 - HS - W90 - FF - D
 Merkur-Rev4-2022 +1 803 766 0481 info@photinus-lighting.us photinus-lighting.us 1


Calculation Summary

Label	CalcType	Units	Avg	Max	Min	Avg/Min	Max/Min
Site Calc	Illuminance	Fc	0.99	8.6	0.0	N.A.	N.A.

GENERAL NOTES:
 1. PHOTOMETRIC PLAN PROVIDED BY ILLUMINATE.

Luminaire Schedule

Symbol	Qty	Label	Arrangement	Total Lamp Lumens	LLF	Description
[Symbol]	5	T3	SINGLE	N.A.	0.900	Photinus Merkur-150-S-30-V5-HS-W90-xx-T3B
[Symbol]	1	T4	SINGLE	N.A.	0.900	Photinus Merkur-150-S-30-V5-HS-W90-xx-T4B
[Symbol]	3	T4 DOUBLE	BACK-BACK	N.A.	0.900	Photinus Merkur-150-D-30-V5-HS-W90-xx-T4B

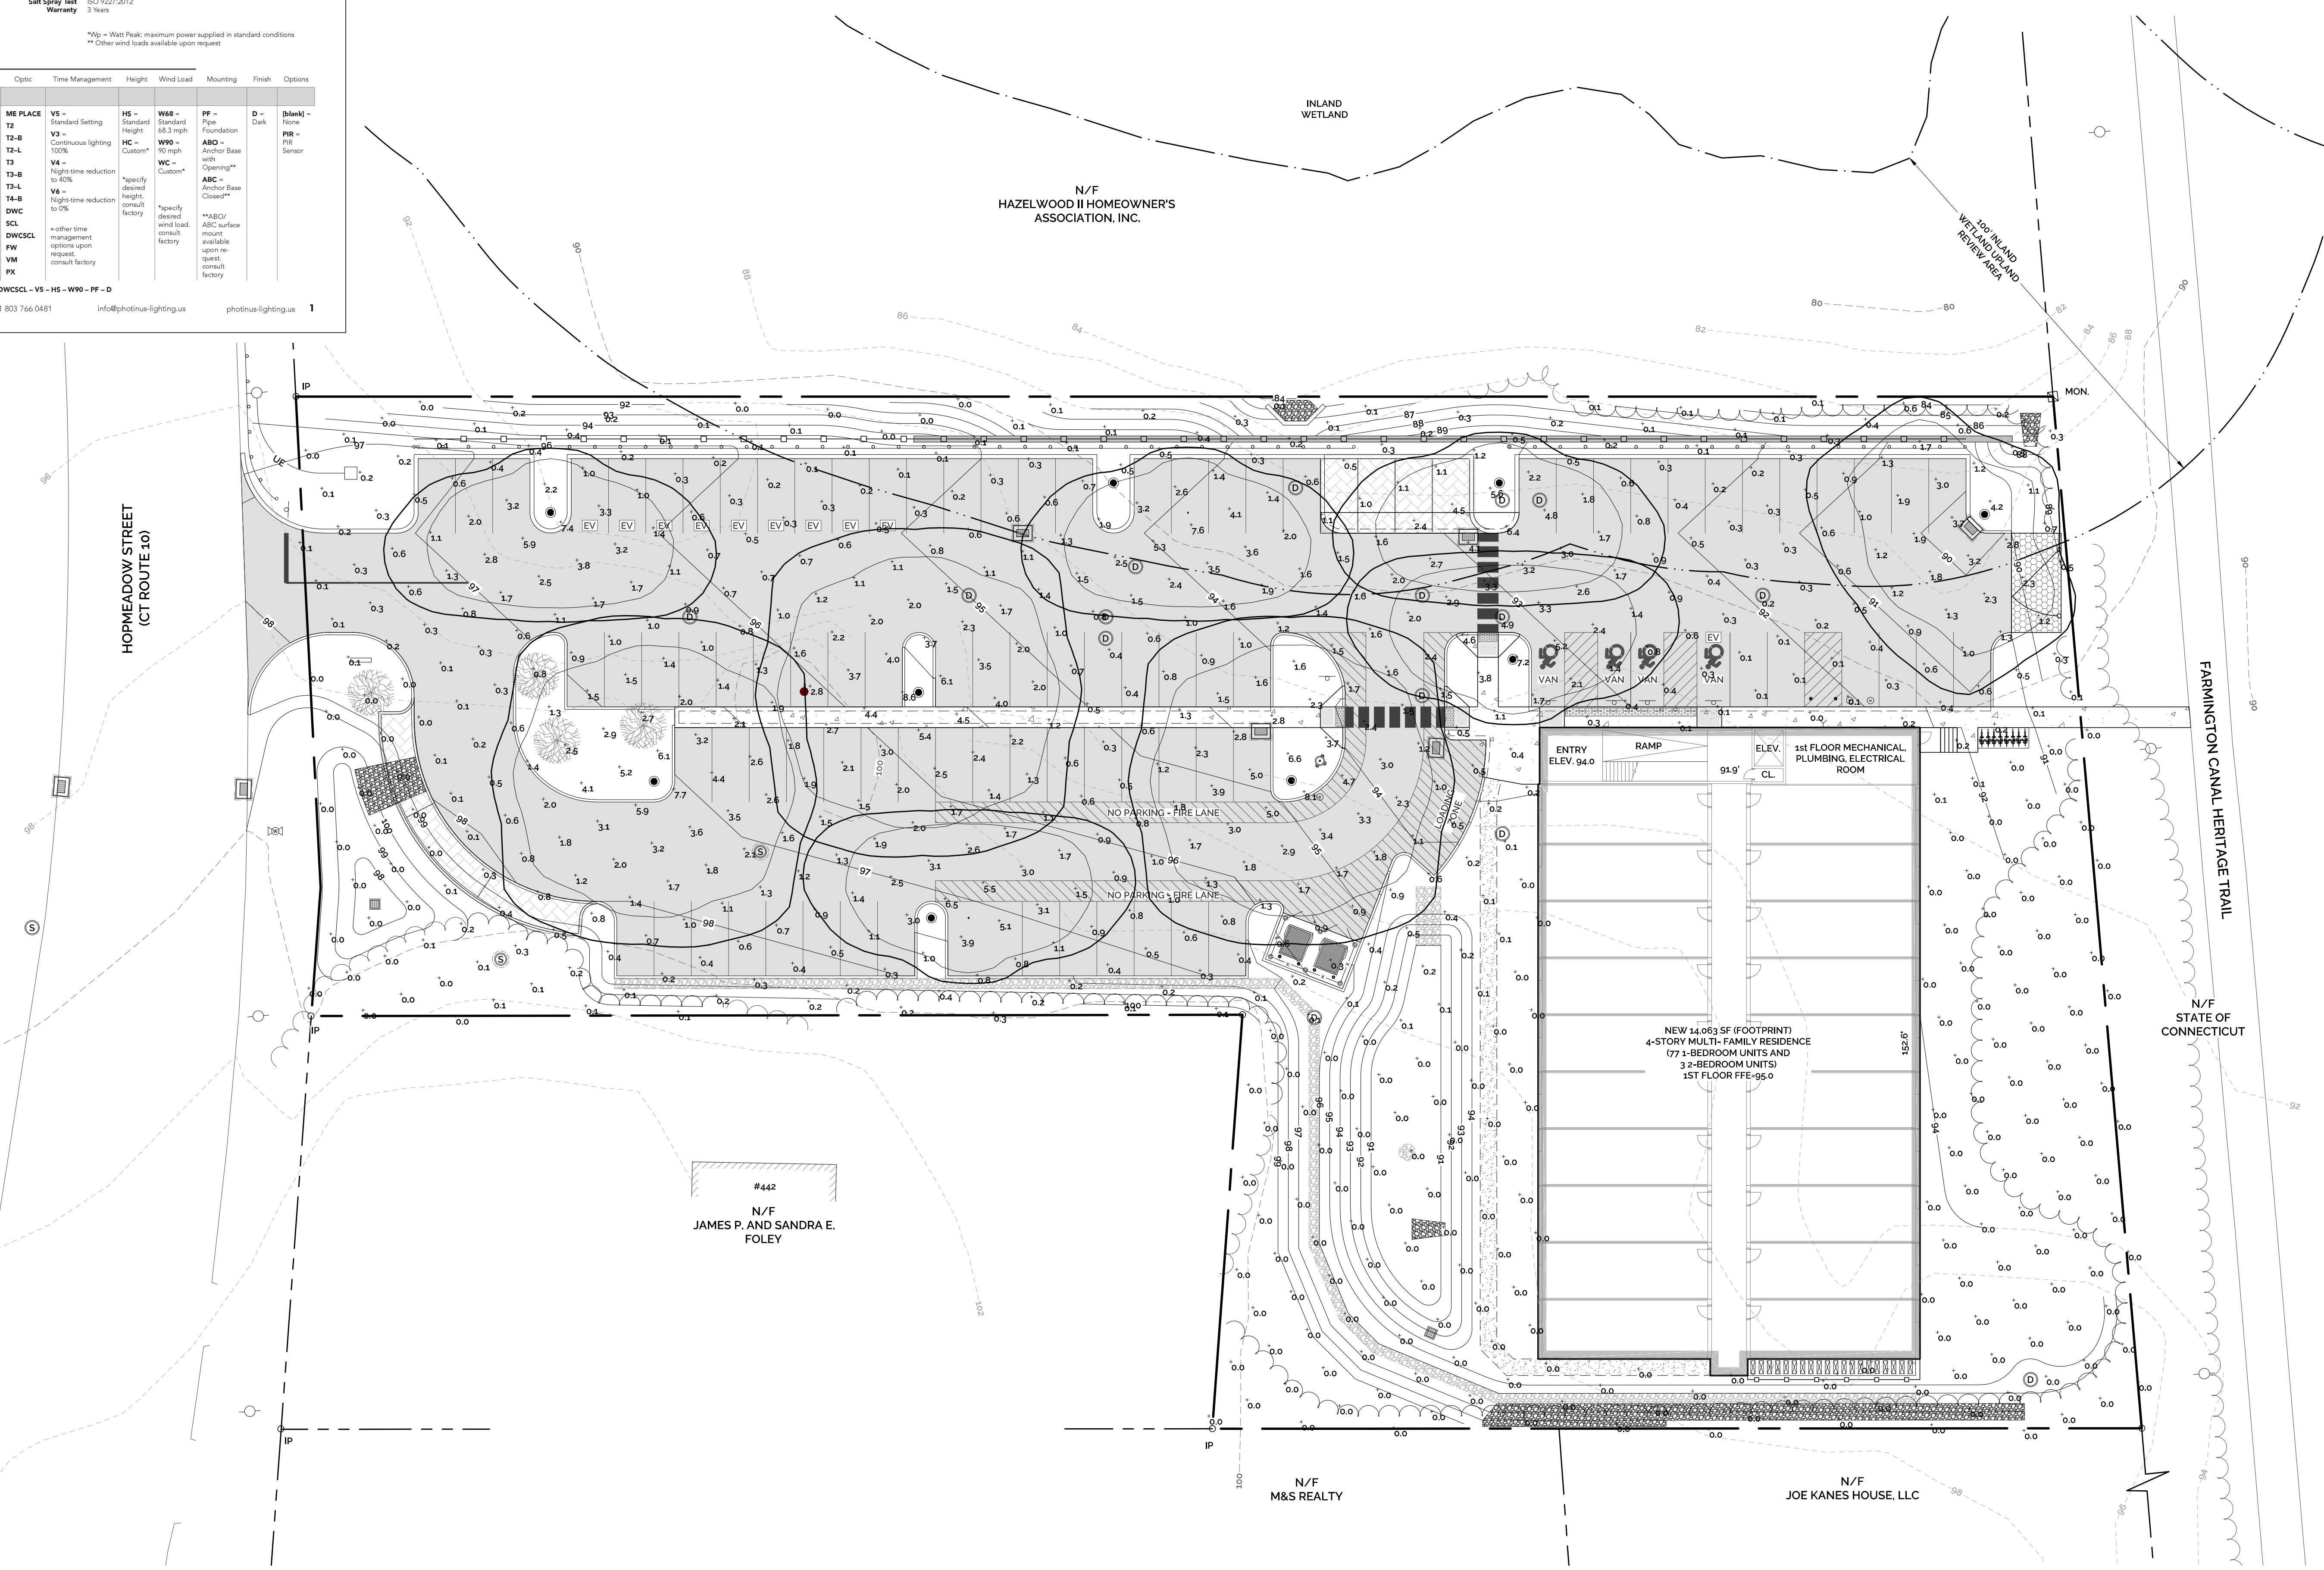

H+H ENGINEERING ASSOCIATES
 232 Greenmanville Avenue
 Suite 201
 Mystic, CT 06355
 860-980-8008 (C) 413-579-4488 (M)
 www.hh-engineers.com

STAMP

REV	DATE	DESCRIPTION OF REVISION	APPR.
3	3/30/2023	REVISIONS PER ENGINEERING REVIEW COMMENTS & IWA COMMENTS	SHM
2	3/17/2023	REVISIONS PER ENGINEERING REVIEW COMMENTS & IWA COMMENTS	SHM
1	2/24/2023	REVISIONS PER ENGINEERING COMMENTS	SHM

SITE PHOTOMETRIC PLAN
VESSEL MULTI-FAMILY HOUSING
 PROPERTY ADDRESS
 446 HOPMEADOW STREET, SIMSBURY, CT 06089
 PREPARED FOR
VESSEL RE HOLDINGS, LLC
 46 WEST 55TH STREET, NEW YORK, NY 10019

North Arrow

SCALE IN FEET
 20 10 0 10 20
 1" = 20'

PROJECT NO: 2022-0013	SCALE: 1" = 20'
DRAWN BY: SMM	DATE: 12/16/2022
CHECKED BY: SMM	DATE: 12/16/2022


DRAWING
SPP-1

SHEET NUMBER: 6 OF 12


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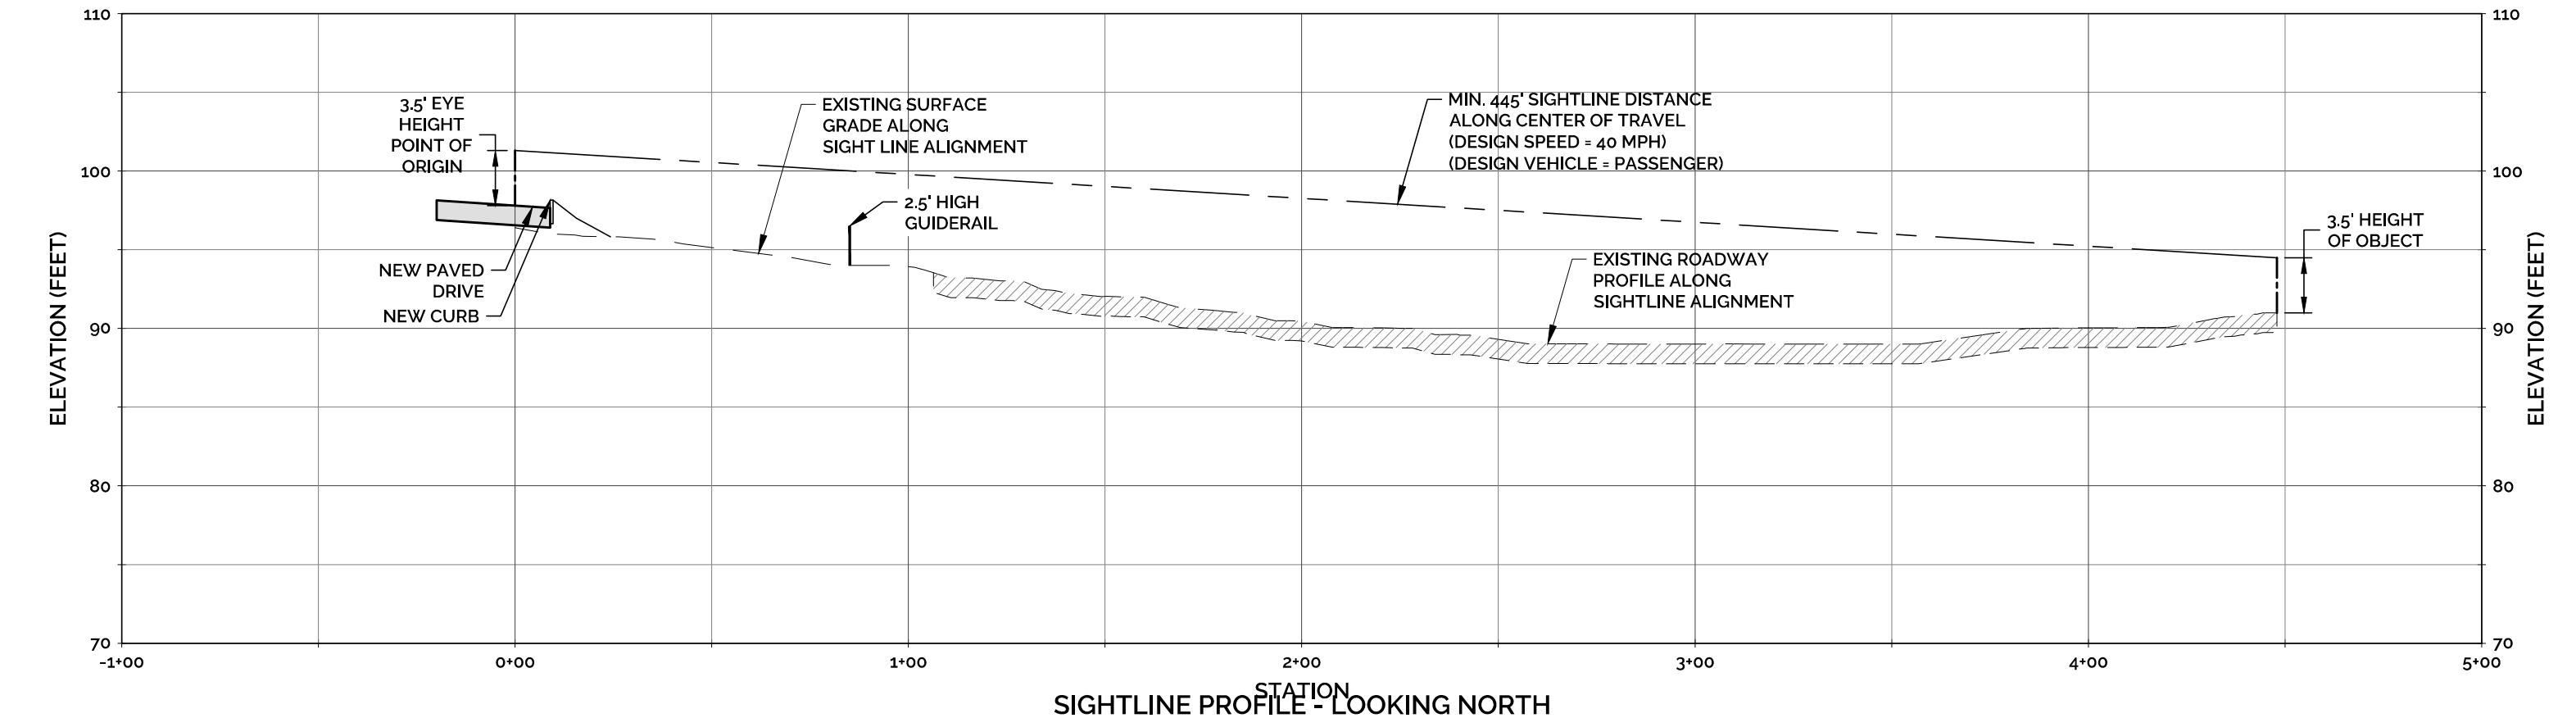
REV	DATE	DESCRIPTION OF REVISION
3	3/30/2023	REVISIONS PER ENGINEERING REVIEW COMMENTS & IWA COMMENTS
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1	2/24/2023	REVISIONS PER REVIEW COMMENTS



SIGHTLINE PLAN
SCALE: 1" = 40'

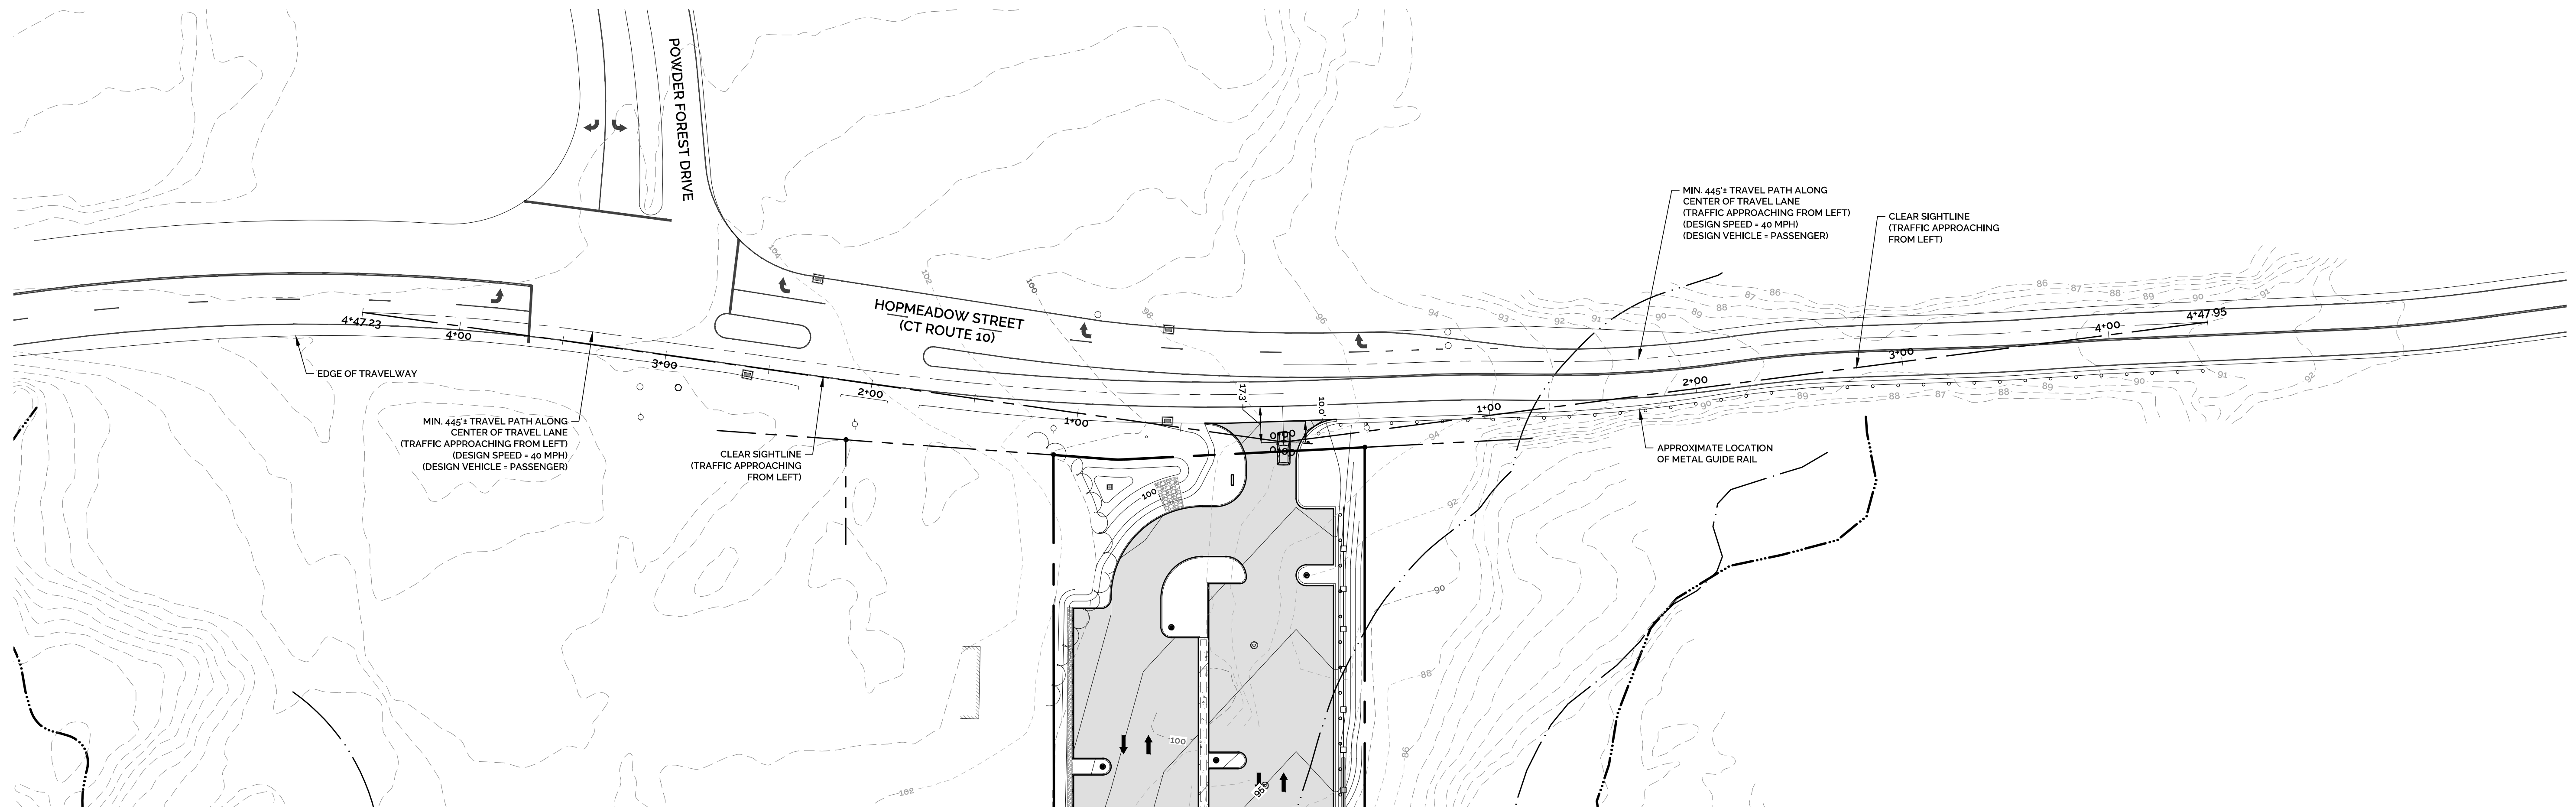


SIGHTLINE PROFILE - LOOKING SOUTH
HORIZONTAL SCALE: 1" = 40'
VERTICAL SCALE: 1" = 10'

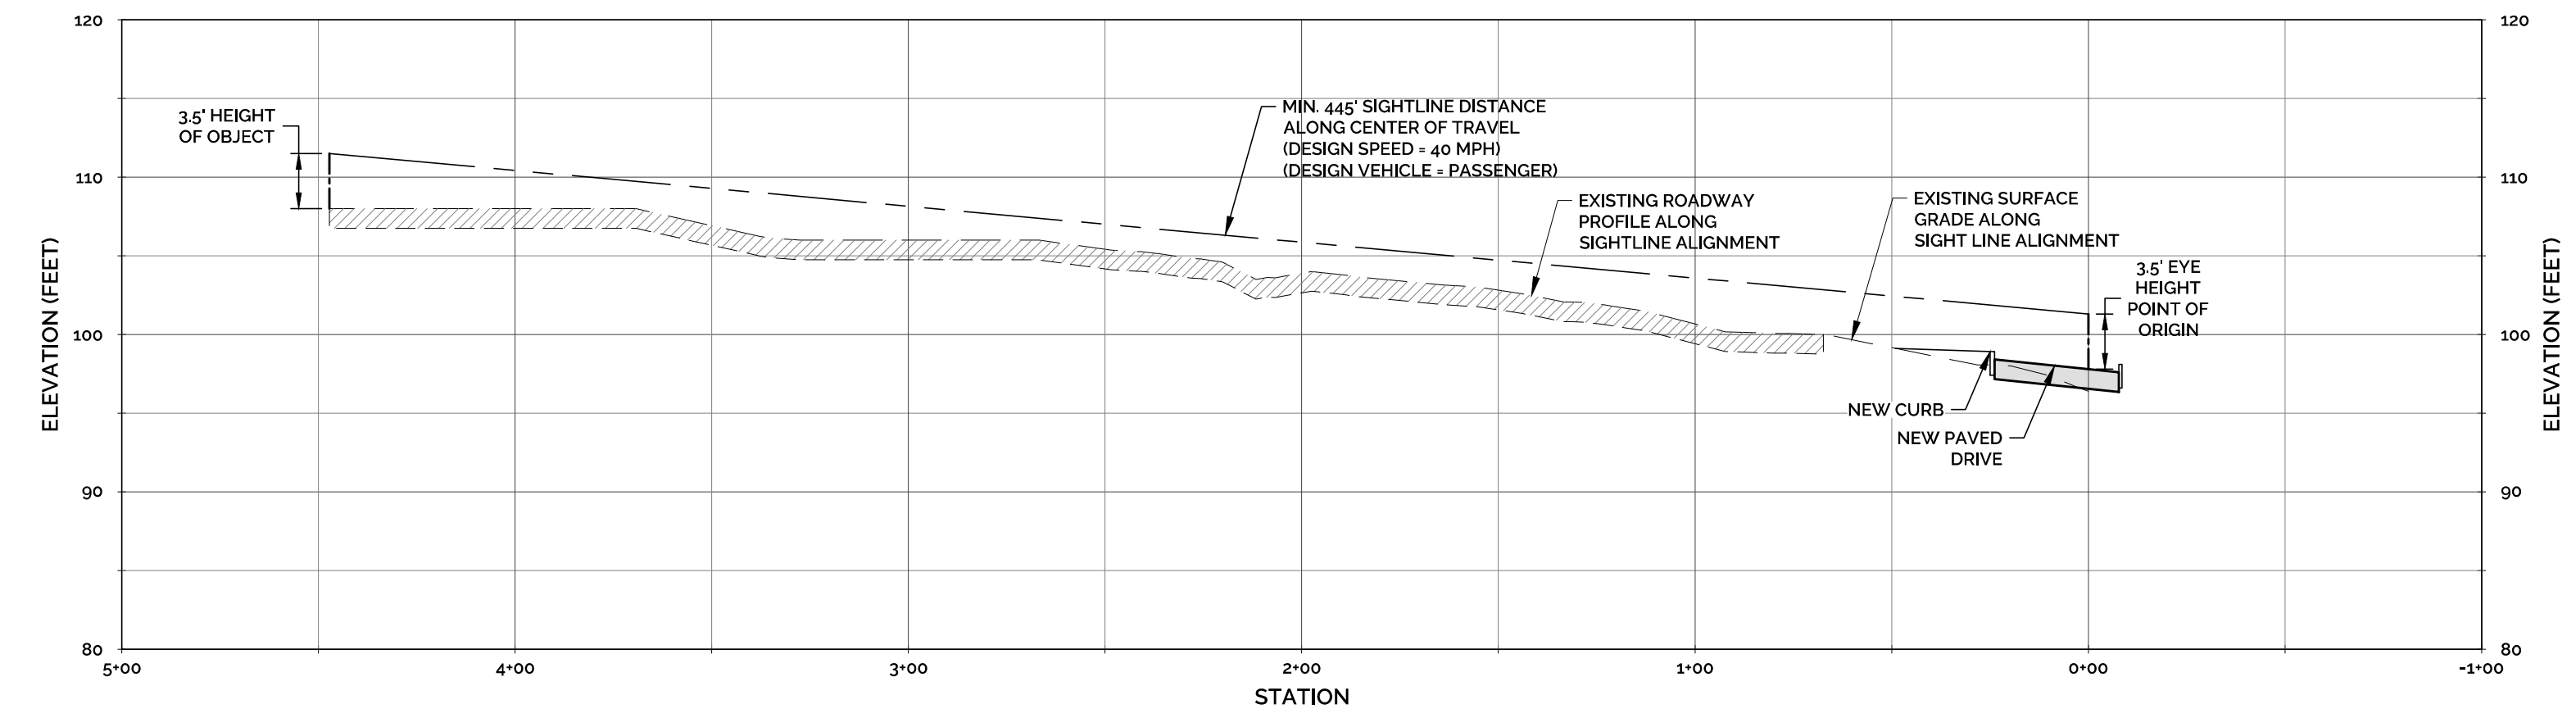

SIGHTLINE PROFILE - LOOKING NORTH
HORIZONTAL SCALE: 1" = 40'
VERTICAL SCALE: 1" = 10'

SIGHTLINE DEMONSTRATION PLAN
VESSEL MULTI-FAMILY HOUSING
PROPERTY ADDRESS
446 HOPMEADOW STREET, SIMSBURY, CT 06089
PREPARED FOR
VESSEL RE HOLDINGS, LLC
46 WEST 55TH STREET, NEW YORK, NY 10019

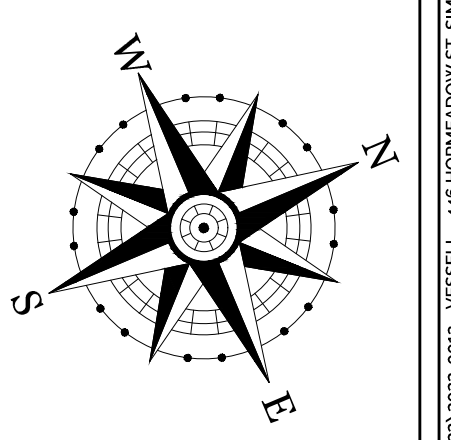

SCALE IN FEET
40 20 0 20 40

PROJECT NO. 2022-0013	SCALE 1" = 20'
DRAWN BY: SMM	DATE 12/16/2022
CHECKED BY: SMM	DATE 12/16/2022

DRAWING
ST-1
SHEET NUMBER: 7 OF 12

Z:\SHARED\H+H ENGINEERING ASSOCIATES\PROJECTS\2022\2022-0013 - VESSEL - 446 HOPMEADOW ST, SIMSBURY\DWGS\07-SIGHTLINE DEMONSTRATION PLAN\DWG Tab: SIGHTLINE_Sheets 3/30/2023 11:52 AM

SOIL EROSION & SEDIMENTATION CONTROL PLAN:

PROJECT DESCRIPTION

- 1. THE APPLICANT IS PROPOSING TO DEMOLISH THE EXISTING BUILDING AND IMPROVEMENTS AND CONSTRUCT A NEW FOUR-STORY, 140,963 SQ. FT. MULTI-FAMILY RESIDENTIAL BUILDING... 2. THE TOPOGRAPHY IS MODERATE, SLOPING DOWN FROM ELEVATION 102.2 ALONG THE SOUTHERN PROPERTY LINE...

GENERAL SECC REQUIREMENTS

- 1. THE SITE CONTRACTOR MUST FOLLOW ALL GUIDELINES SET FORTH IN THE MANUAL ENTITLED "2002 CONNECTICUT GUIDELINES FOR SOIL EROSION AND SEDIMENT CONTROL" PUBLISHED BY THE CONNECTICUT COUNCIL ON SOIL AND WATER CONSERVATION... 2. SECC MEASURES INTENDED TO MINIMIZE SOIL EROSION AND TO CONTROL SEDIMENTATION DURING CONSTRUCTION INCLUDE:

CONSTRUCTION SEQUENCE

- 1. CONTACT "CALL BEFORE YOU DIG" TO MARK OUT ALL UTILITY LOCATIONS PRIOR TO ANY CONSTRUCTION ACTIVITIES. 2. ENSURE ALL LAND USE PERMITS HAVE BEEN SECURED. OBTAIN ALL NECESSARY PERMITS. 3. INSTALL TEMPORARY CONSTRUCTION ENTRANCE, SEDIMENT FENCE AND/OR HAYBALE BARRIERS AS SHOWN ON THE SECC PLAN.

TRENCH EXCAVATION AND BACKFILL

- 1. THE CONTRACTOR SHALL PROPERLY MAINTAIN ALL BACKFILLED EXCAVATIONS, ANY DEPRESSIONS DUE TO SETTLING IN THESE AREAS SHALL BE FILLED AND RESEDED AS NECESSARY. 2. THE WIDTH OF ALL EXCAVATED TRENCHES SHALL BE KEPT AS NARROW AS PRACTICABLE TO ACCOMMODATE THE WORK...

VEGETATIVE TURF ESTABLISHMENT PROCEDURE

- 1. SCARIFY ALL AREAS TO BE TOPSOILED AND SEEDED. APPLY A MINIMUM OF 1/4 INCHES OF TOPSOIL ON ALL AREAS TO BE SEEDED. APPLY GRASS SEED, LIME, FERTILIZER AND MULCH ACCORDING TO THE FOLLOWING SCHEDULE. 2. PERMANENT SEED MIXTURE:

MAINTENANCE OF EROSION CONTROL DEVICES:

HAYBALE BARRIERS/GEOTEXTILE SILT FENCES

- 1. INSPECT HAY BALE BARRIERS/GEOTEXTILE SILT FENCE AT LEAST ONCE A WEEK AND WITHIN 24 HOURS AFTER THE END OF A STORM WITH A RAINFALL AMOUNT OF 1/2" OR GREATER TO DETERMINE MAINTENANCE NEEDS. 2. REMOVE SEDIMENT DEPOSITS OR INSTALL A SECONDARY BARRIER/FENCE WHEN SEDIMENT DEPOSITS REACH APPROXIMATELY ONE HALF HEIGHT OF THE BARRIER/FENCE.

CONSTRUCTION ENTRANCES AND ROADWAYS

- 1. MAINTAIN THE ENTRANCE IN A CONDITION WHICH WILL PREVENT TRACKING AND WASHING OF SEDIMENTS ONTO PAVED SURFACES. 2. PROVIDE PERIODIC TOP DRESSING AND ADDITIONAL STONE OR LENGTH AS NECESSARY.

TEMPORARY SEDIMENT TRAP



- 1. INSPECTIONS SHALL BE AT SAME INTERVALS AS THE HAYBALE BARRIER/SILT FENCE INSPECTION SCHEDULE. 2. OUTLET SHALL BE CHECKED FOR INTEGRITY; HEIGHT OF THE STONE OUTLET SHALL BE MAINTAINED AT ONE FOOT BELOW CREST OF EMBANKMENT.

TEMPORARY DIVERSION DITCHES/SWALES

- 1. WHEN THE TEMPORARY DIVERSION IS LOCATED IN CLOSE PROXIMITY TO ONGOING CONSTRUCTION ACTIVITIES, INSPECT AT THE END OF EACH DAY AND IMMEDIATELY REPAIR DAMAGES. 2. REPAIR THE DIVERSION WITHIN 24 HOURS OF ANY OBSERVED FAILURE.



CONCRETE WASHOUT AREA

- 1. WASHOUT AREA TO BE INSPECTED AT LEAST ONCE A WEEK FOR STRUCTURAL INTEGRITY, ADEQUATE HOLDING CAPACITY AND CHECKED FOR LEAKS, TEARS, OR OVERFLOWS. 2. HARDENED CONCRETE WASTE SHOULD BE REMOVED AND DISPOSED OF WHEN THE WASTE HAS ACCUMULATED TO HALF OF THE CONCRETE WASHOUT'S DEPTH.

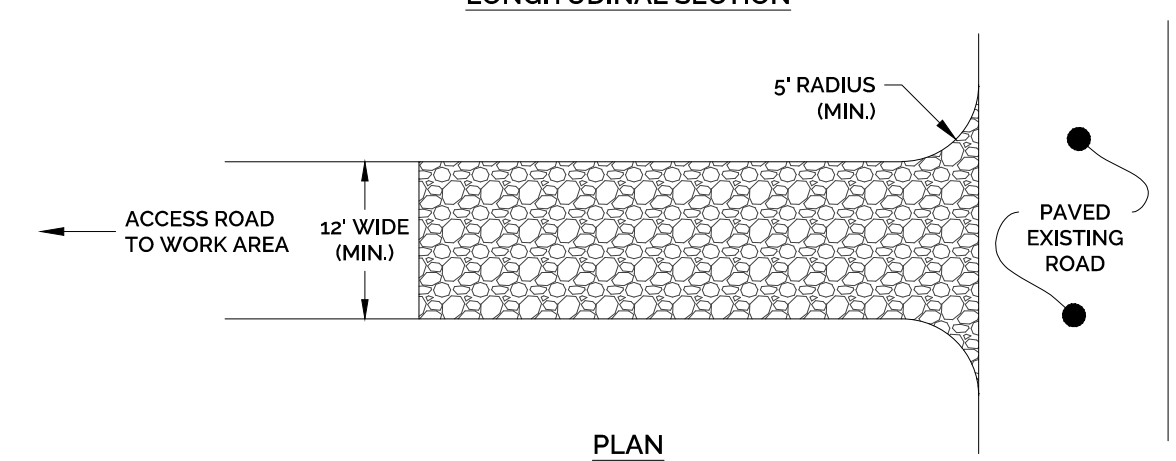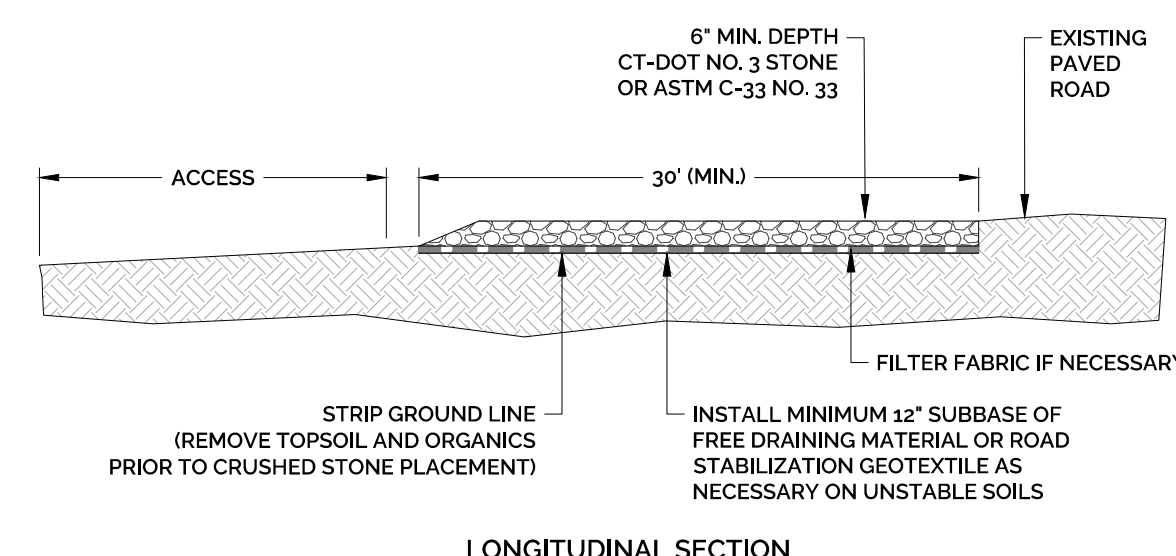

NOTE: ALL ANTI-TRACKING PADS SHALL BE INSTALLED AND MAINTAINED IN ACCORDANCE WITH 2002 CT GUIDELINES FOR SOIL EROSION & SEDIMENT CONTROL AS AMENDED.

ANTI-TRACKING PAD DETAIL

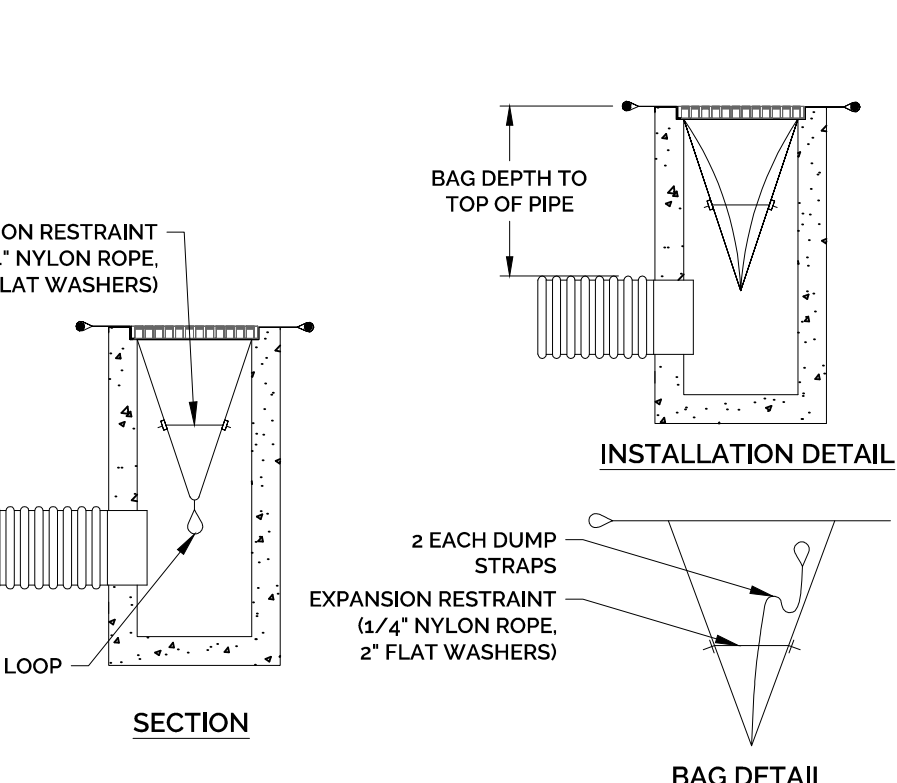
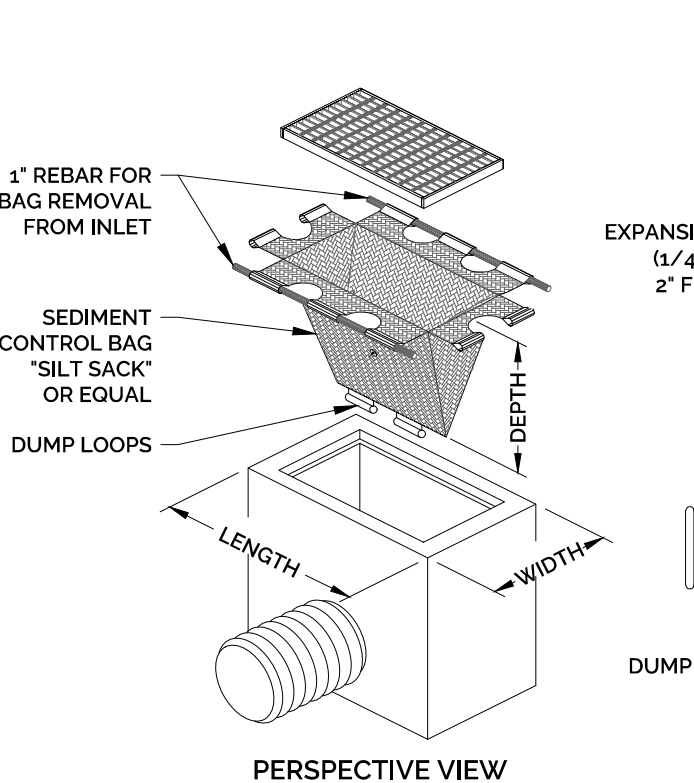


- NOTES: 1. THE CONTRACTOR IS RESPONSIBLE FOR PROVIDING THE CORRECT SIZE DEVICE FOR EACH INLET. FOR NON-STANDARD CATCH BASINS AND INLETS, THE CONTRACTOR SHALL MEASURE DIMENSIONS IN THE FIELD AND ORDER THE APPROPRIATE SIZE(S). 2. THE INLET SEDIMENT CONTROL DEVICE SHALL BE OF HIGH FLOW DESIGN (200 GAL./MIN./FT.) AS PER THE MANUFACTURER'S SPECS.


CATCH BASIN FILTER (SILT SACK) DETAIL



Summary of Temporary Sediment Trap Sizing Calculations table with columns for Item, Drainage Area (Acres), Total Storage Volume Required (CF), Wet Storage Volume Required (CF), and Dry Storage Volume Required (CF).

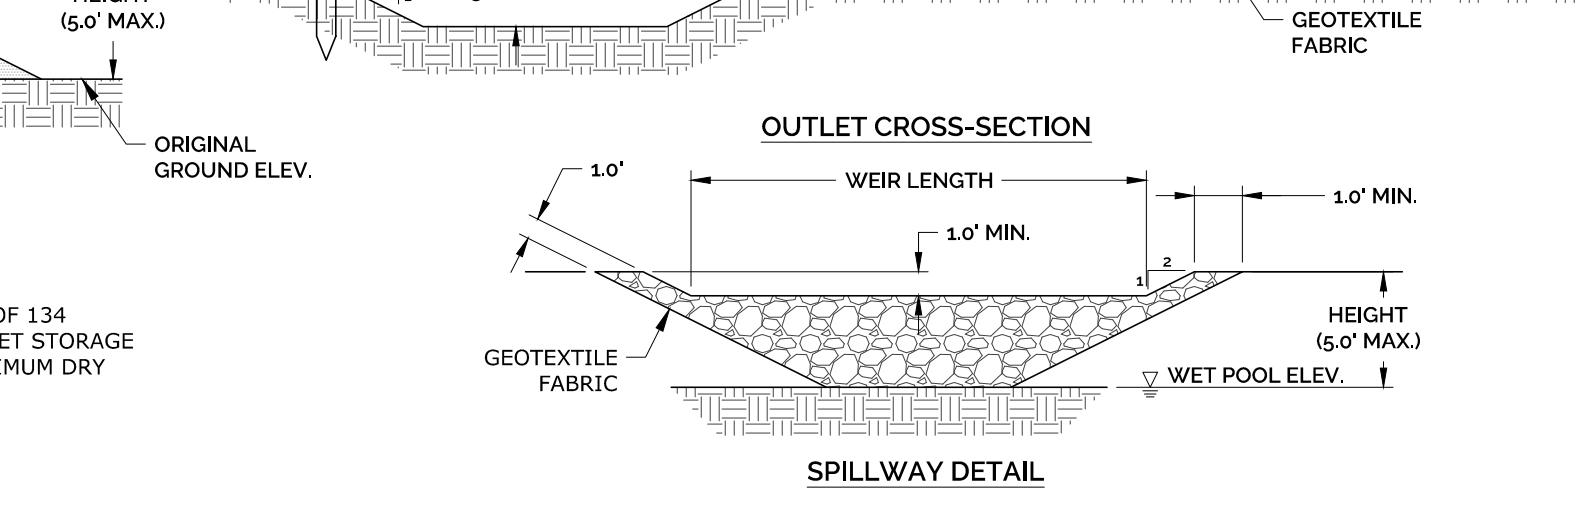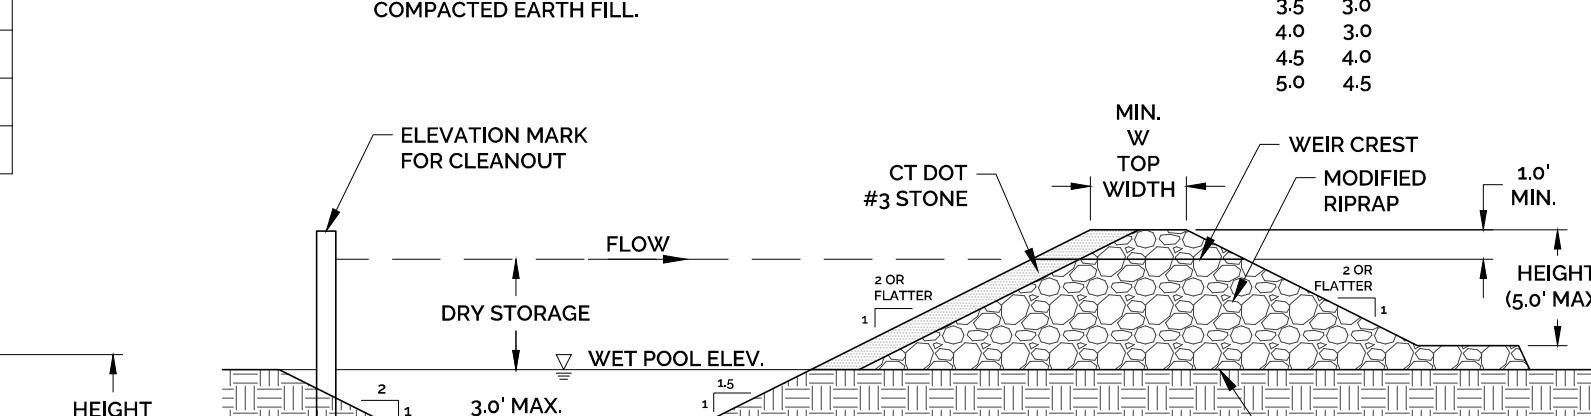


TEMPORARY SEDIMENT TRAP DETAIL NOT TO SCALE

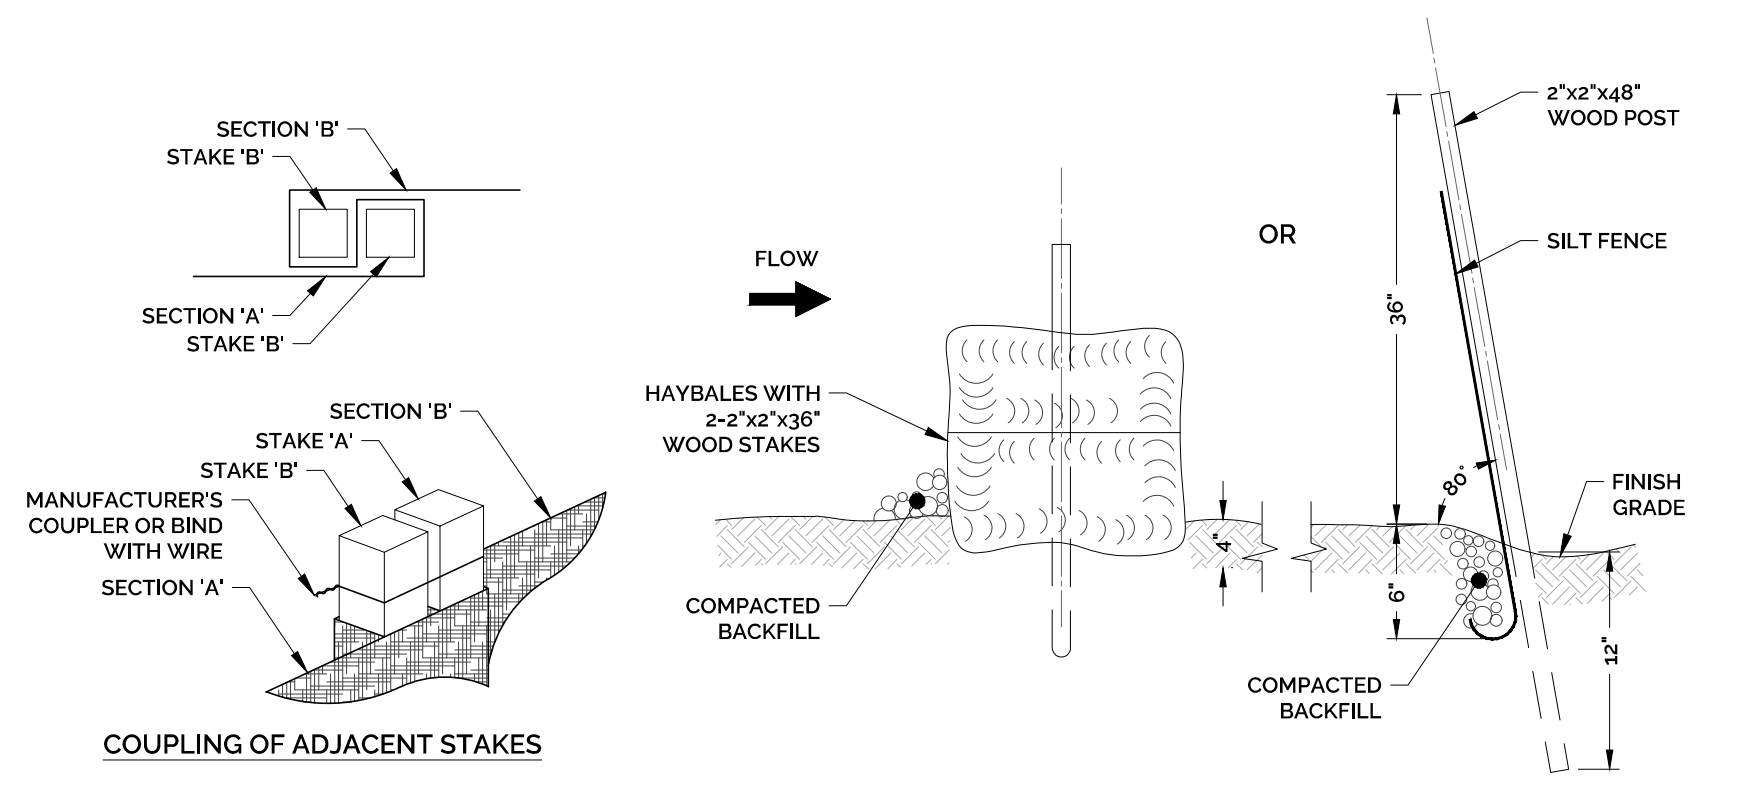


- INSTALLATION NOTES FOR HAY BALES: 1. PLACE HAY BALES ON CONTOUR AND WITH LAST HAY BALES UPSLOPE TO THAT TOP OF LAST SEVERAL HAY BALES ARE HIGHER THAN LINE OF HAY BALES. 2. EXCAVATE TRENCH 4" MIN. AND PLACE FILL UPSLOPE OF TRENCH.

TYPICAL SEDIMENT BARRIER DETAIL

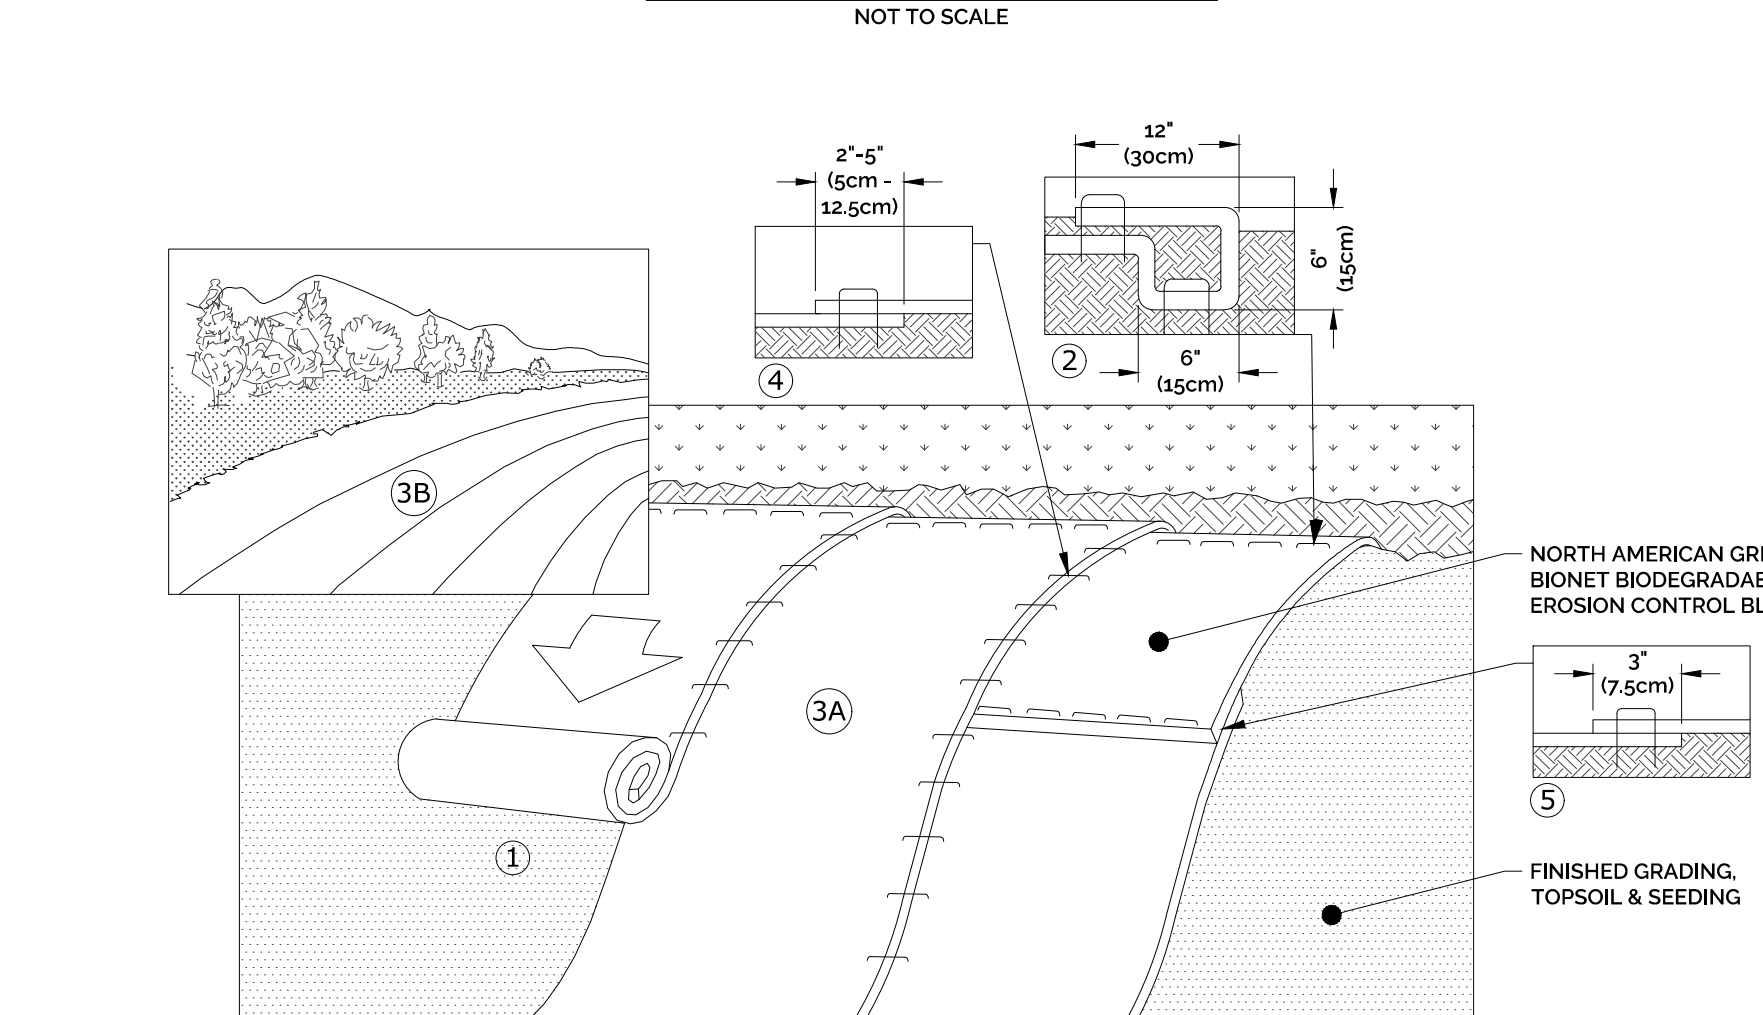


- NOTES: 1. PREPARE SOIL BEFORE INSTALLING BLANKETS, INCLUDING ANY NECESSARY APPLICATION OF LIME, FERTILIZER, AND SEED. 2. BEGIN AT THE TOP OF THE SLOPE BY ANCHORING THE BLANKET IN A 6" (15cm) DEEP x 6" (15cm) WIDE TRENCH.

EROSION CONTROL BLANKET DETAIL

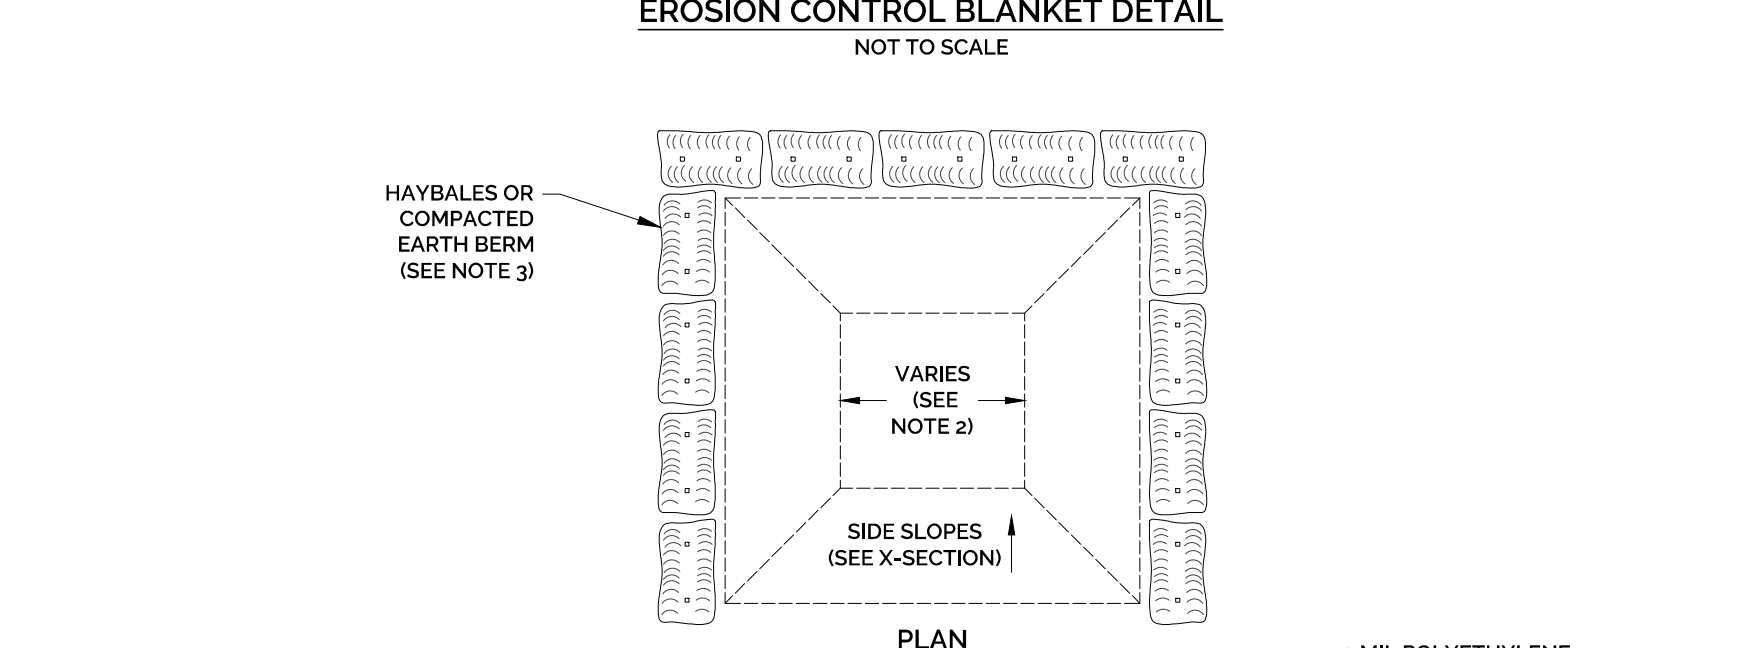

- NOTES: 1. CONCRETE WASHOUT AREA(S) SHALL BE INSTALLED PRIOR TO CONCRETE PLACEMENT ON SITE. THE CONCRETE WASHOUT AREA SHALL BE ENTIRELY SELF-CONTAINED. 2. THE CONTRACTOR SHALL SUBMIT THE DESIGN, LOCATION AND SIZING OF THE CONCRETE WASHOUT AREA(S) WITH THE PROJECT'S EROSION & SEDIMENTATION CONTROL PLAN AND SHALL BE APPROVED BY THE ENGINEER.

CONCRETE WASHOUT AREA

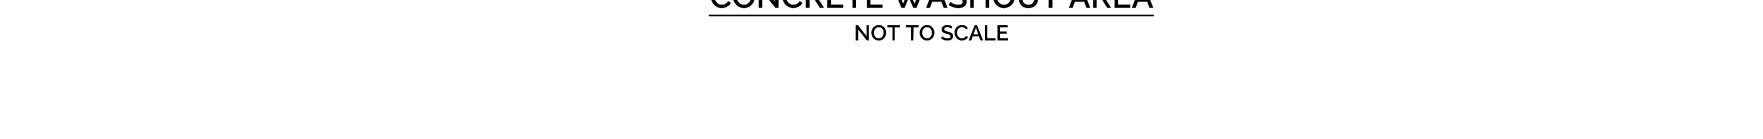

CONCRETE WASHOUT AREA NOT TO SCALE

Stamp table with columns for Stamp, SHM, and DATE.

SOIL EROSION & SEDIMENT CONTROL NARRATIVE AND DETAILS VESSEL MULTI-FAMILY HOUSING

Project and drawing information table including Project No. 2022-0013, Scale Not to Scale, Drawing SEN-1, and Sheet Number 8 of 13.


STAMP

NO.	REVISIONS PER REVIEW COMMENTS & IWA COMMENTS	DATE	APPR.
3	REVISIONS PER ENGINEERING REVIEW COMMENTS & IWA COMMENTS	3/30/2023	SHM
2	REVISIONS PER ENGINEERING REVIEW COMMENTS & IWA COMMENTS	3/17/2023	SHM
1	REVISIONS PER REVIEW COMMENTS	2/24/2023	SHM
	DESCRIPTION OF REVISION		

SITE DETAILS


VESEL MULTI-FAMILY HOUSING
PROPERTY ADDRESS
446 HOPMEADOW STREET, SIMSBURY, CT 06089
PREPARED FOR
VESEL RE HOLDINGS, LLC
46 WEST 55TH STREET, NEW YORK, NY 10019

PROJECT NO.	SCALE
2022-0013	NOT TO SCALE
DRAWN BY:	DATE
SHM	12/16/2022
CHECKED BY:	DATE
SHM	12/16/2022
DRAWING	
DT-1	
SHEET NUMBER: 9	OF 13

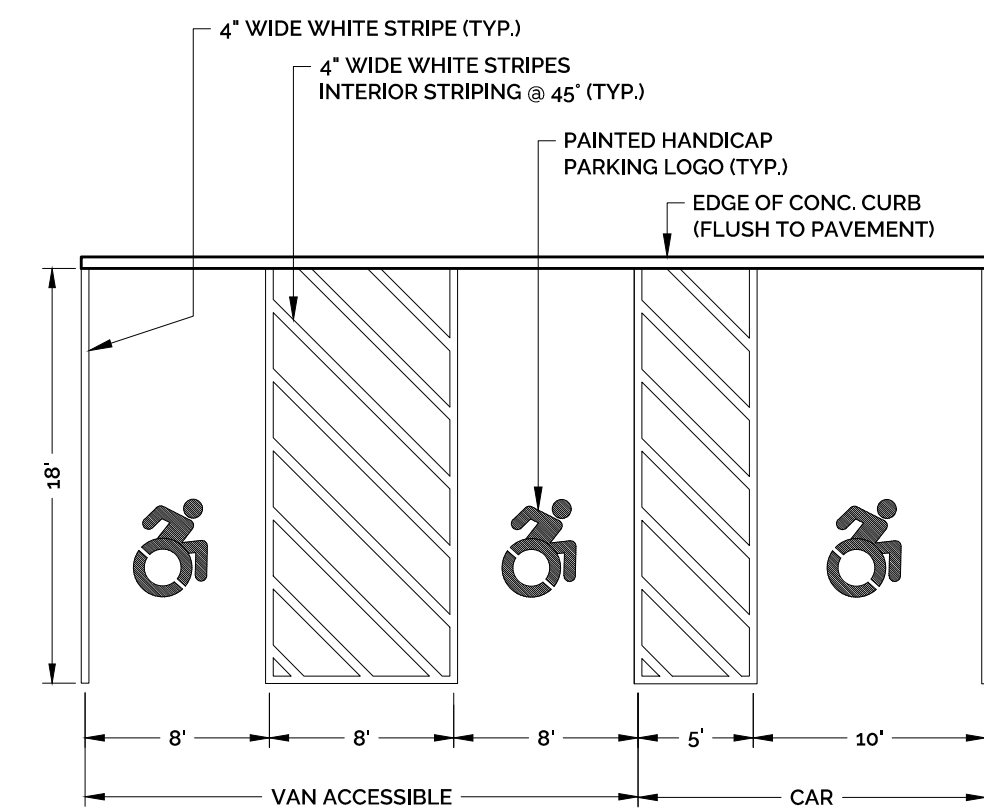


- NOTES:**
- PER SECTION 502.4.1 IN THE AMENDMENTS TO ICC A117.1-2009 NOTED IN THE 2018 CONNECTICUT STATE BUILDING CODE. ACCESS AISLES (CROSS HATCH) SHALL ADJOIN AN ACCESSIBLE ROUTE. TWO PARKING SPACES SHALL BE PERMITTED TO SHARE A COMMON ACCESS AISLE. IF A CAR AND A VAN SPACE SHARE A COMMON ACCESS AISLE, THAT AISLE SHALL BE 96 INCHES MINIMUM IN WIDTH. ACCESS AISLES SHALL NOT OVERLAY WITH THE VEHICULAR WAY. PARKING SPACES MAY HAVE ACCESS AISLES PLACED ON EITHER SIDE OF THE CAR OR VAN PARKING SPACE. VAN PARKING SPACES THAT ARE ANGLED SHALL HAVE ACCESS AISLES LOCATED ON THE PASSENGER SIDE OF THE PARKING SPACE.
 - PER SECTION 502.6 IN THE AMENDMENTS TO ICC A117.1-2009 NOTED IN THE 2018 CONNECTICUT STATE BUILDING CODE, AND IN ACCORDANCE WITH SECTION 1106.5 AND 1106.5.1.1 OF THE 2015 INTERNATIONAL BUILDING CODE, THE MINIMUM VERTICAL CLEARANCE FOR AN ACCESSIBLE SPACE WITHIN A PARKING GARAGE SHALL BE 8 FEET 2 INCHES.

ACCESSIBLE PARKING SPACE DETAIL
NOT TO SCALE

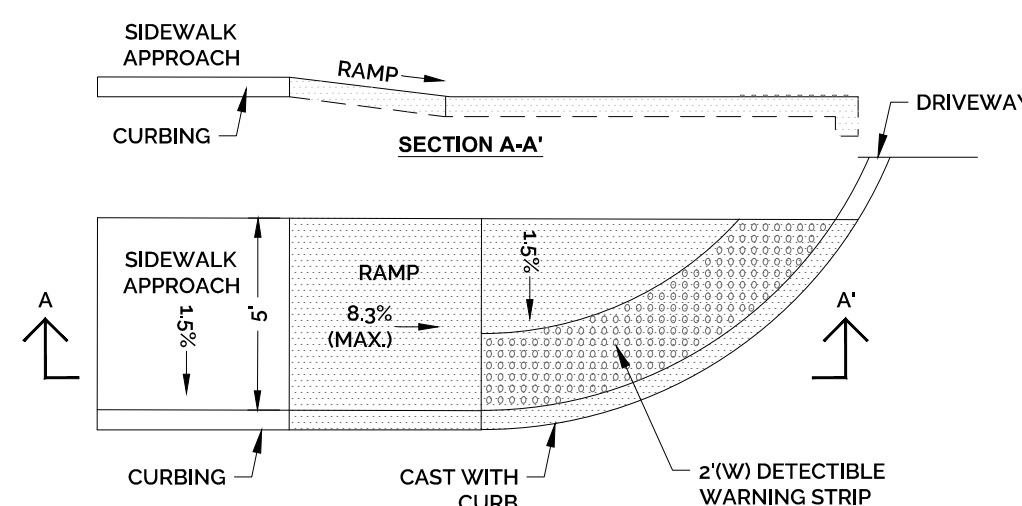


NOTE: SEE PLAN FOR SIZE AND LOCATION OF SIDEWALK
REFERENCE: STATE OF CONNECTICUT DEPARTMENT OF TRANSPORTATION
OFFICE OF ENGINEERING SIDEWALKS RAMP SHEET 2

DIAGONAL SIDEWALK RAMP (TYPE 4g)
NOT TO SCALE

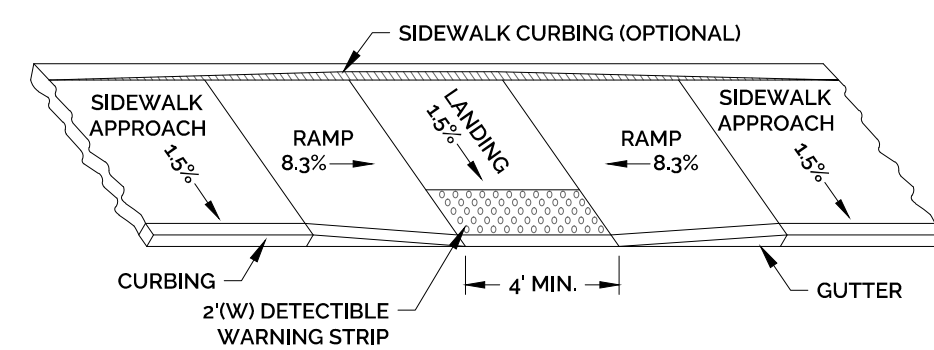


NOTE: SEE PLAN FOR SIZE AND LOCATION OF SIDEWALK
REFERENCE: STATE OF CONNECTICUT DEPARTMENT OF TRANSPORTATION
OFFICE OF ENGINEERING SIDEWALKS RAMP SHEET 1

PARALLEL SIDEWALK RAMP (TYPE 1)
NOT TO SCALE


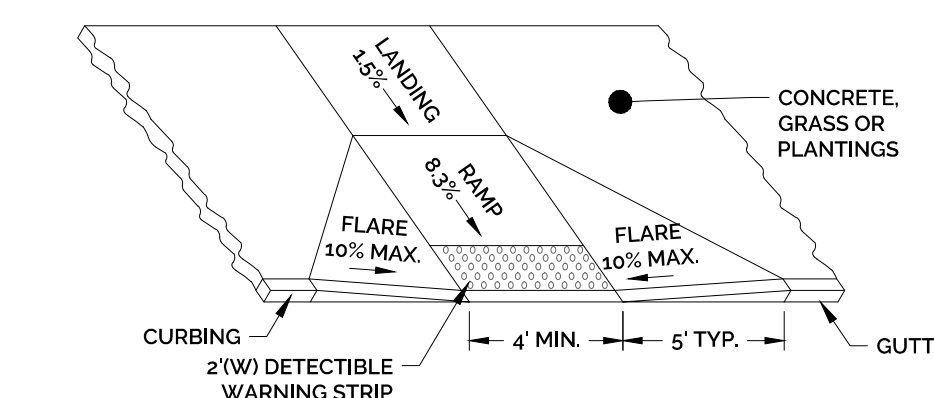


NOTE: SEE PLAN FOR SIZE AND LOCATION OF SIDEWALK
REFERENCE: STATE OF CONNECTICUT DEPARTMENT OF TRANSPORTATION
OFFICE OF ENGINEERING SIDEWALKS RAMP SHEET 1

PERPENDICULAR SIDEWALK RAMP (TYPE 6a)
NOT TO SCALE

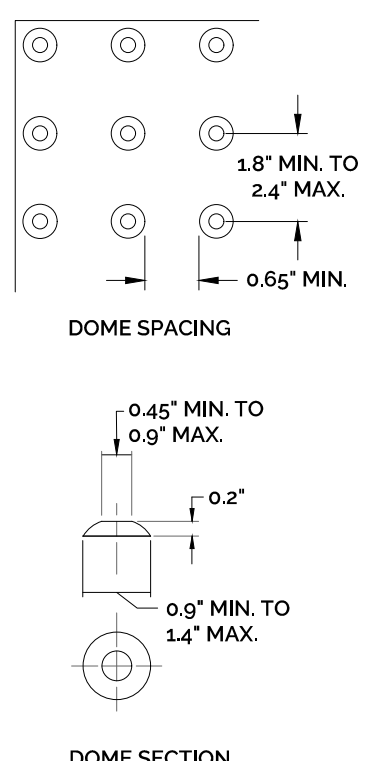


DETECTIBLE WARNING STRIP
NOT TO SCALE

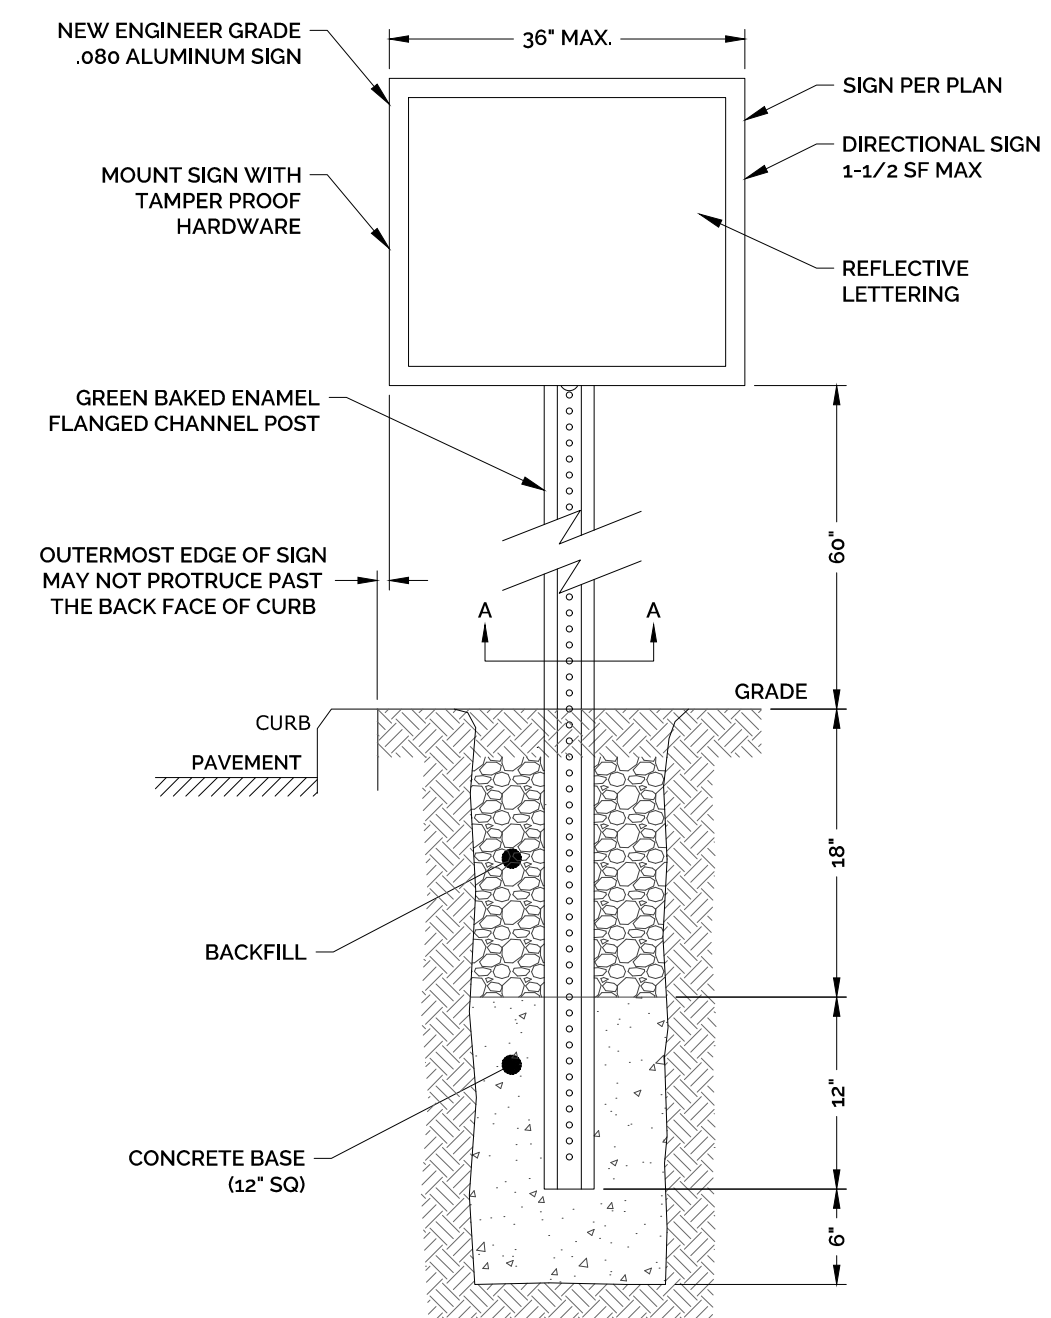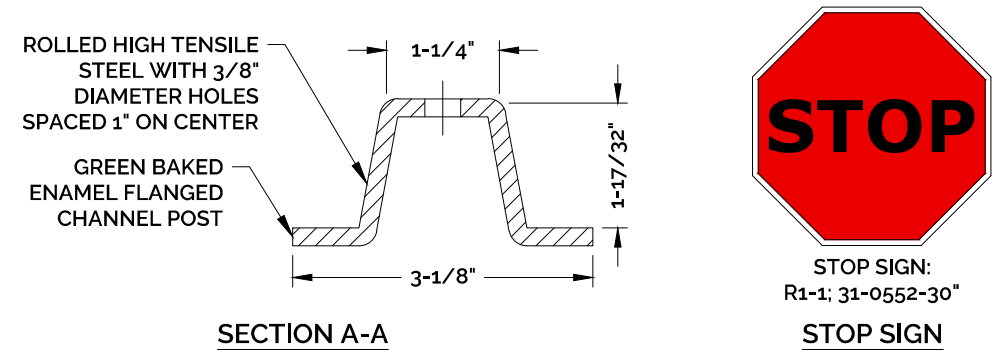


- NOTES:**
- SIGN MUST BE INSTALLED PERPENDICULAR TO TRAVEL LANE.
 - SIGNS INSTALLATIONS WITHIN THE STATE OF CONNECTICUT RIGHT OF WAY SHALL INCLUDE BREAKAWAY MOUNTING.
 - ALL SIGNS WITHIN THE CITY R.O.W. ARE TO BE HIGH INTENSITY PRISMATIC. INSTALLED WITH BREAKAWAY POSTS AND IN ACCORDANCE WITH THE M.U.T.C.D.
 - SIGN MATERIALS SHALL BE IN ACCORDANCE WITH SECTION M18 OF THE CONDOT STANDARD SPECIFICATIONS FOR ROADWAY, BRIDGES AND INCIDENTAL CONSTRUCTION.


TRAFFIC SIGN
NOT TO SCALE

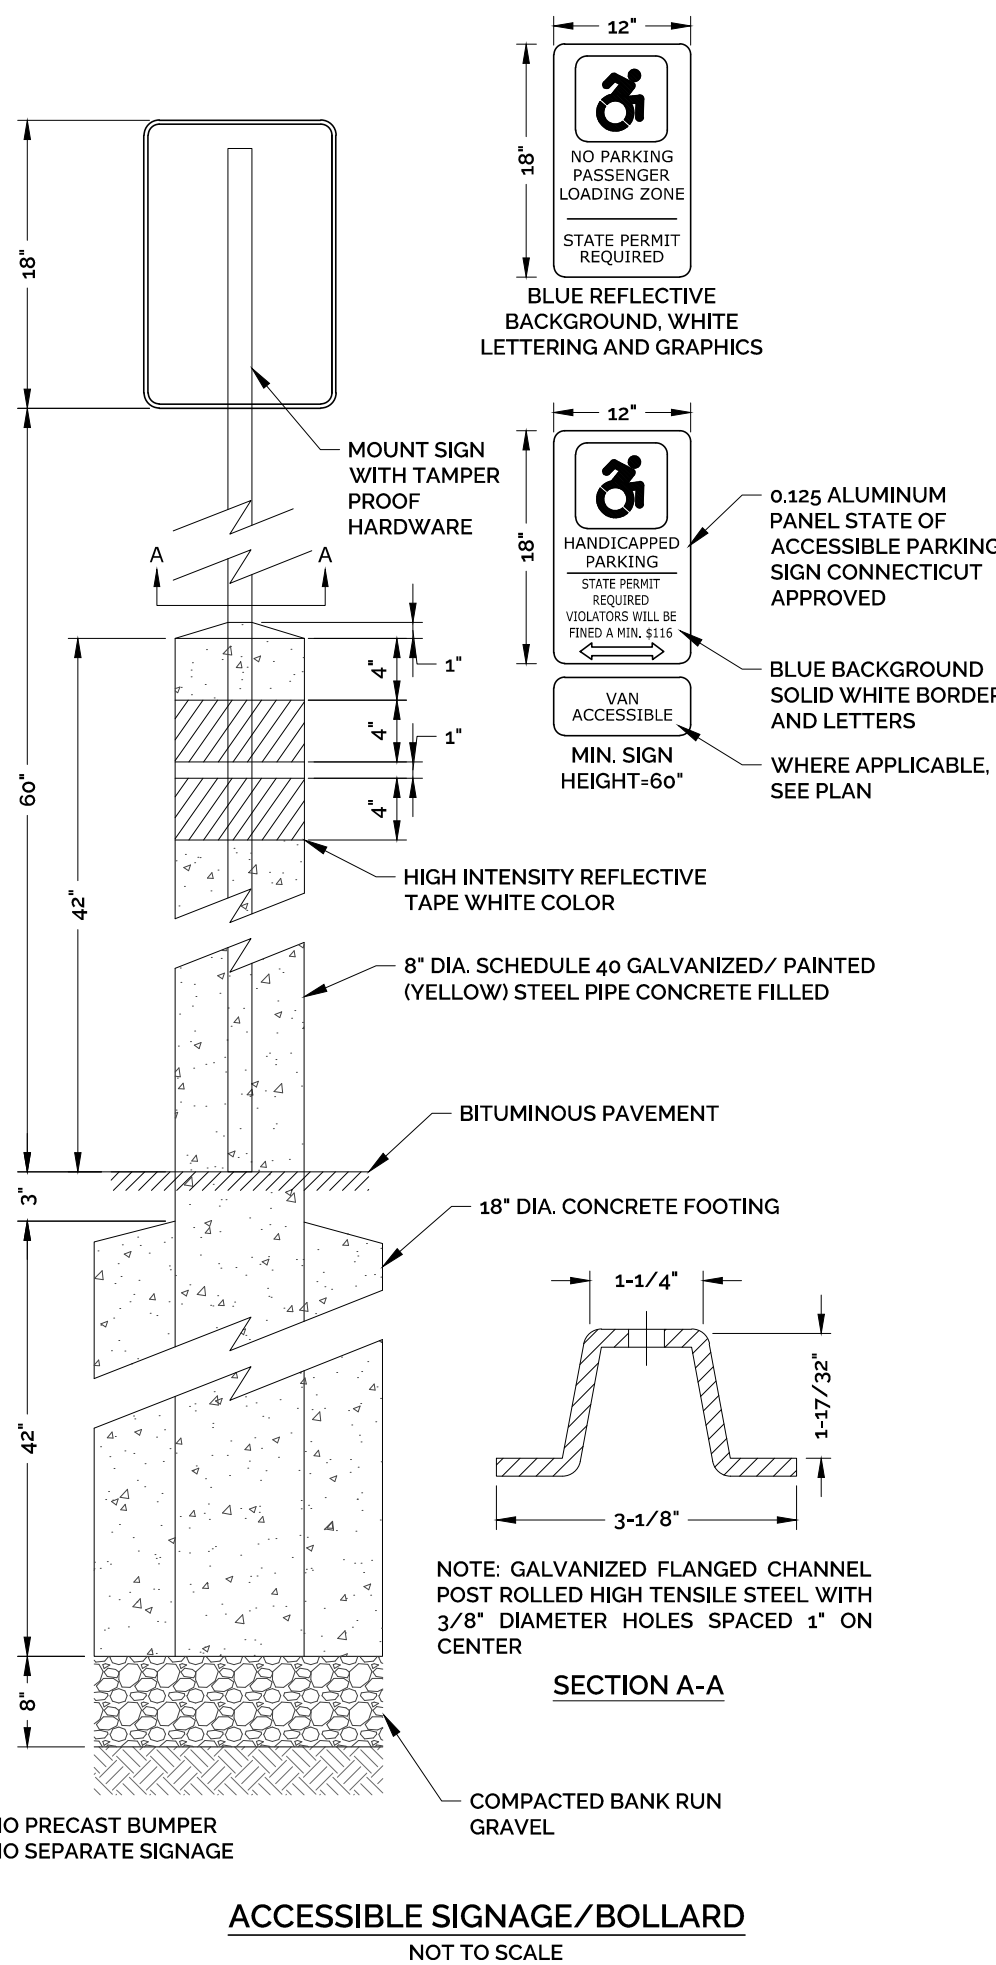

ACCESSIBLE SIGNAGE/BOLLARD
NOT TO SCALE

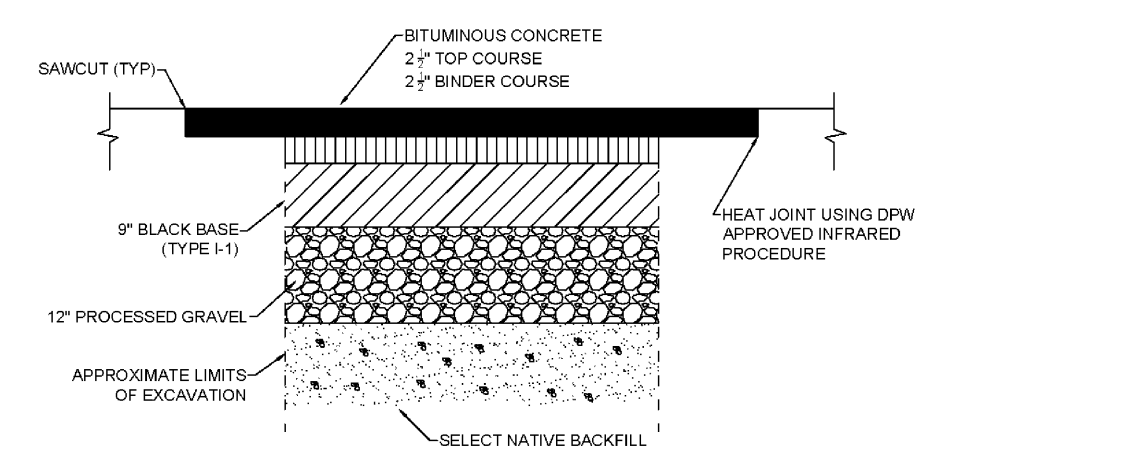


PERMANENT TRENCH REPAIR (STATE ROADS)
TOWN OF SIMSBURY DETAIL - PERMANENT TRENCH REPAIR
NOT TO SCALE

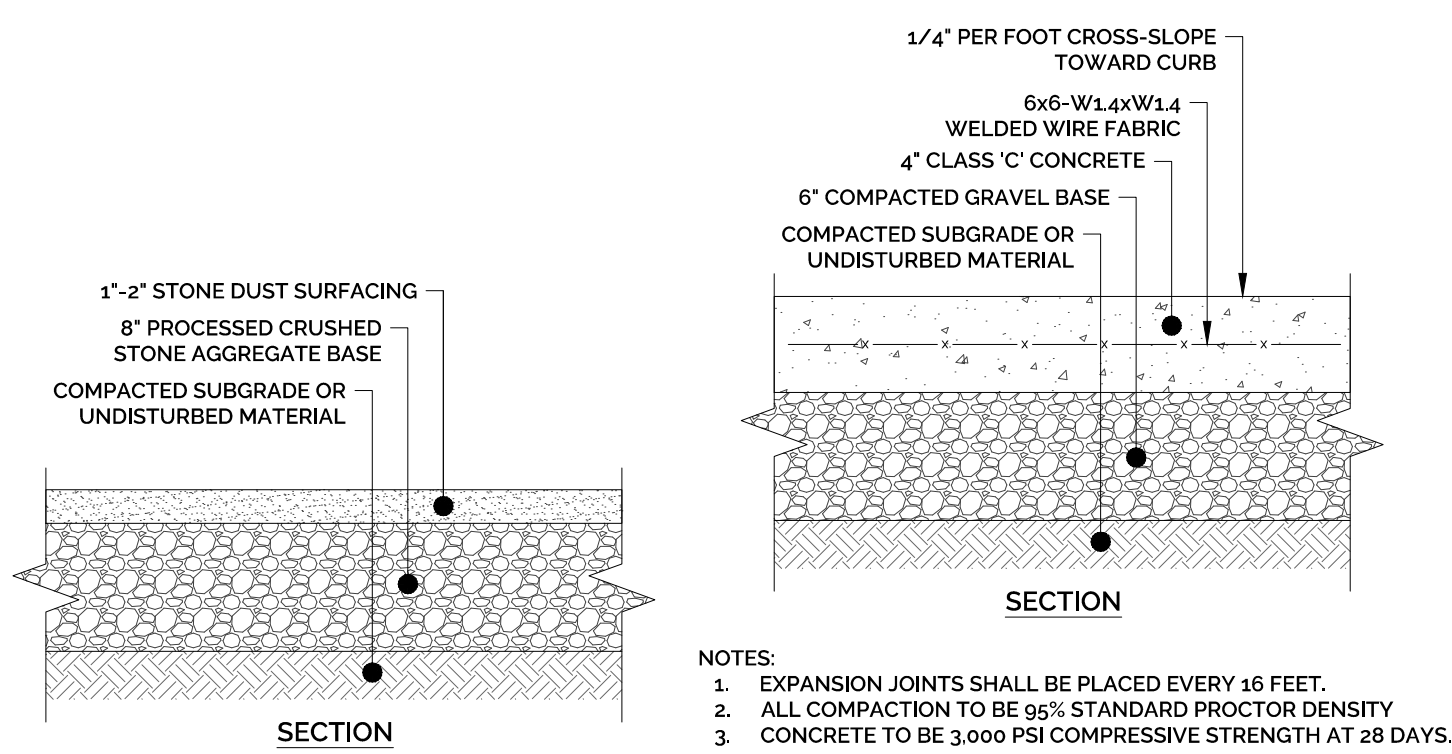


STONE DUST WALK
NOT TO SCALE


CONCRETE SIDEWALK
NOT TO SCALE

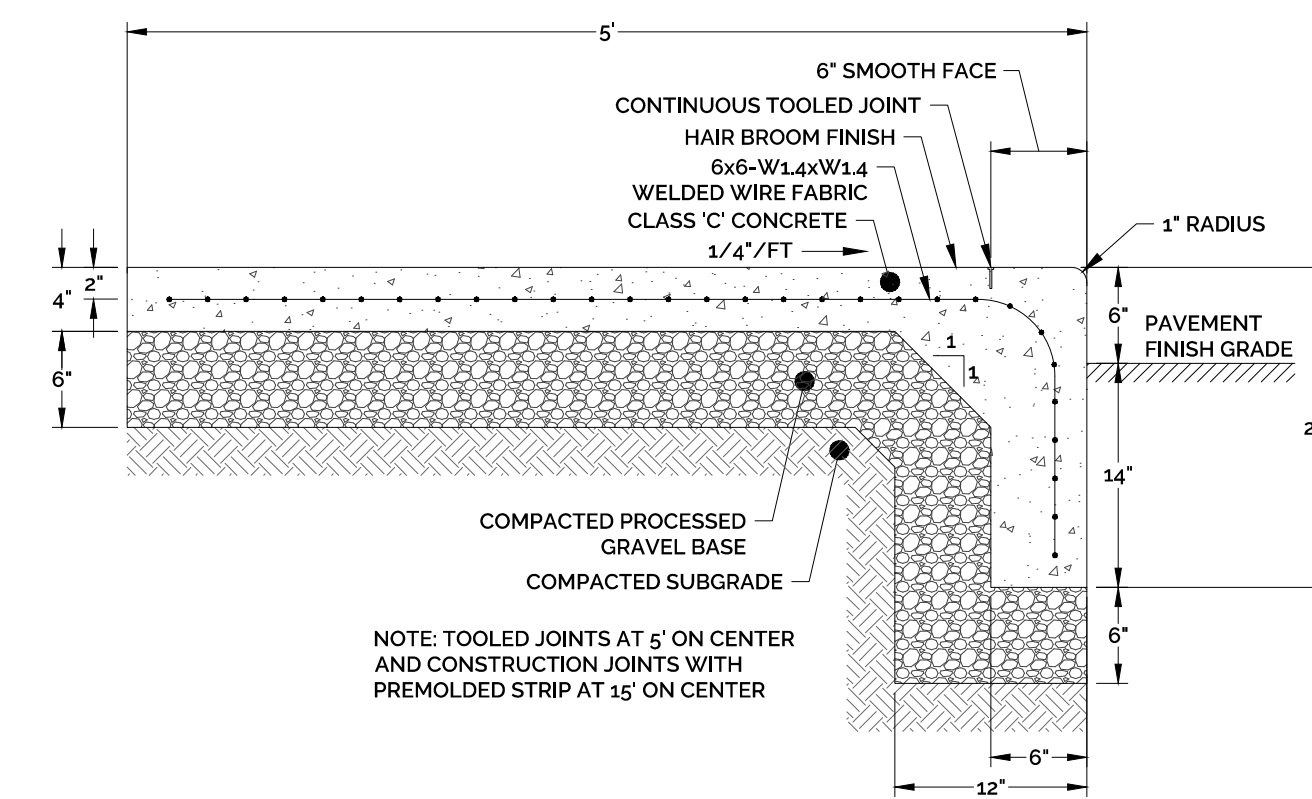


CONCRETE SIDEWALK WITH MONOLITHIC CURB
NOT TO SCALE

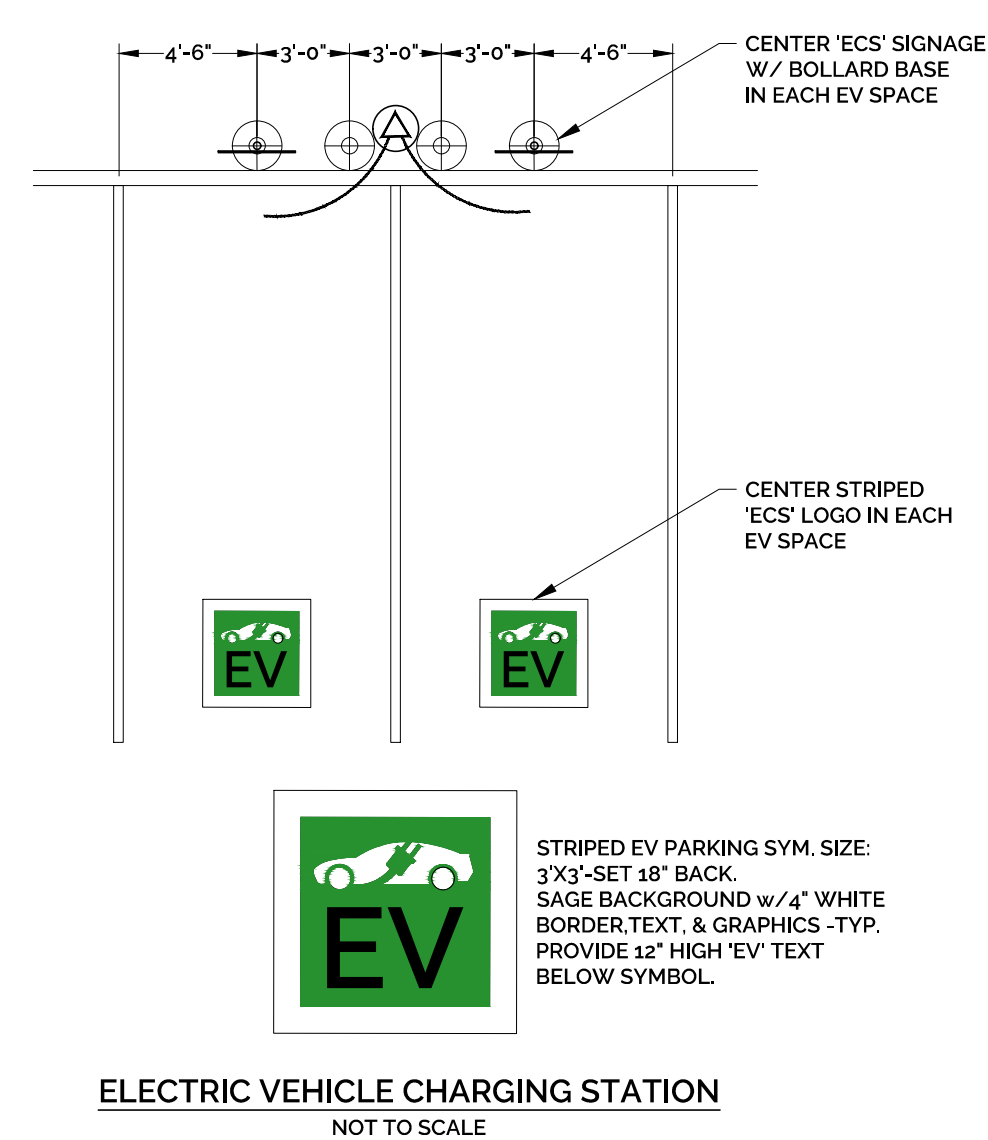

ELECTRIC VEHICLE CHARGING STATION
NOT TO SCALE

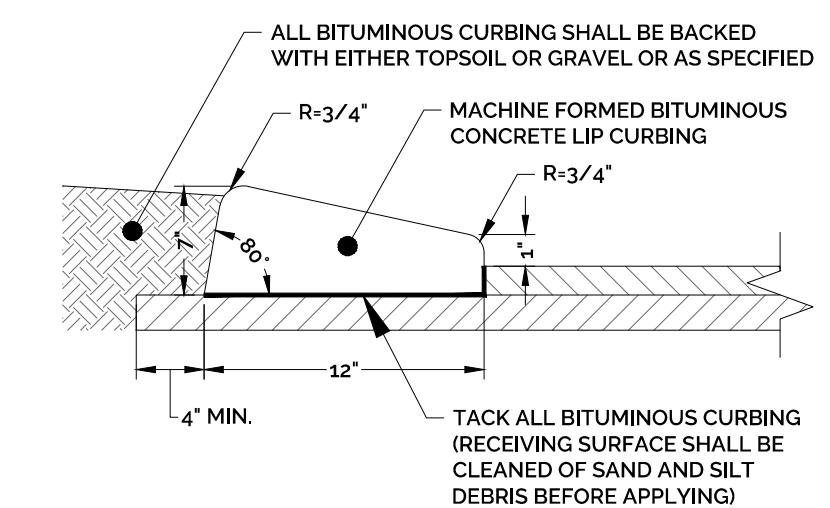


BITUMINOUS CONCRETE 'CAPE COD' STYLE MOUNTABLE CURB DETAIL
NOT TO SCALE

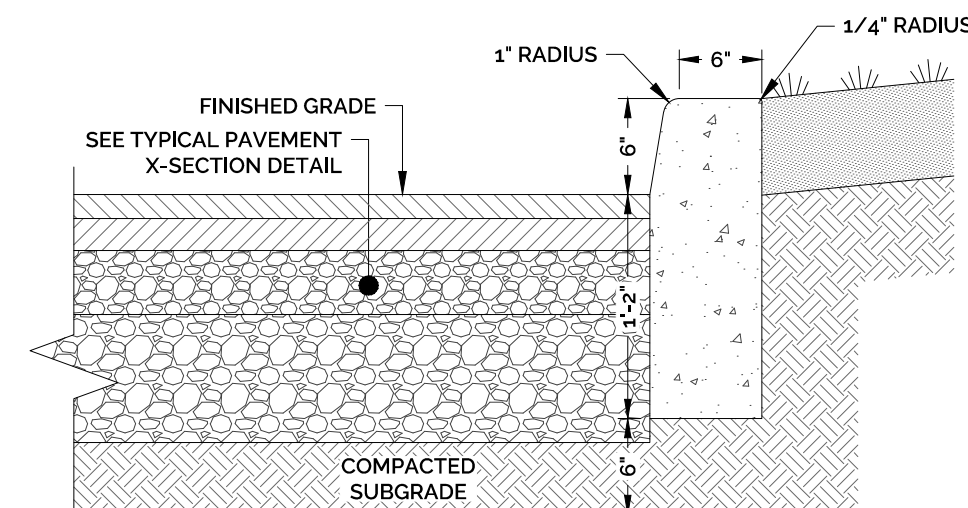


NOTE: CURB SHALL BE PRECAST OR CAST IN PLACE

CONCRETE CURB
NOT TO SCALE

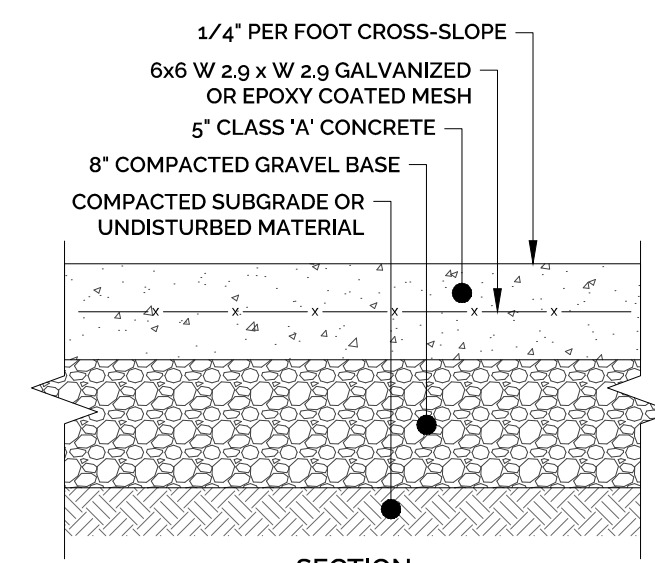


- NOTES:**
- ALL COMPACTION TO BE 95% STANDARD PROCTOR DENSITY.
 - CONCRETE TO BE 3,500 PSI COMPRESSIVE STRENGTH AT 28 DAYS.
 - SEE PLAN FOR LOCATION AND SIZE OF PAD.

CONCRETE DUMPSTER PAD
NOT TO SCALE

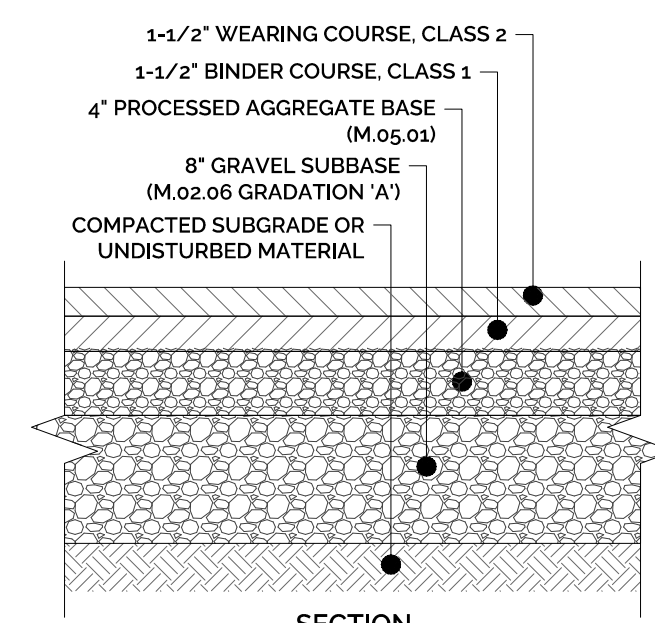

BITUMINOUS CONCRETE PAVING
NOT TO SCALE

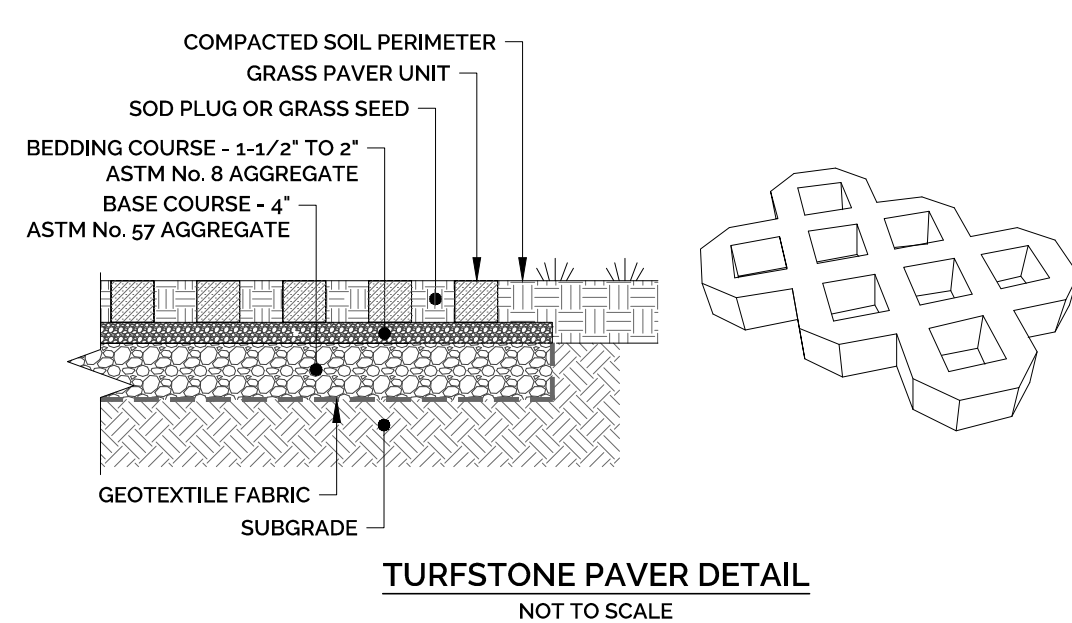

TURFSTONE PAVER DETAIL
NOT TO SCALE

2: SIMSBURY ENGINEERING ASSOCIATES PROJECTS 1522-0322-0013 - VESSEL - 446 HOPMEADOW ST. SIMSBURY, CT 06089 - SITE DETAILS 01 - SHEET 37 OF 1323 11:25 AM PROJECT 3/31/2023 13:48

STAMP

REV	DATE	DESCRIPTION OF REVISION	APPR.
1	2/24/2023	REVISIONS PER ENGINEERING REVIEW COMMENTS	SHM
2	3/17/2023	REVISIONS PER ENGINEERING REVIEW COMMENTS & IWA COMMENTS	SHM
3	3/20/2023	REVISIONS PER ENGINEERING REVIEW COMMENTS & IWA COMMENTS	SHM


SITE AND DRAINAGE DETAILS
VESSEL MULTI-FAMILY HOUSING
PROPERTY ADDRESS
446 HOPMEADOW STREET, SIMSBURY, CT 06089
PREPARED FOR
VESSEL RE HOLDINGS, LLC
46 WEST 55TH STREET, NEW YORK, NY 10019

PROJECT NO.	SCALE
2022-0013	NOT TO SCALE


DRAWN BY:	DATE
SHM	12/16/2022

CHECKED BY:	DATE
SHM	12/16/2022


DRAWING
DT-2
SHEET NUMBER: 10 OF 13

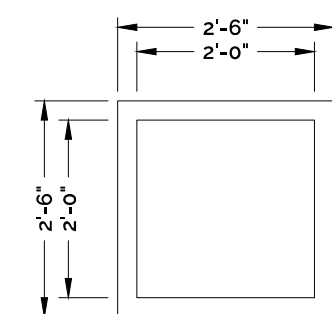

PLAN VIEW DETAIL

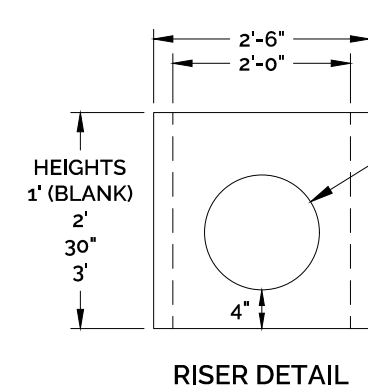


RISER DETAIL

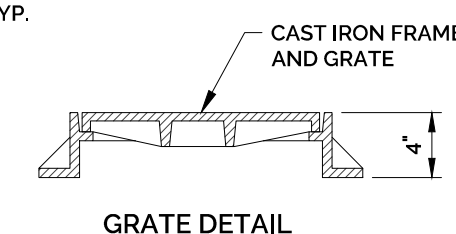

GRATE DETAIL


- NOTES:
1. REINFORCING STEEL WELDED WIRE FABRIC CONFORMS TO LATEST ASTM SPECIFICATION A185.
 2. REINFORCING STEEL DEFORMED BARS CONFORM TO LATEST ASTM SPECIFICATION A635.
 3. CONCRETE COMPRESSIVE STRENGTH - 4000 PSI AT 28 DAYS.
 4. METHOD OF MANUFACTURE: WET CAST.
 5. SECTION IS MONOLITHIC.
 6. DESIGN LOAD: AASHTO H-20

YARD DRAIN DETAIL
NOT TO SCALE

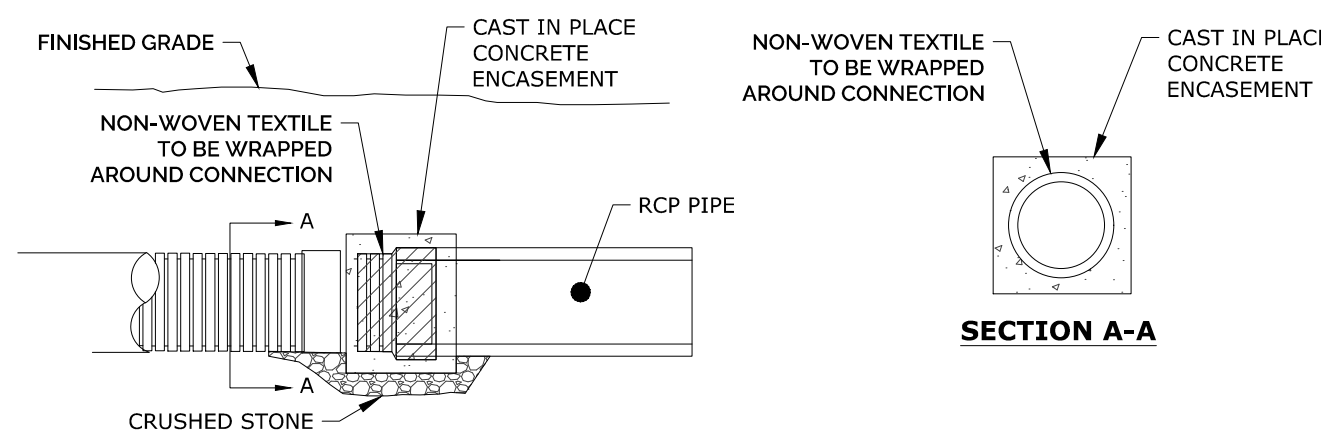


HDPE TO RCP CONNECTION
(GEOTEXTILE WRAP)
NOT TO SCALE

SECTION A-A

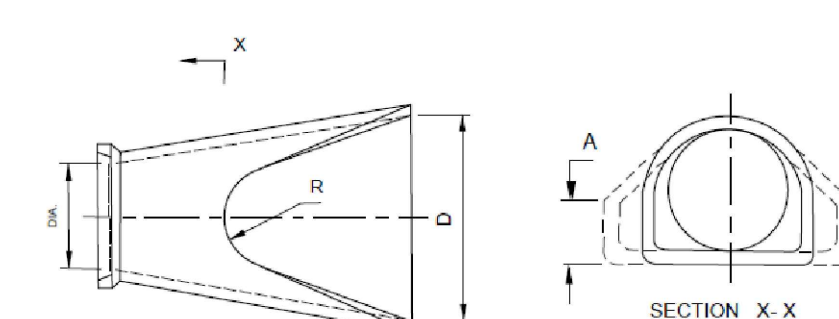


SECTION X-X

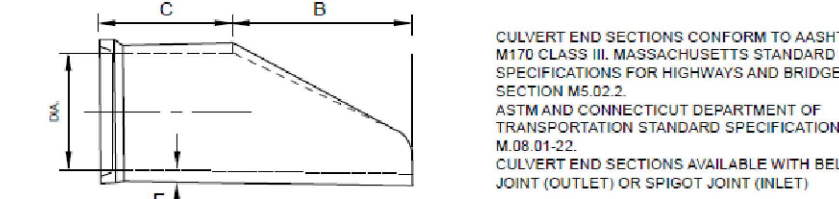

CULVERT END SECTIONS CONFORM TO AASHTO M118 CLASS II MANHOLES/TIE STANDARDS SPECIFICATIONS FOR HIGHWAYS AND BRIDGES SECTION 802.2.2. ASTM AND CONNECTICUT DEPARTMENT OF TRANSPORTATION STANDARDS SPECIFICATION M.38 01.23. CULVERT END SECTIONS AVAILABLE WITH BELL JOINT (OUTLET) OR SPIGOT JOINT (INLET).

INLET	A	B	C	D	E	F
12"	10"	12"	14"	16"	18"	20"
18"	16"	18"	20"	22"	24"	26"
24"	22"	24"	26"	28"	30"	32"
30"	28"	30"	32"	34"	36"	38"
36"	34"	36"	38"	40"	42"	44"
42"	40"	42"	44"	46"	48"	50"
48"	46"	48"	50"	52"	54"	56"
54"	52"	54"	56"	58"	60"	62"
60"	58"	60"	62"	64"	66"	68"


REINFORCED CONCRETE CULVERT ENDS
NOT TO SCALE

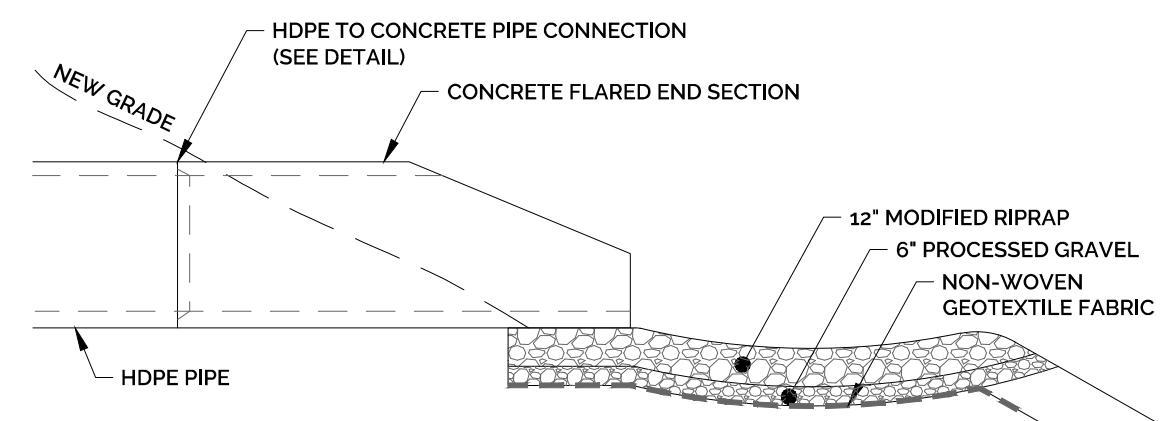


RIPRAP APRON DIMENSIONS			
OUTLET	W1	La	W2
1 (EW-1)	3	5	6
2 (FES-1)	3	5	5
3 (FES-2)	3	5	7

NOTE: IN ACCORDANCE WITH CT DOT DRAINAGE MANUAL SECTION 11.13 - OUTLET PROTECTION, ALL APRON STONE SHALL BE MODIFIED RIPRAP (DISCHARGE VELOCITY < 8 FT/S)


RIPRAP APRON
NOT TO SCALE

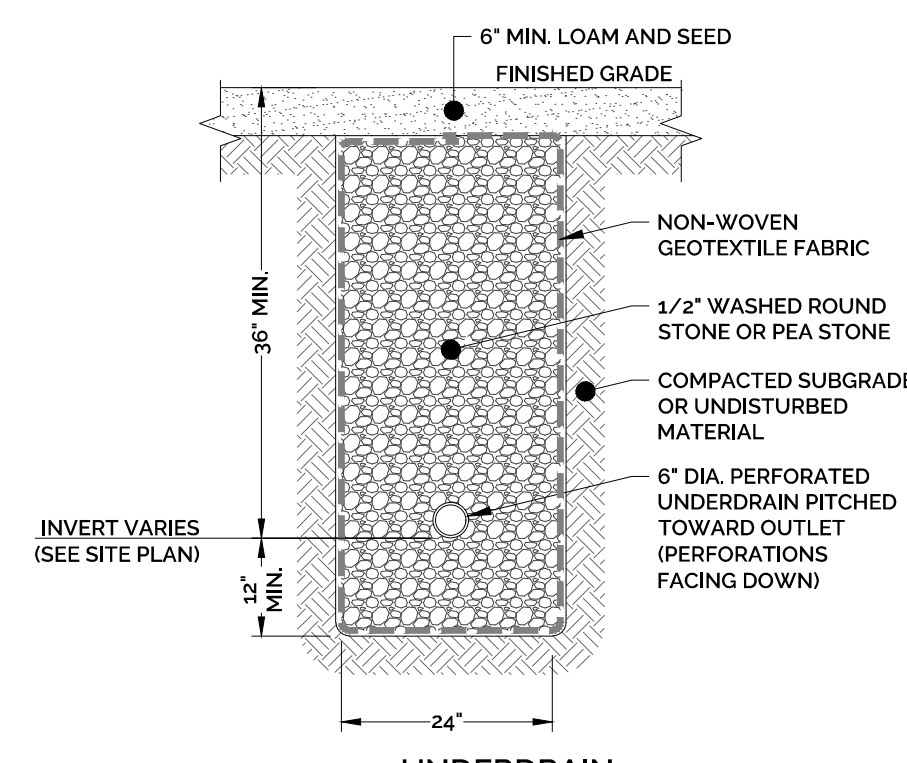


UNDERDRAIN
NOT TO SCALE

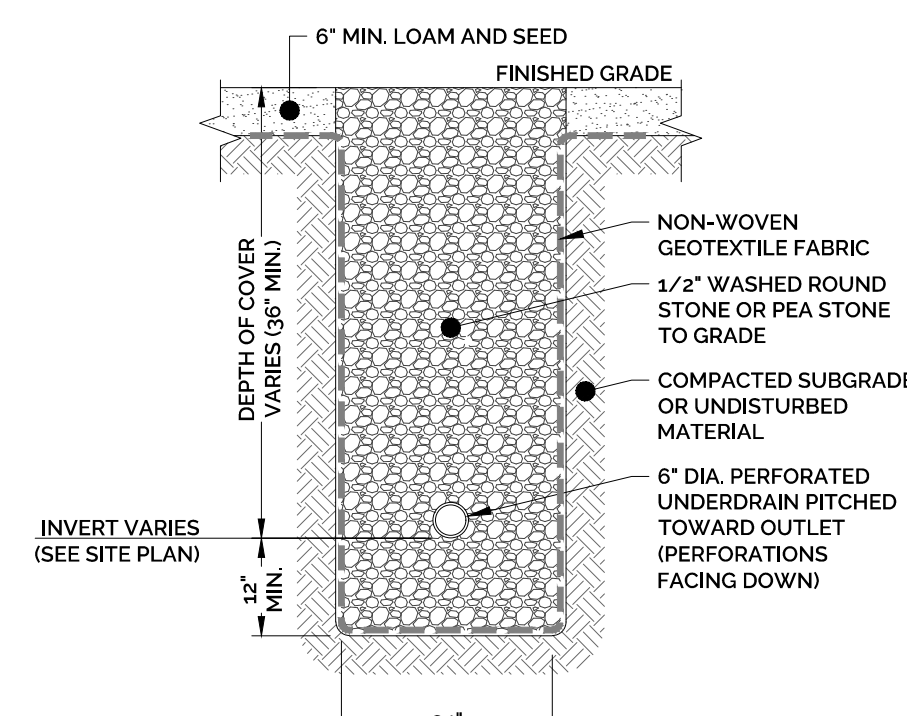

CURTAIN DRAIN
NOT TO SCALE

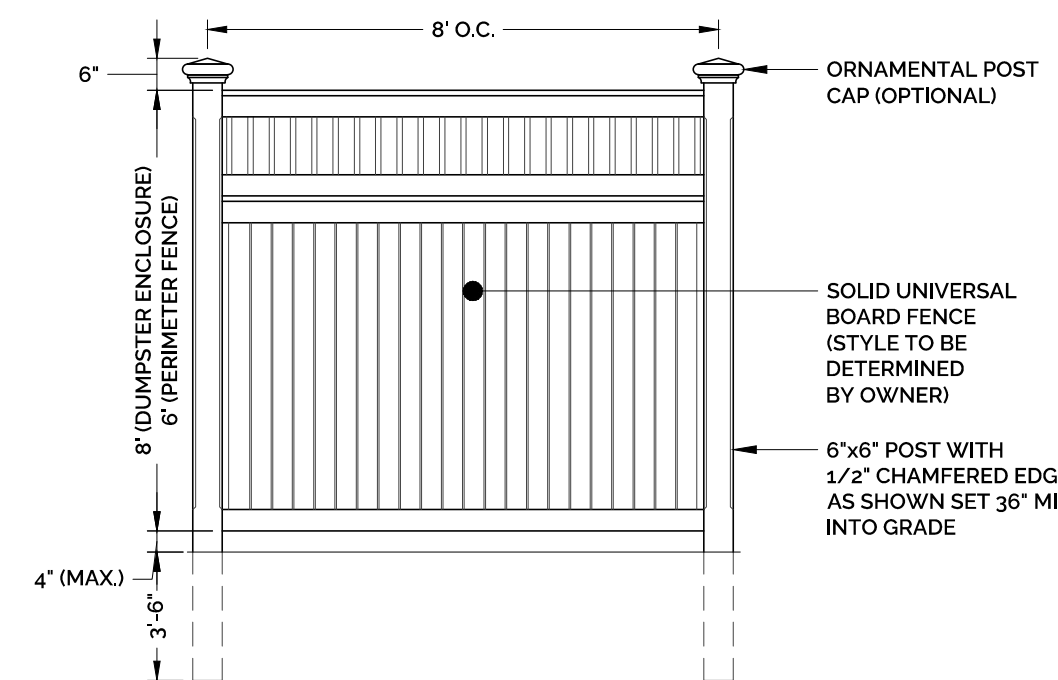


DUMPSTER ENCLOSURE/FENCE ELEVATION
NOT TO SCALE

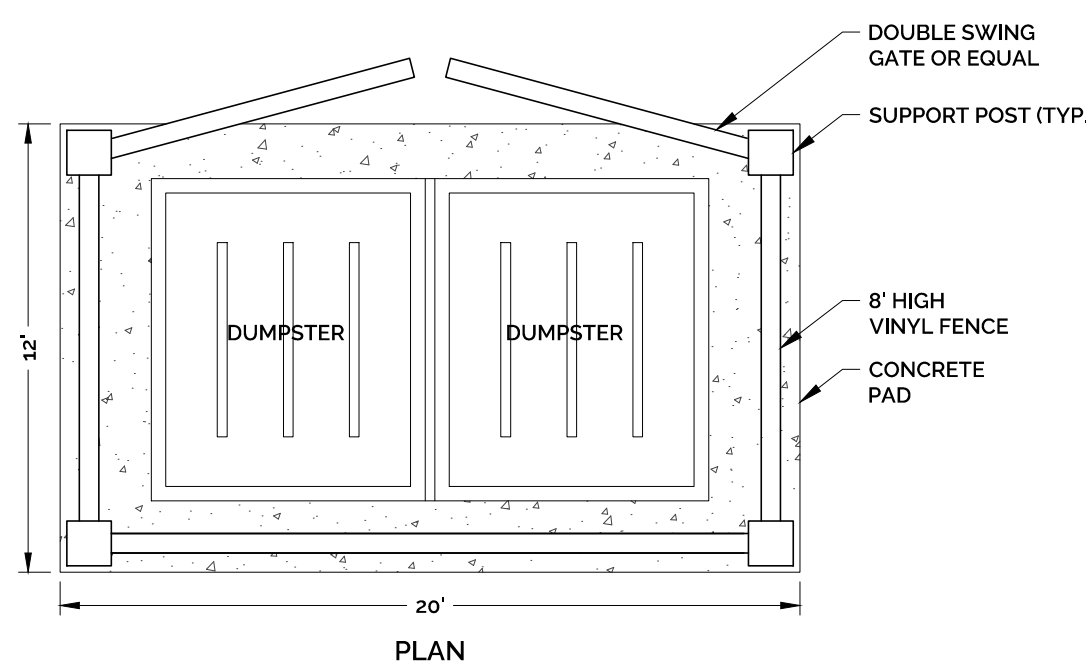


DUMPSTER ENCLOSURE DETAIL
NOT TO SCALE

- NOTES:
1. MATERIAL AND COLOR FOR DOUBLE SWING GATES SHALL MATCH FENCING AS SELECTED BY ARCHITECT.
 2. ALL DIMENSIONS ARE APPROXIMATE AND ARE INTENDED TO ACCOMMODATE THE PROPOSED DUMPSTER(S).
 3. ENCLOSURE STYLE AND COLOR TO BE DETERMINED BY OWNER.

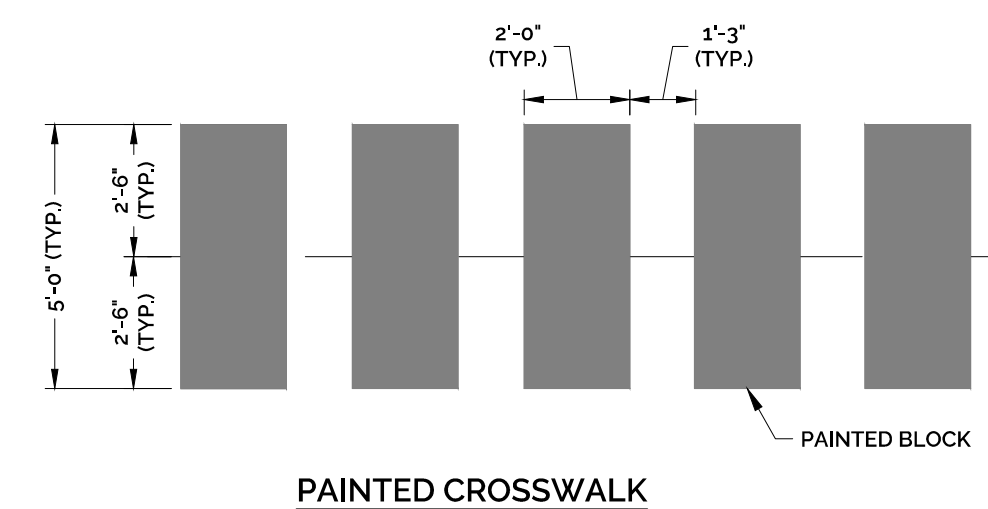


PAINTED CROSSWALK
NOT TO SCALE

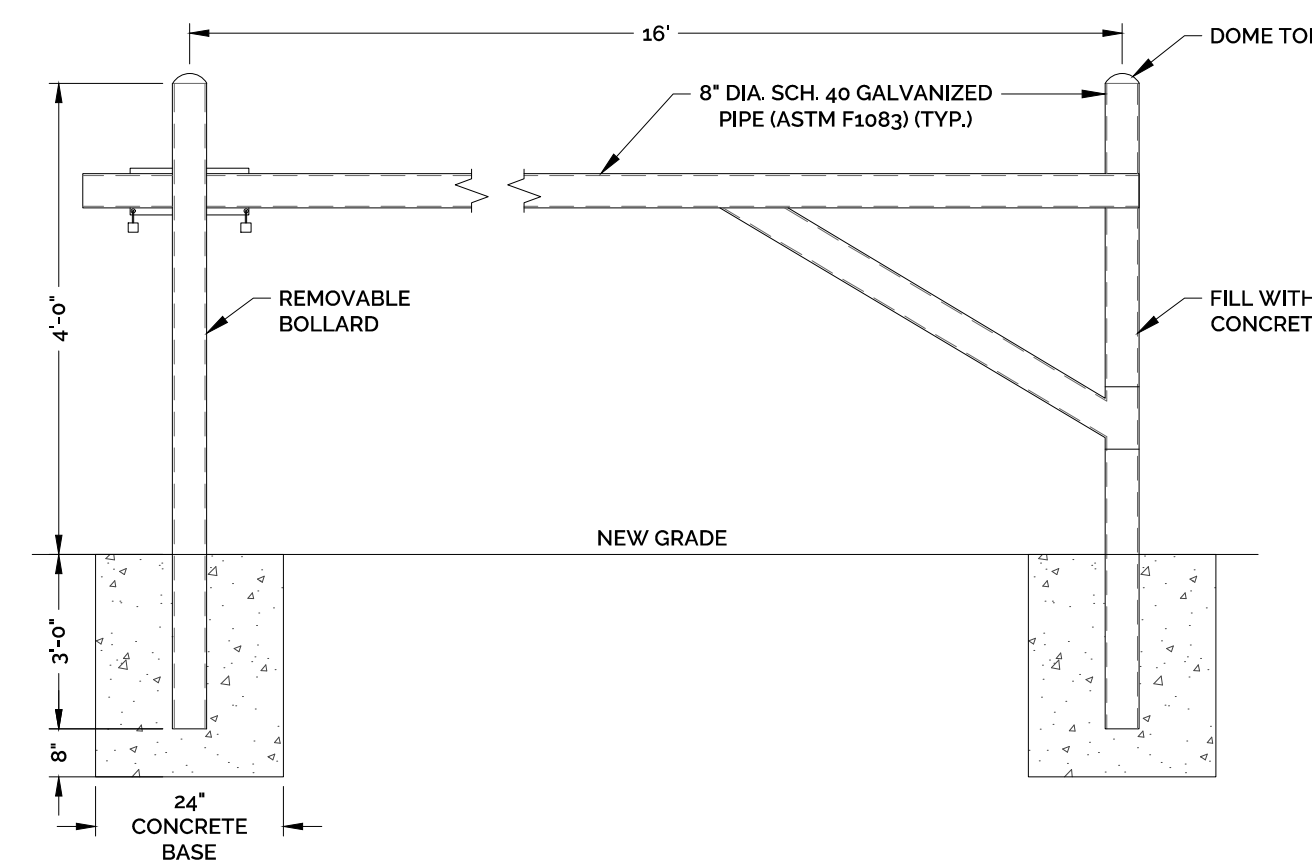


METAL BARWAY GATE DETAIL
NOT TO SCALE

- NOTES:
1. CONTRACTOR TO VERIFY THE GATE OPENING DIMENSIONS PRIOR TO BEGINNING CONSTRUCTION.
 2. INSTALL GATES PER MANUFACTURERS SPECIFICATIONS.

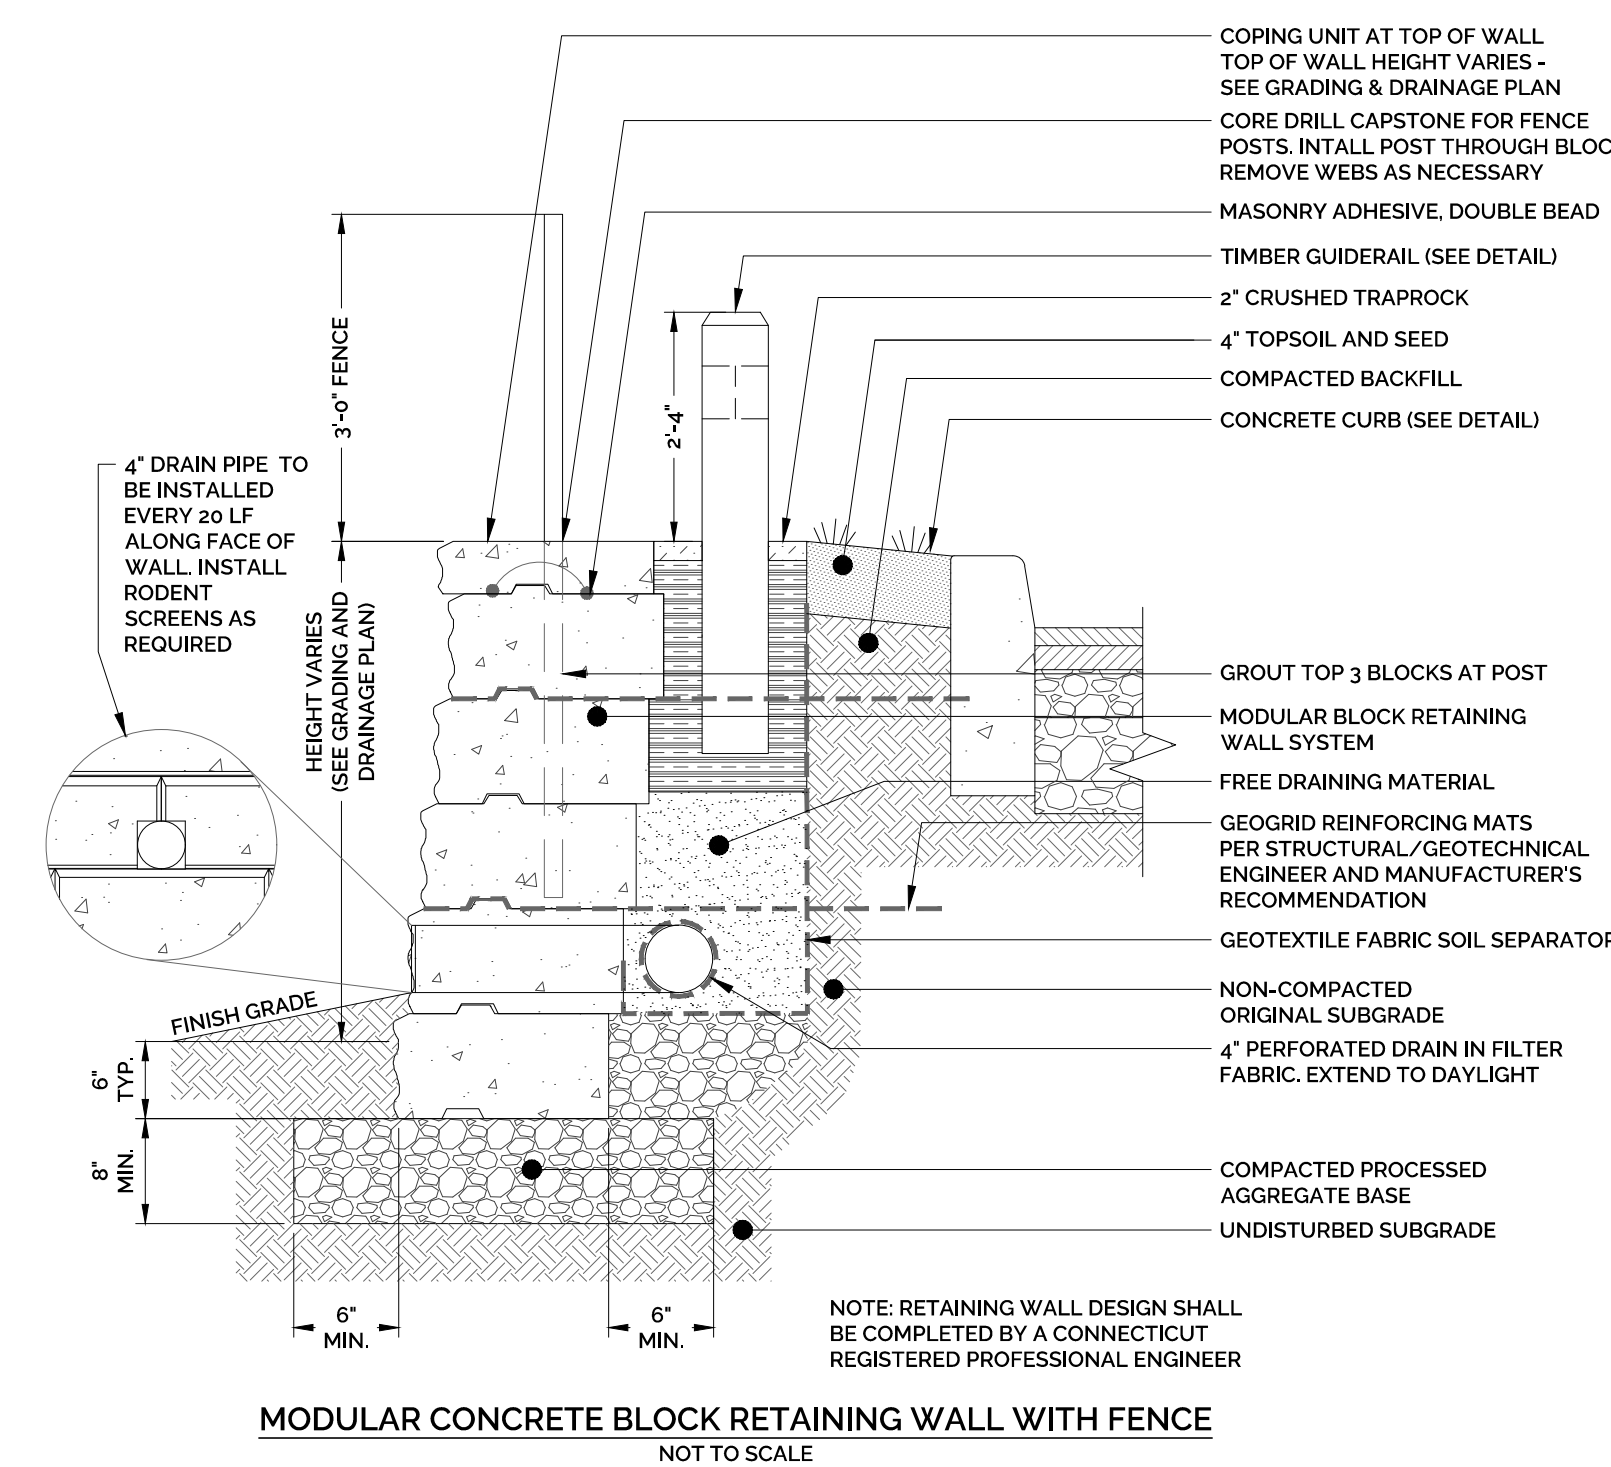


MODULAR CONCRETE BLOCK RETAINING WALL WITH FENCE
NOT TO SCALE


- NOTES:
1. ANY FIELD CUTTING, DRILLING, OR MACHINING OF POST AND RAILS SHALL BE TREATED WITH 2 BRUSH COATS OF COPPER NAPHTHENATE.
 2. RAILS AND POST SHALL BE SOUTHERN YELLOW PINE, GRADE NO. 2 DENSE TREATED WITH C.C.A. (AWPA STANDARD P5) WITH A MINIMUM RETENTION OF 0.6 POUNDS PER CUBIC FEET (P.C.F.) TIMBER SHALL BE KILN DRIED AFTER TREATMENT (KDAT) TO < 19% M.C.
 3. BACKFILL IN ALL CASES SHALL BE MADE WITH MATERIAL CAPABLE OF BEING COMPACTED.
 4. ALL POSTS SHALL BE ERRECTED TO THE LINES AND GRADES INDICATED IN THE DRAWINGS THE TOP INSIDE EDGES OF ALL POSTS SHALL BE WITHIN 1/4 INCH OF THEIR CORRECT POSITION.
 5. ALL SURFACES WHERE THE PRESERVATIVE ENVELOPE IS INTERRUPTED SHALL RECEIVE TWO BRUSH COATS OF COPPER NAPHTHENATE.
 6. CRUSHED TRAPROCK SHALL BE PLACED ALONG THE ENTIRE LENGTH OF THE FENCE.

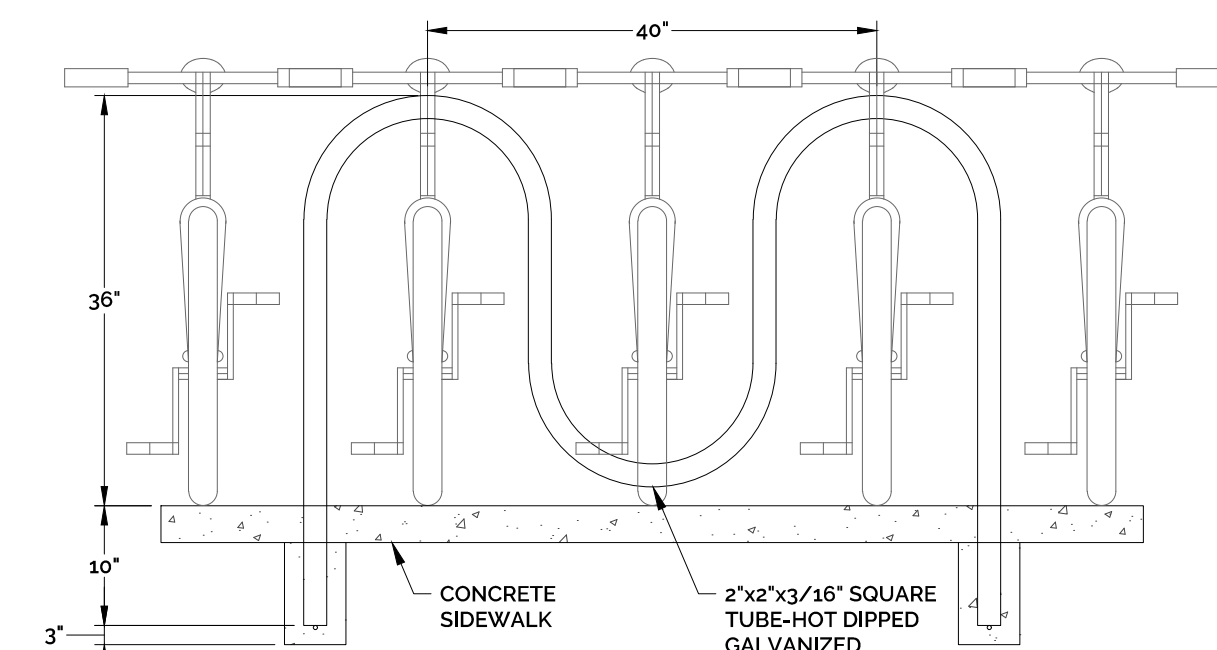


BIKE RACK DETAIL
NOT TO SCALE

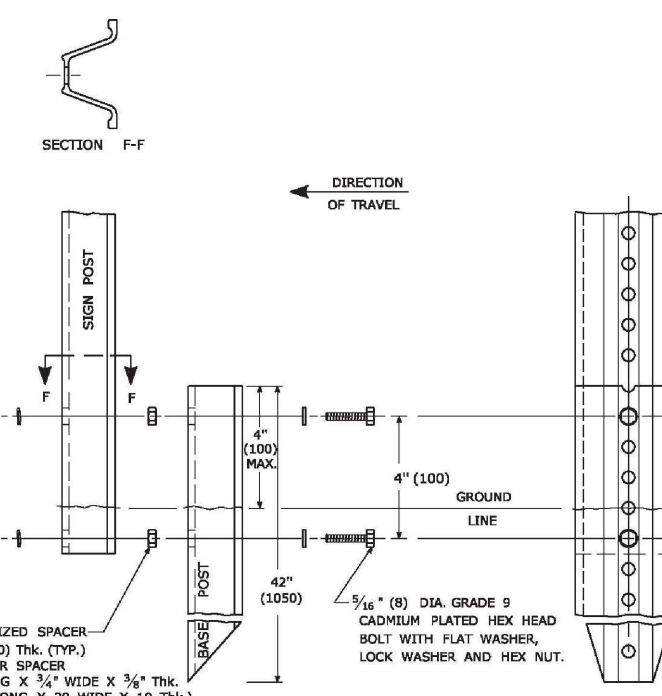

BREAKAWAY TYPE II INSTALLATION
NOT TO SCALE

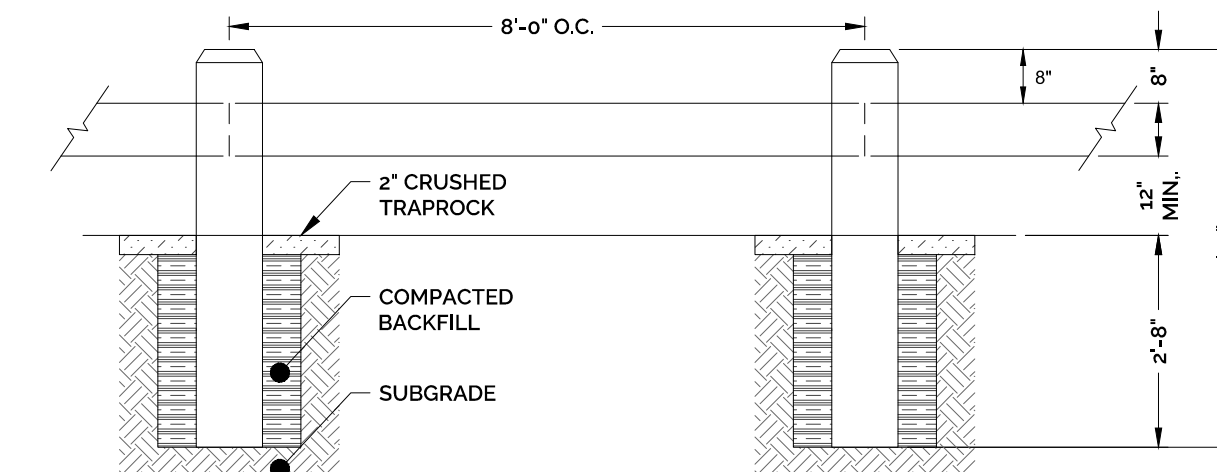

SECTION OF TIMBER RAIL

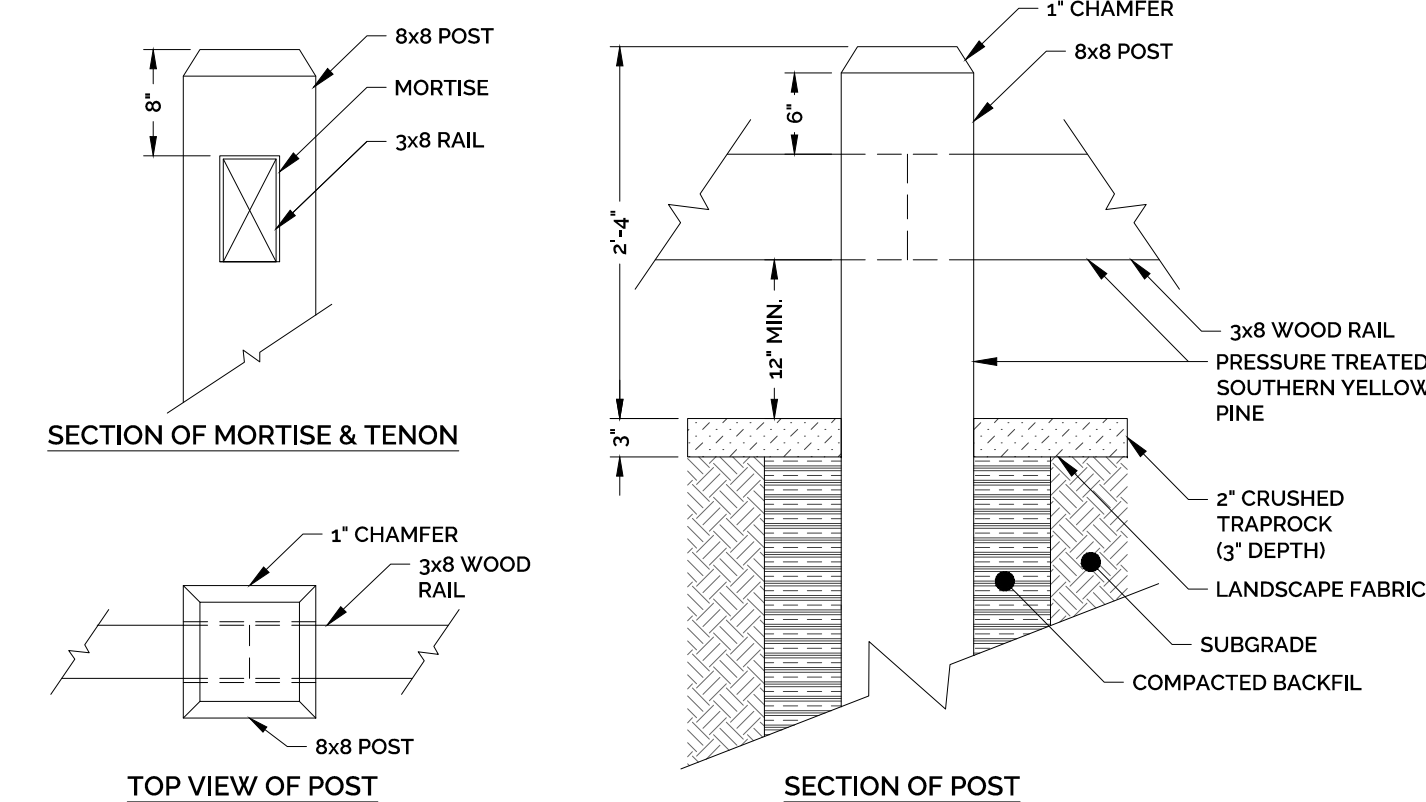

SECTION OF MORTISE & TENON

TOP VIEW OF POST


SECTION OF POST

- NOTES:
1. ANY FIELD CUTTING, DRILLING, OR MACHINING OF POST AND RAILS SHALL BE TREATED WITH 2 BRUSH COATS OF COPPER NAPHTHENATE.
 2. RAILS AND POST SHALL BE SOUTHERN YELLOW PINE, GRADE NO. 2 DENSE TREATED WITH C.C.A. (AWPA STANDARD P5) WITH A MINIMUM RETENTION OF 0.6 POUNDS PER CUBIC FEET (P.C.F.) TIMBER SHALL BE KILN DRIED AFTER TREATMENT (KDAT) TO < 19% M.C.
 3. BACKFILL IN ALL CASES SHALL BE MADE WITH MATERIAL CAPABLE OF BEING COMPACTED.
 4. ALL POSTS SHALL BE ERRECTED TO THE LINES AND GRADES INDICATED IN THE DRAWINGS THE TOP INSIDE EDGES OF ALL POSTS SHALL BE WITHIN 1/4 INCH OF THEIR CORRECT POSITION.
 5. ALL SURFACES WHERE THE PRESERVATIVE ENVELOPE IS INTERRUPTED SHALL RECEIVE TWO BRUSH COATS OF COPPER NAPHTHENATE.
 6. CRUSHED TRAPROCK SHALL BE PLACED ALONG THE ENTIRE LENGTH OF THE FENCE.

TIMBER POST AND RAIL
NOT TO SCALE



STAMP

REV	DATE	DESCRIPTION OF REVISION	APPR.
3	3/20/2023	REVISIONS PER ENGINEERING REVIEW COMMENTS & IWA COMMENTS	SHM
2	3/17/2023	REVISIONS PER ENGINEERING REVIEW COMMENTS & IWA COMMENTS	SHM
1	2/24/2023	REVISIONS PER REVIEW COMMENTS	SHM

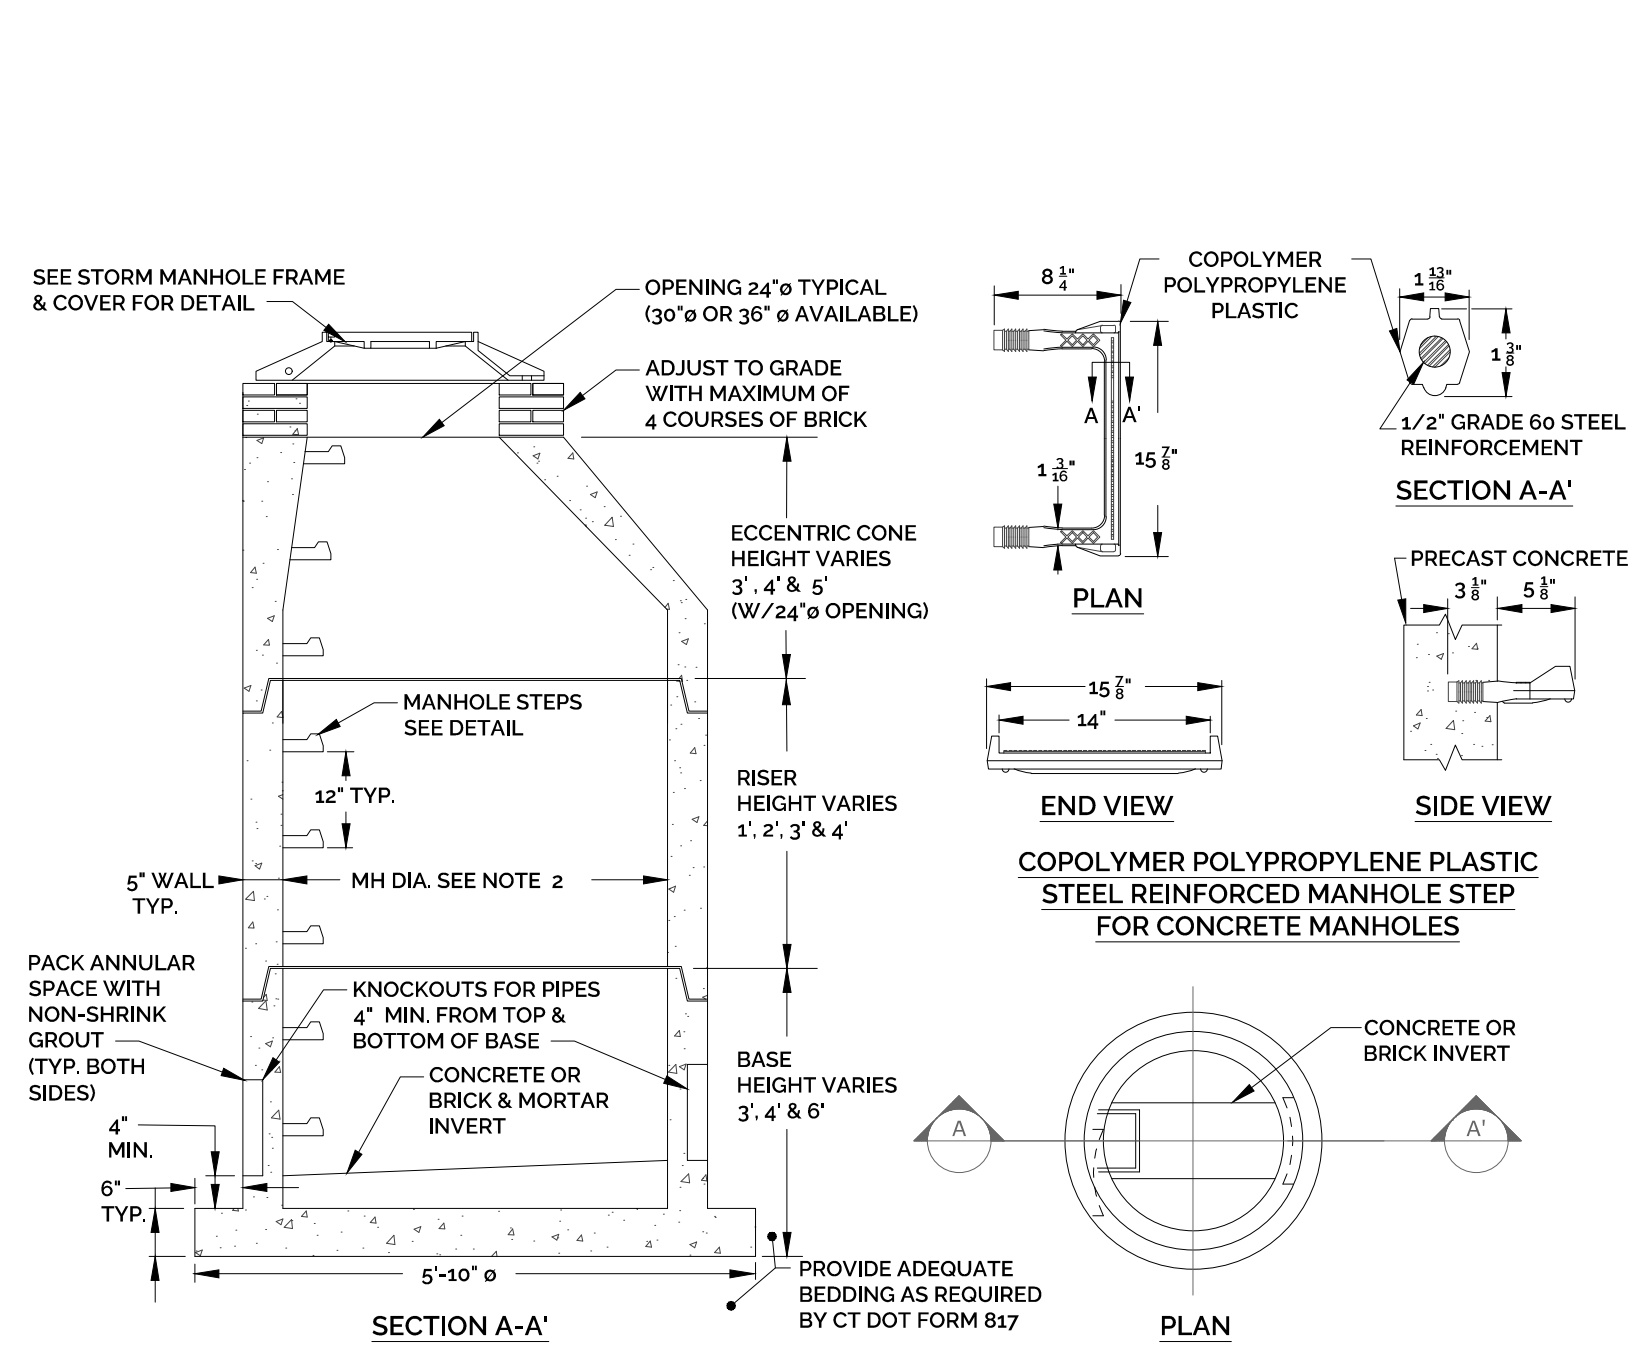


- NOTES:
1. PRECAST CONCRETE MANHOLE COMPONENTS SHALL CONFORM TO CT DOT STANDARD SHEET HW-507.10 AS AMENDED.
 2. 4", 5" OR 6" PRECAST CONCRETE BASE DIAMETERS MAY BE USED WHEN REQUIRED DUE TO SIZE OR NUMBER OF PIPES AT THE MANHOLE. PRECAST REDUCERS WILL BE PLACED ABOVE THE 5" AND 6" BASES AS DIRECTED BY THE ENGINEER. WALL THICKNESS SHALL INCREASE 1" FOR EACH 1" OF INSIDE DIAMETER INCREASE.
 3. JOINT SEALANT SHALL BE BUTYL RUBBER MASTIC TYPE SEAL THAT CONFORMS TO LATEST AASHTO SPECIFICATION M-198 & MEETS FEDERAL SPECIFICATION SS-5-0021210-A).
 4. REINFORCING STEEL DEFORMED BARS ARE NOT SHOWN AND SHALL CONFORM TO LATEST CT DOT STANDARDS & SUPPLEMENTALS AND ASTM SPECIFICATION A615, GRADE 60, MINIMUM COVER 2", UNLESS OTHERWISE NOTED.
 5. ALL PIPE OPENINGS SHALL BE CLOSED USING MATERIALS WHICH CONFORM TO STATE OF CT STANDARD SPECIFICATIONS SECTION M.08.02.
 6. REINFORCING STEEL WELDED WIRE FABRIC SHALL CONFORM TO LATEST ASTM SPECIFICATION A185.
 7. CONCRETE COMPRESSIVE STRENGTH SHALL BE MINIMUM 4000 PSI AT 28 DAYS, SELF COMPACTING CONCRETE MIX.
 8. MANHOLE STEPS SHALL MEET LATEST OSHA REGULATIONS, (29 CFR 1910.27), SECTION 16 OF ASTM SPECIFICATION C478 AND SECTION 10 OF ASTM SPECIFICATION C407.
 9. WHEN SPECIFIED, MANHOLES ARE TO BE COATED WITH BAY OIL, "EBONY".
 10. METHOD OF MANUFACTURE SHALL BE WET CAST.
 11. BASE SECTION IS MONOLITHIC.
 12. MANHOLE INTERIOR DIAMETER:
 - 4'-0" FOR 8" TO 36" PIPE DIAMETERS
 - 5'-0" FOR 42" PIPE DIAMETER
 - 6'-0" FOR 48" PIPE DIAMETER.
- REFERENCE: CT DOT HIGHWAY STANDARDS, SHEET HW-507.04 & HW-507.10, CT DOT FORM 817 AND (MANHOLE STEPS) THE METROPOLITAN DISTRICT SEWER STANDARD DETAILS FIG. 5-34, DATED JAN. 2017.

STANDARD PRECAST CONCRETE STORM MANHOLE DETAIL
NOT TO SCALE

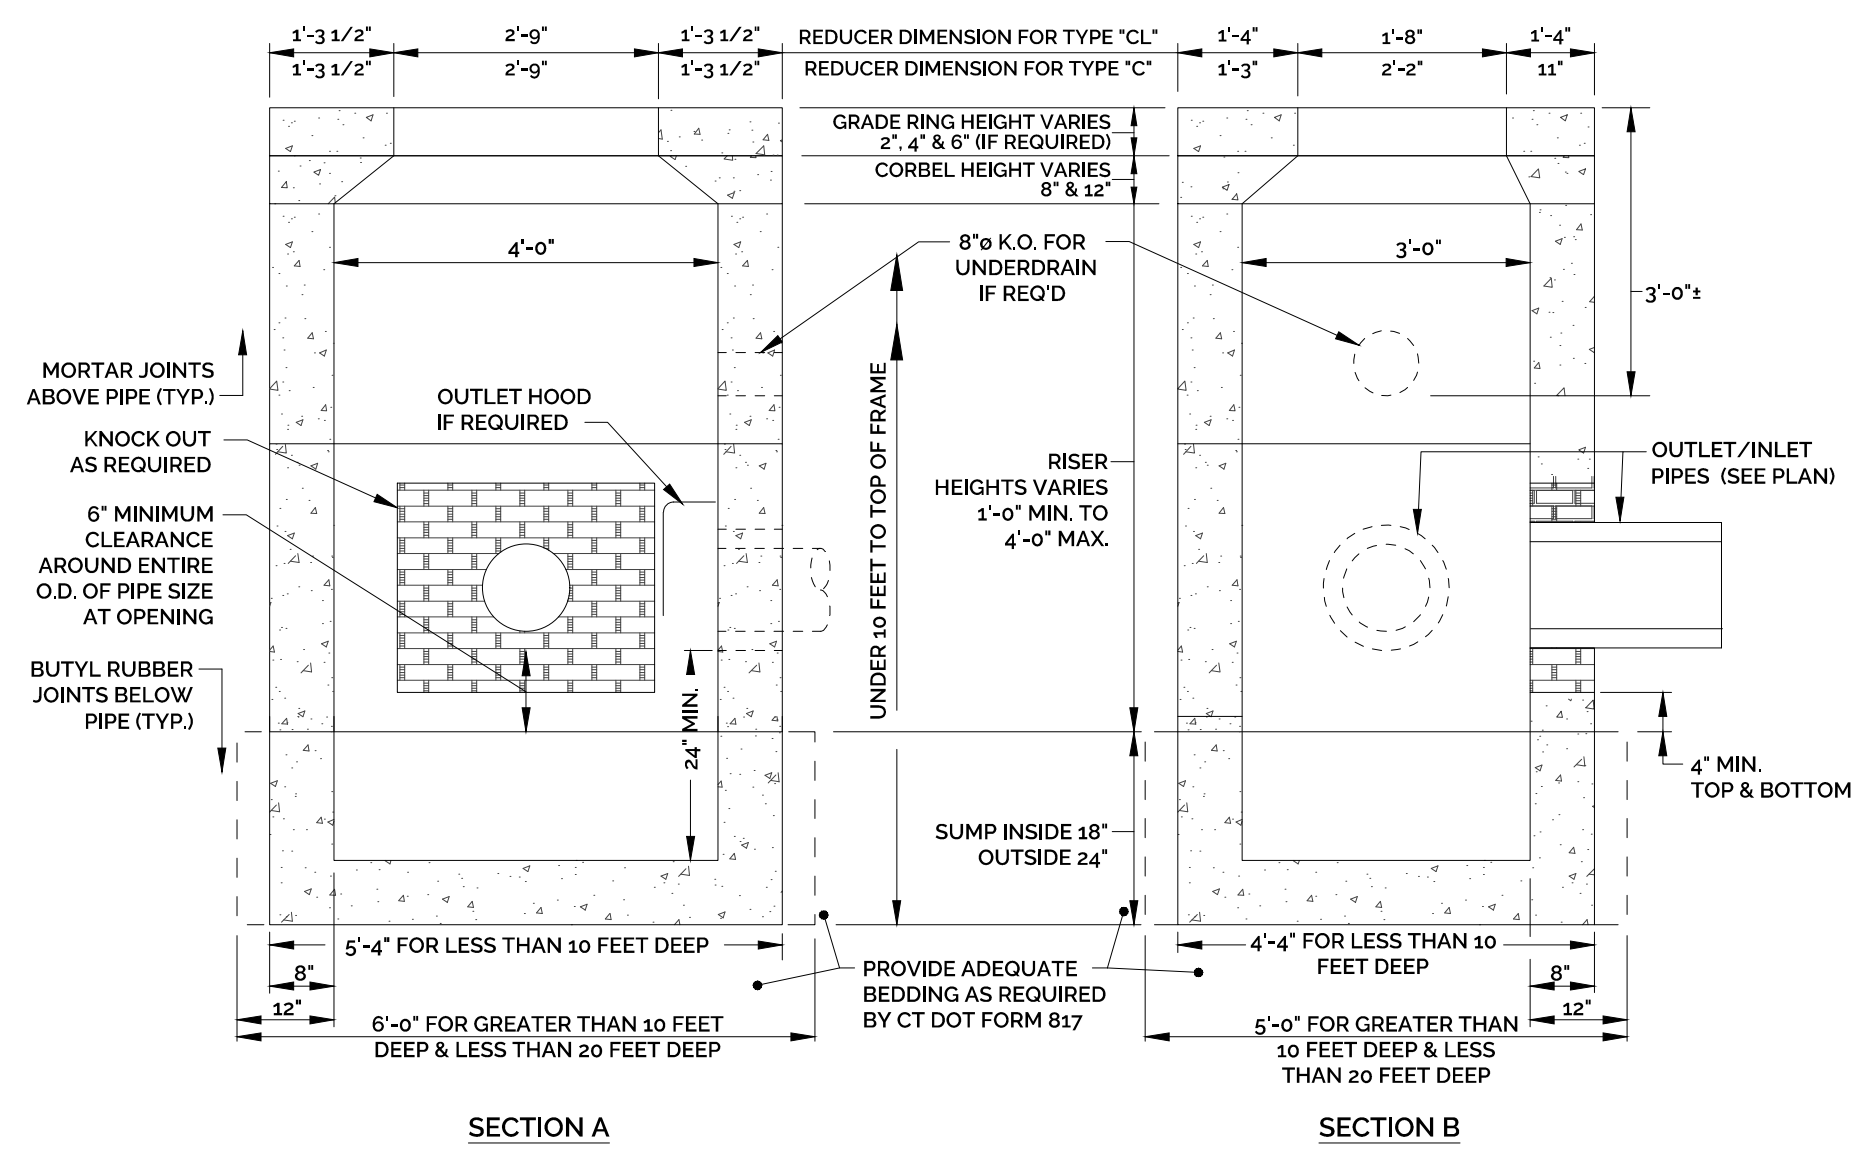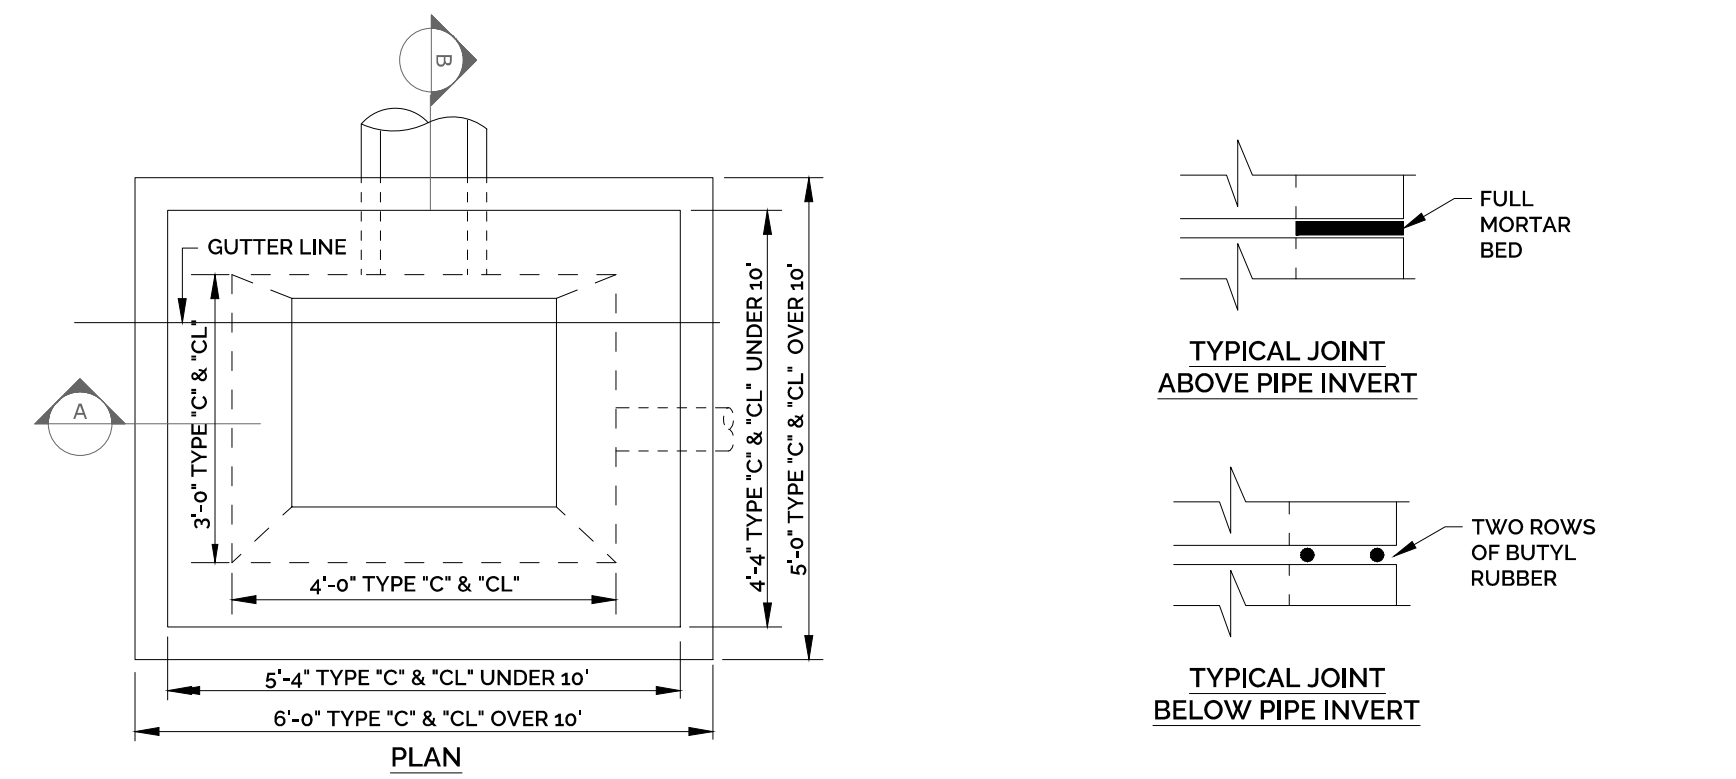


- NOTES:
1. PRECAST CONCRETE CATCH BASIN COMPONENTS SHALL CONFORM TO CT DOT FORM 817 STANDARD SPECIFICATION FOR ROADS, BRIDGES AND INCIDENTAL CONSTRUCTION AND CT DOT HIGHWAY STANDARD SHEETS HW-507.04, HW-507.07 & HW-507.08, AS AMENDED.
 2. THIS DETAIL IS BASED ON CT DOT PRECAST CONCRETE TYPE 'C' & 'CL' CATCH BASIN COMPONENTS, (UNDER 10' DEEP SHOWN).
 3. REINFORCING STEEL DEFORMED BARS ARE NOT SHOWN AND SHALL CONFORM TO LATEST CT DOT STANDARDS & SUPPLEMENTALS AND ASTM SPECIFICATION A615, GRADE 60, MINIMUM COVER 2" UNLESS OTHERWISE NOTED.
 4. METHOD OF MANUFACTURE SHALL BE WET CAST.
 5. SUMP SECTION SHALL BE MONOLITHIC.
 6. DESIGN LOAD SHALL BE AASHTO H-20.
- REFERENCE: CT DOT HIGHWAY STANDARDS, SHEET HW-507.04, HW-507.07 & HW-507.08, CT DOT FORM 817, AND UNITED CONCRETE PRODUCTS, AUGUST 2015

TYPE "C" AND "CL" PRECAST CONCRETE CATCH BASIN DETAILS
NOT TO SCALE

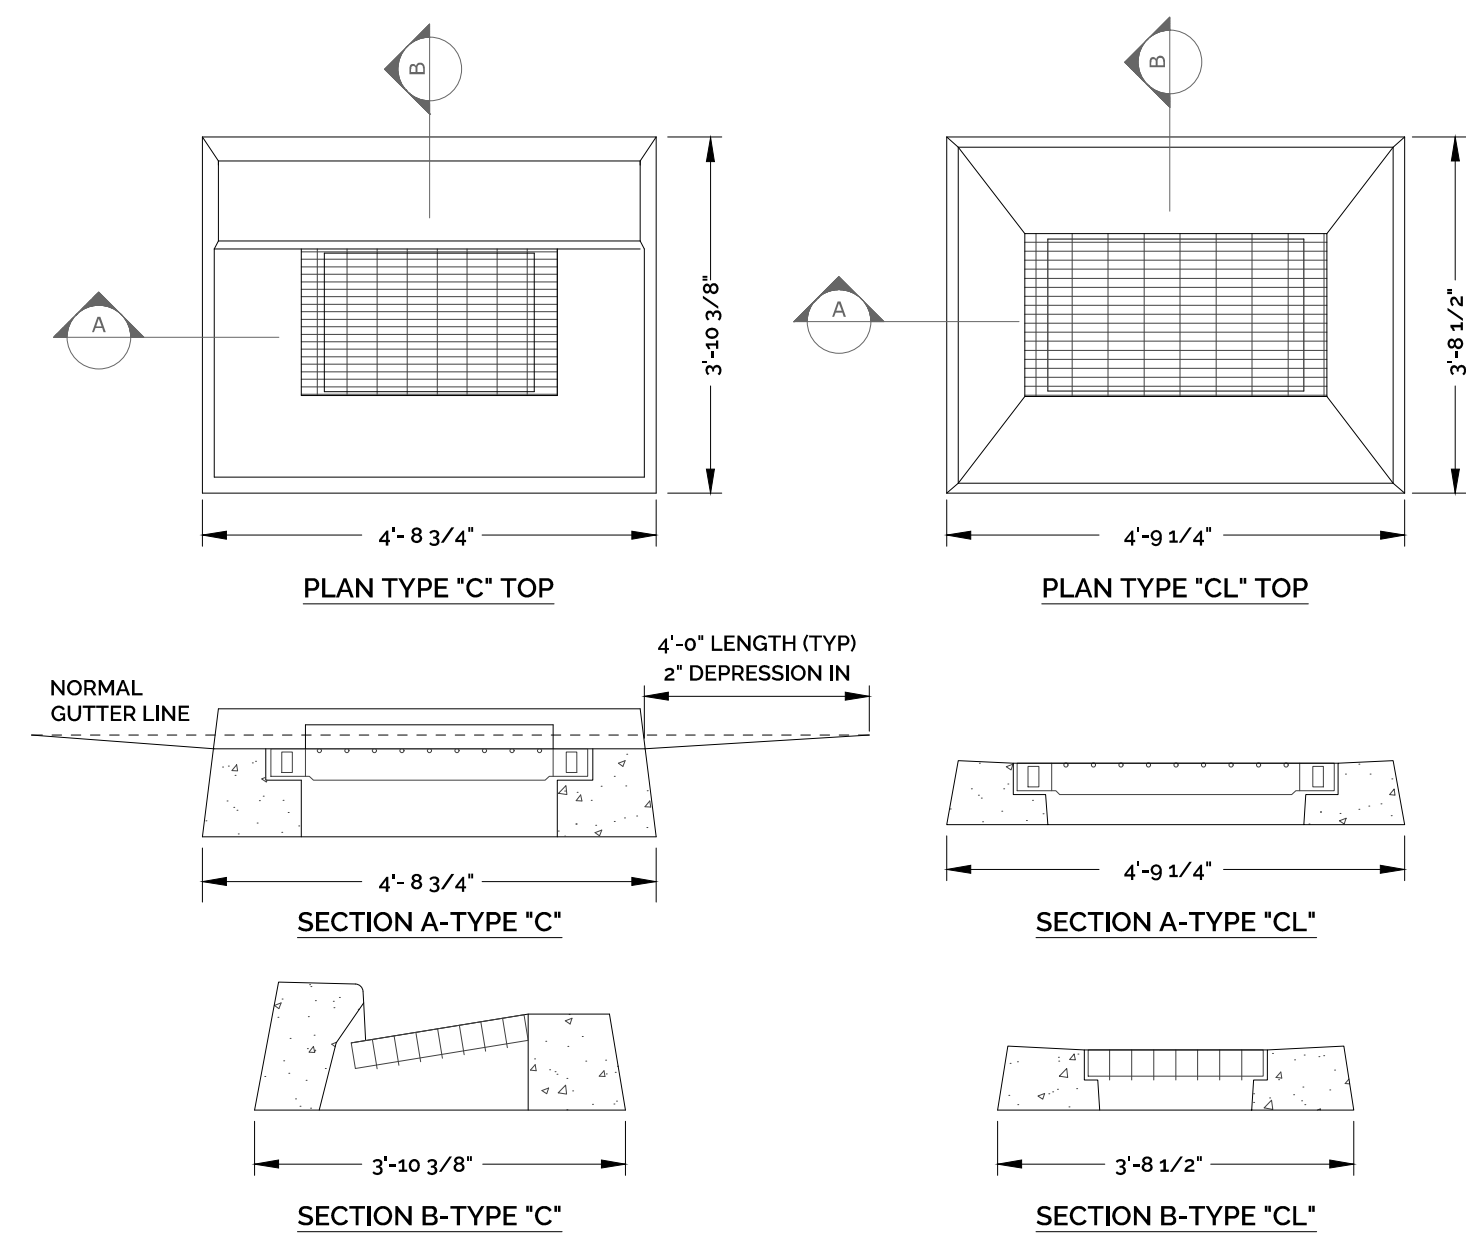


- NOTES:
1. CATCH BASIN TOPS, CURBS AND GRATE COMPONENTS SHALL CONFORM TO CT DOT FORM 817 STANDARD SPECIFICATION FOR ROADS, BRIDGES AND INCIDENTAL CONSTRUCTION AND CT DOT HIGHWAY STANDARD SHEETS HW-507.07 AND HW-507.08, AS AMENDED.
 2. REINFORCING STEEL DEFORMED BARS ARE NOT SHOWN AND SHALL CONFORM TO LATEST CT DOT STANDARDS & SUPPLEMENTALS AND ASTM SPECIFICATION A615, GRADE 60, MINIMUM COVER 2" UNLESS OTHERWISE NOTED.
 3. ALL STEEL, EXCEPT REINFORCING BARS, SHALL BE GALVANIZED IN CONFORMANCE WITH SECTION M06.03 OF CONNECTICUT STANDARD SPECIFICATIONS.
 4. TYPE 'C' CATCH BASIN DEPRESSED GUTTER STRIPS SHALL CONFORM TO CT DOT STANDARD SHEET HW-507.01, AS AMENDED.
- REFERENCE: CT DOT HIGHWAY STANDARDS, SHEET HW-507.04, HW-507.07 & HW-507.08, CT DOT FORM 817, AND UNITED CONCRETE PRODUCTS, AUGUST 2015.

TYPE "C" AND "CL" CATCH BASIN TOP DETAILS
NOT TO SCALE

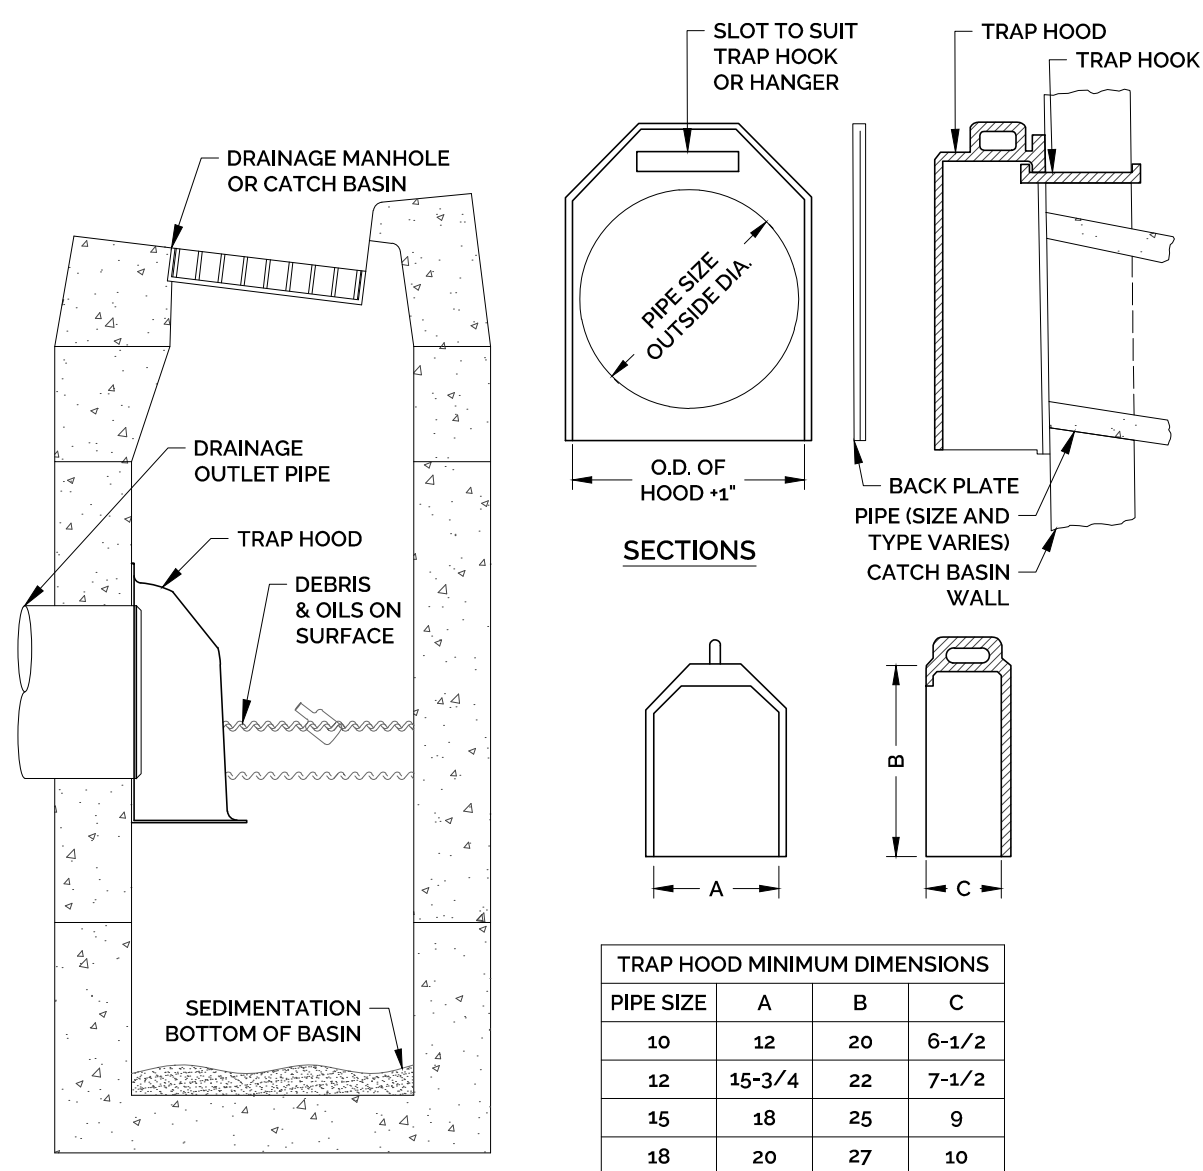

- NOTES:
1. TRAP HOODS SHALL BE CAST IRON FOR 10", 12", 15" AND 18" PIPE SIZES AND FABRICATED ALUMINUM FOR 21" OR GREATER.
 2. ALL TRAP HOODS SHALL INCLUDE STAINLESS STEEL HOOKS OR HANGERS FOR MOUNTING TO THE CATCH BASIN WALL. BACK PLATES SHALL BE FURNISHED ONLY WHEN REQUESTED.
 3. TRAP HOODS SHALL BE FROM CAMPBELL FOUNDRY, NEENAH FOUNDRY, EAST JORDAN IRON WORKS OR APPROVED EQUAL. DIMENSIONS AND MODEL NUMBERS VARY BASED ON DISCHARGE PIPE SIZE AND MANUFACTURER.
 4. SEE MANUFACTURER FOR INSTALLATION INSTRUCTIONS.

CATCH BASIN TRAP HOOD DETAIL
NOT TO SCALE

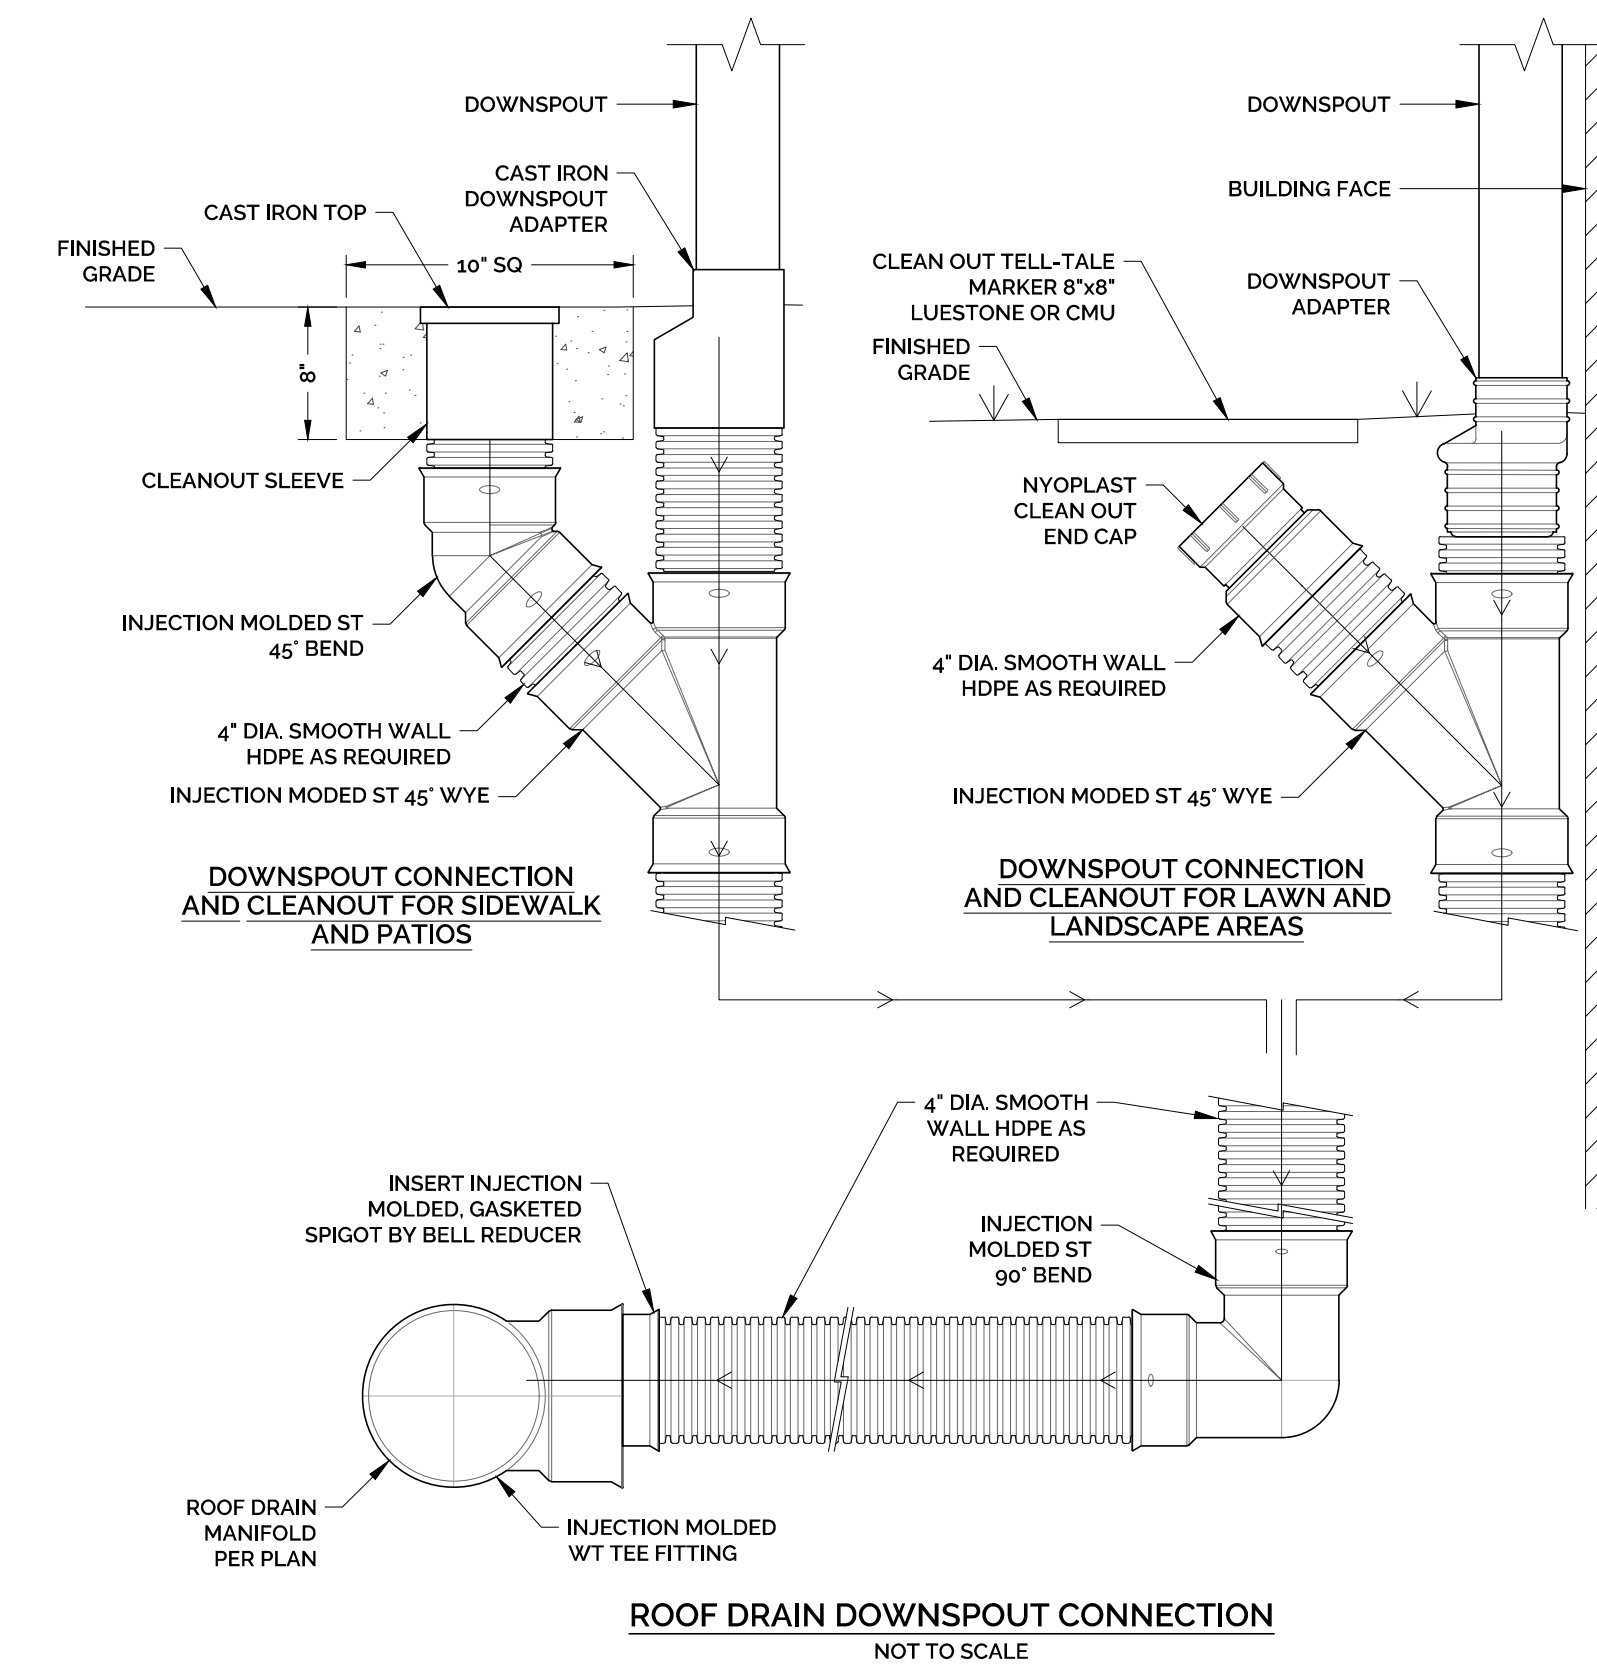

ROOF DRAIN DOWNSPOUT CONNECTION
NOT TO SCALE

DRAINAGE DETAILS

VESEL MULTI-FAMILY HOUSING
PROPERTY ADDRESS
446 HOPMEADOW STREET, SIMSBURY, CT 06089
PREPARED FOR
VESEL RE HOLDINGS, LLC
46 WEST 55TH STREET, NEW YORK, NY 10019

PROJECT NO. 2022-0013	SCALE NOT TO SCALE
DRAWN BY: SMM	DATE 12/16/2022
CHECKED BY: SMM	DATE 12/16/2022

DRAWING
DT-3

SHEET NUMBER: 11 OF 13



STAMP

NO.	REVISIONS PER ENGINEERING REVIEW COMMENTS & IWA COMMENTS	DATE	SHM	SHM	SHM	APPR.
3	REVISIONS PER ENGINEERING REVIEW COMMENTS & IWA COMMENTS	3/30/2023				
2	REVISIONS PER ENGINEERING REVIEW COMMENTS & IWA COMMENTS	3/17/2023				
1	REVISIONS PER REVIEW COMMENTS	2/24/2023				
REV	DESCRIPTION OF REVISION					


UTILITY DETAILS

VESSEL MULTI-FAMILY HOUSING
PROPERTY ADDRESS
446 HOPMEADOW STREET, SIMSBURY, CT 06089
PREPARED FOR
VESSEL RE HOLDINGS, LLC
46 WEST 55TH STREET, NEW YORK, NY 10019

PROJECT NO.	SCALE
2022-0013	NOT TO SCALE
DRAWN BY:	DATE
SMM	12/16/2022
CHECKED BY:	DATE
SMM	12/16/2022
DRAWING	
DT-4	
SHEET NUMBER: 12 OF 13	

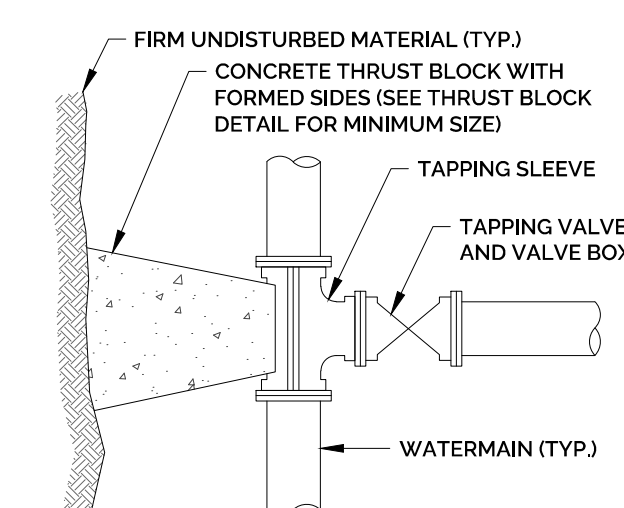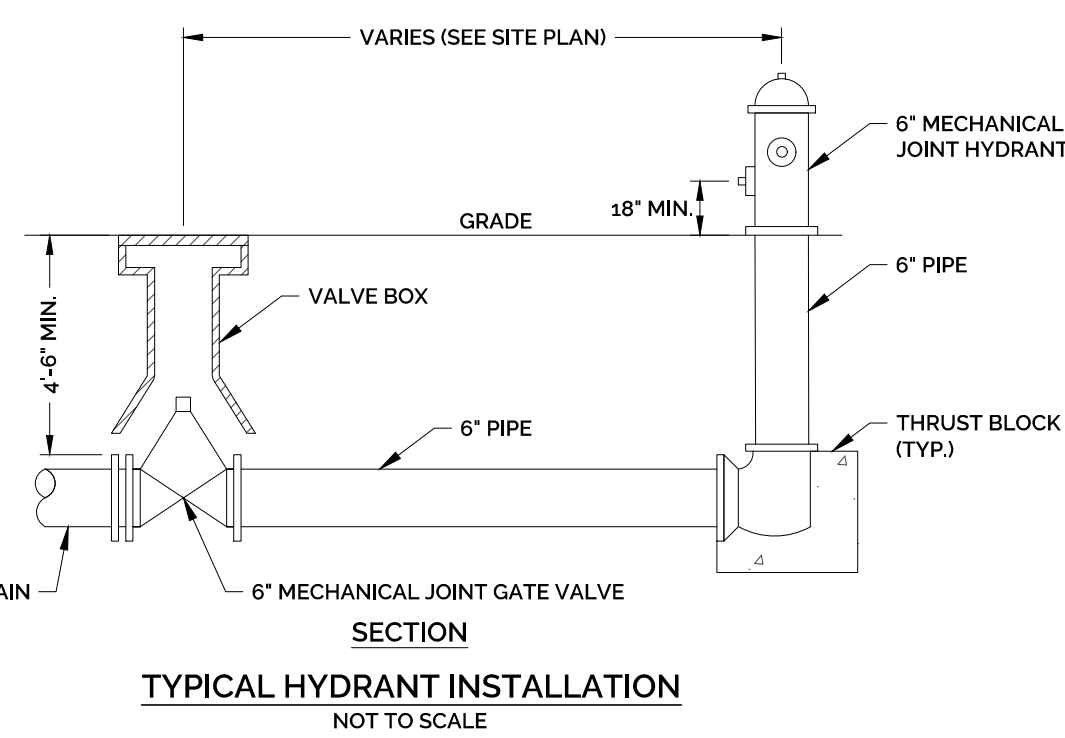


NOTE: CONTRACTOR TO VERIFY OUTSIDE DIAMETER OF EXISTING MAIN.

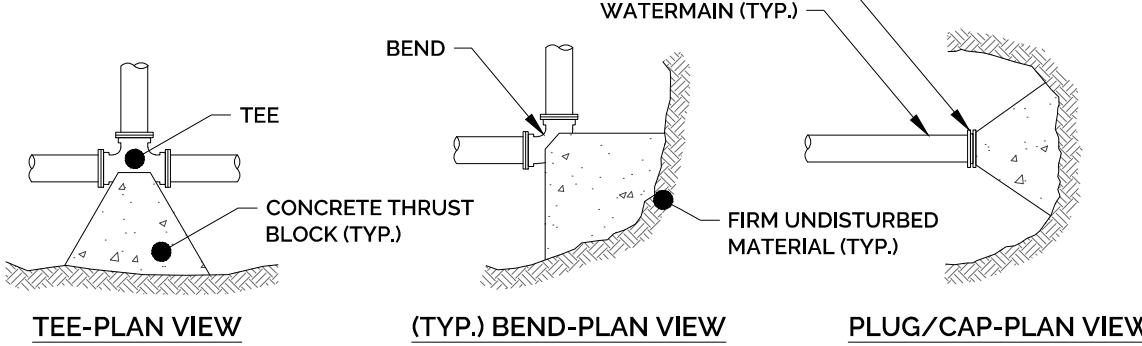

SIZE OF MAIN (IN.)	BEND (90°)	BENDS (45° & UNDER)	TEES, CAPS OR PLUGS
8 & UNDER	6	3	4
10 & 12	12	6	9


- NOTES:
- CONCRETE FOR THRUST BLOCKS SHALL HAVE A MINIMUM COMPRESSIVE STRENGTH OF 2000 PSI AT 28 DAYS.
 - THRUST BLOCK BEARING AREAS TO BE IN ACCORDANCE WITH TABLE, UNLESS DETERMINED OTHERWISE BY THE ENGINEER BECAUSE OF SOIL CONDITIONS.
 - THRUST BLOCK SIDES SHALL BE FORMED WITH PLYWOOD.

THRUST BLOCK DETAILS
NOT TO SCALE

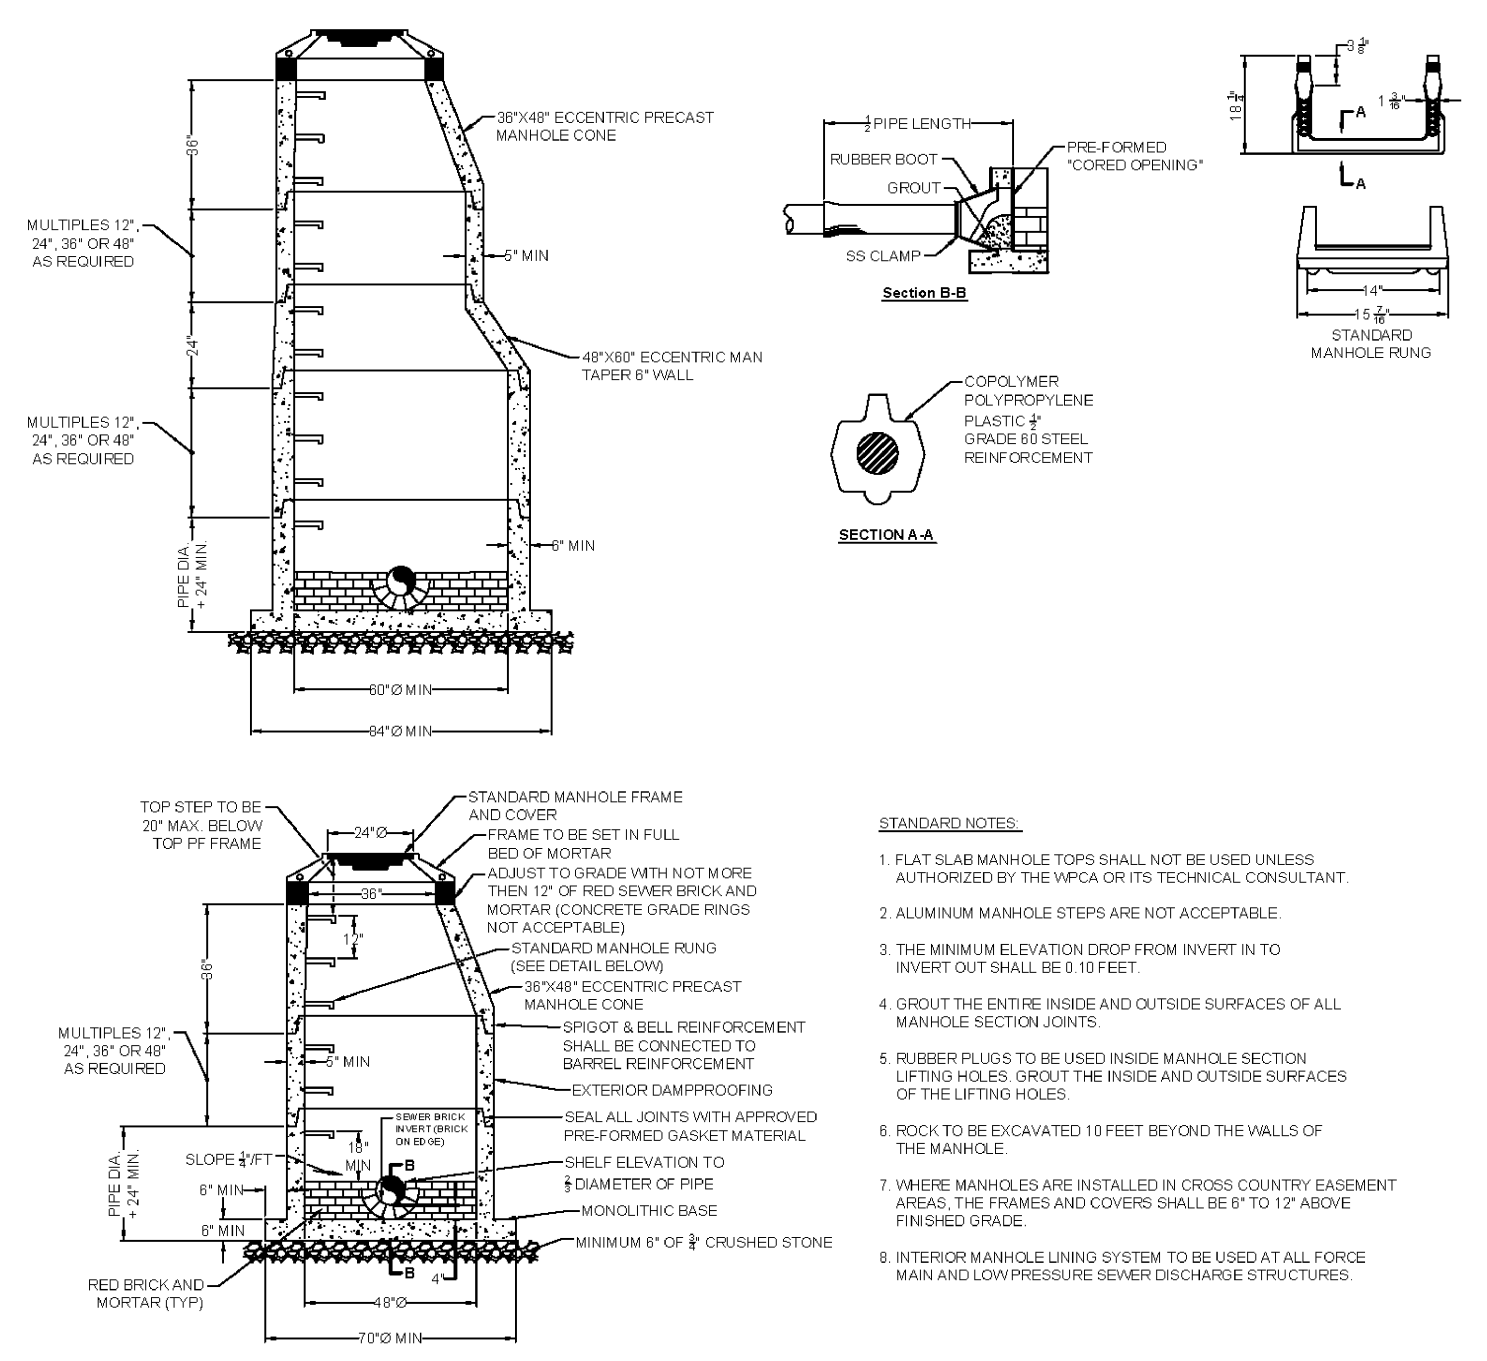



- STANDARD NOTES:
- FLAT SLAB MANHOLE TOPS SHALL NOT BE USED UNLESS AUTHORIZED BY THE WPCA OR ITS TECHNICAL CONSULTANT.
 - ALUMINUM MANHOLE STEPS ARE NOT ACCEPTABLE.
 - THE MINIMUM ELEVATION DROP FROM INVERT TO INVERT OUT SHALL BE 0.10 FEET.
 - GROUT THE ENTIRE INSIDE AND OUTSIDE SURFACES OF ALL MANHOLE SECTION JOINTS.
 - RUBBER PLOUGS TO BE USED INSIDE MANHOLE SECTION LIFTING HOLES. GROUT THE INSIDE AND OUTSIDE SURFACES OF THE LIFTING HOLES.
 - HOLES TO BE EXCAVATED 10 FEET BEYOND THE WALLS OF THE MANHOLE.
 - WHERE MANHOLES ARE INSTALLED IN CROSS COUNTRY EASEMENT AREAS, THE FRAMES AND COVERS SHALL BE 6" TO 12" ABOVE FINISHED GRADE.
 - INTERIOR MANHOLE LINING SYSTEM TO BE USED AT ALL FORCE MAIN AND LOW PRESSURE SEWER DISCHARGE STRUCTURES.

TOWN OF SIMSBURY DETAIL - STANDARD SANITARY SEWER MANHOLE
NOT TO SCALE

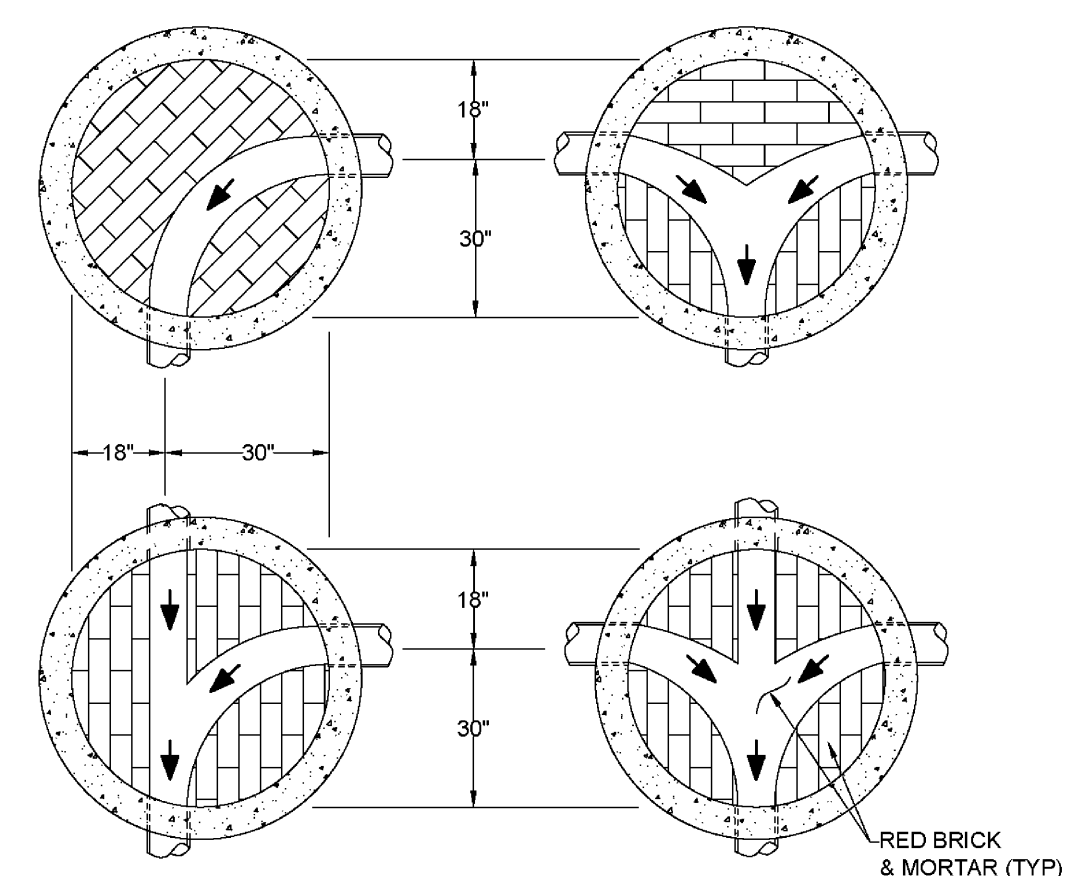


- STANDARD NOTES:
- DIMENSIONS SHOWN FOR STANDARD 48" DIAMETER MANHOLES AND GRAVITY SEWER CONSTRUCTION.
 - MAXIMUM CHANGE IN DIRECTION FOR FLOW STREAM SHALL BE 90 DEGREES.

TOWN OF SIMSBURY DETAIL - STANDARD MANHOLE INVERTS
NOT TO SCALE

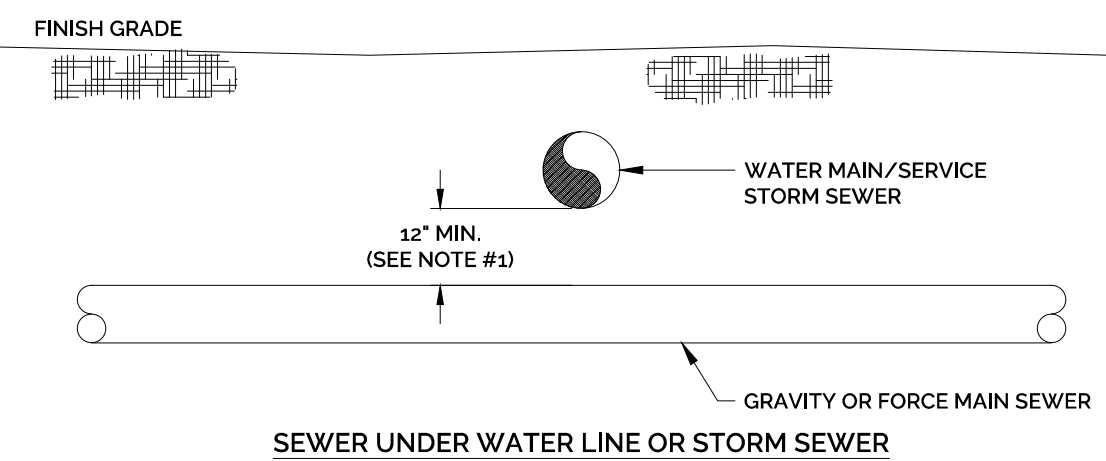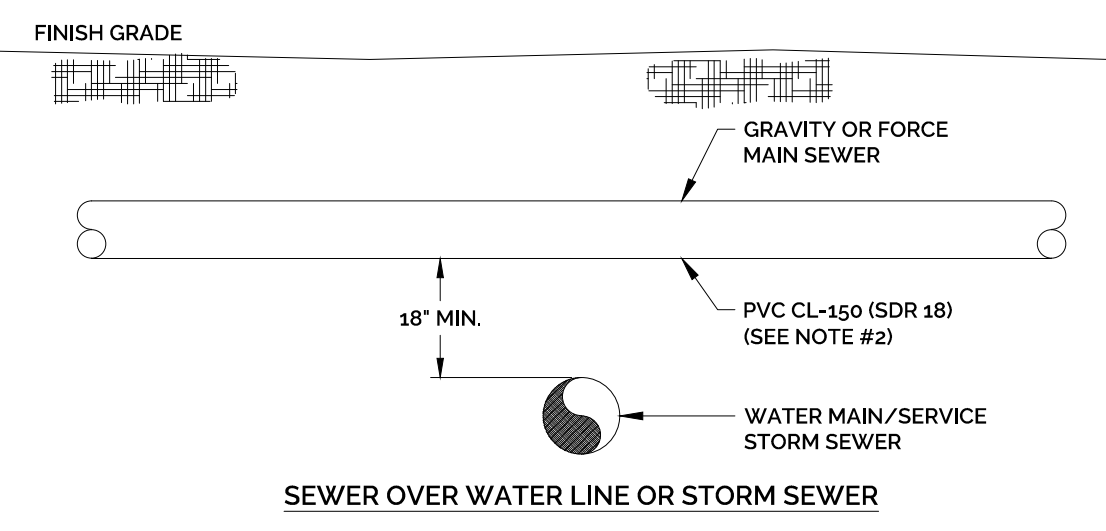


- NOTES:
- WHEN THE VERTICAL SEPARATION DISTANCE IS 12"-18" THE SEWER SHALL BE PVC CL-150 (SDR 18) FOR A DISTANCE OF 10'-0" ON EITHER SIDE OF THE WATER LINE OR STORM SEWER. WHEN THE SEPARATION DISTANCE IS GREATER THAN 18", STANDARD SEWER PIPE MATERIAL (SDR 35) MAY BE USED.
 - THE SEWER PIPE SHALL BE PVC CL-150 (SDR 18) FOR A DISTANCE OF 10'-0" ON EITHER SIDE OF THE WATER LINE OR STORM SEWER. NO PIPE JOINTS SHALL BE LOCATED WITHIN THE 10' DISTANCE EITHER SIDE.
 - THESE SEPARATION DISTANCES APPLY TO ANY SEWER WITHIN A TOWN RIGHT-OF-WAY OR EASEMENT.

VERTICAL SEPARATION DISTANCES
NOT TO SCALE

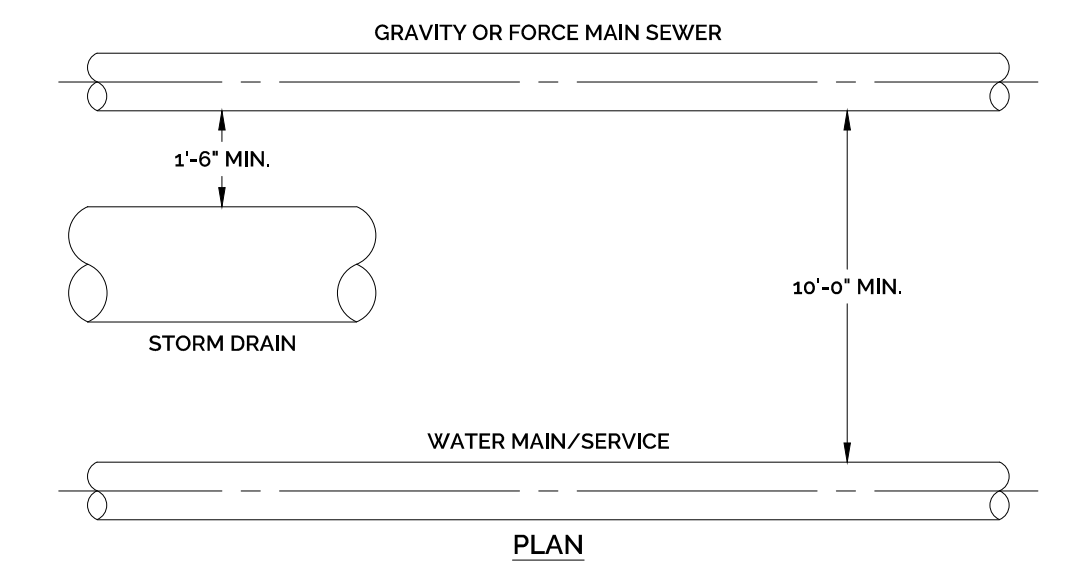


- NOTES:
- THESE SEPARATION DISTANCES APPLY TO ANY SEWER WITHIN A TOWN RIGHT-OF-WAY OR EASEMENT.
 - HORIZONTAL RESTRICTIONS FOR STORM SEWER ONLY APPLY WHEN PIPES ARE AT THE SAME ELEVATION.

HORIZONTAL SEPARATION DISTANCES
NOT TO SCALE

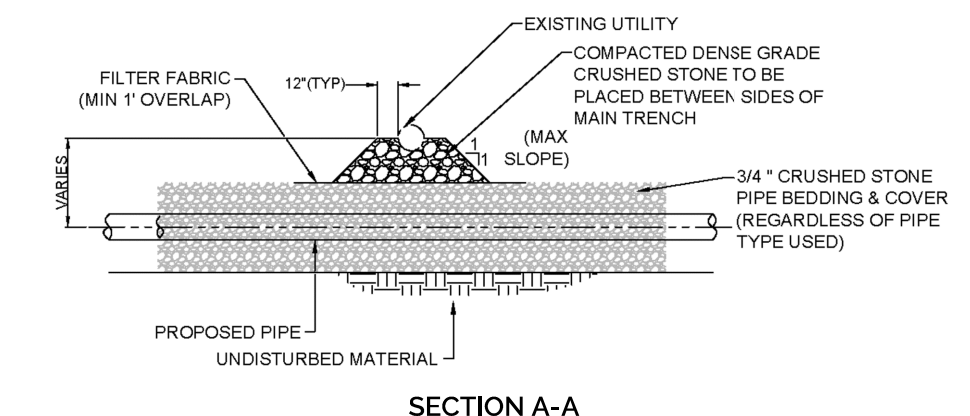


SECTION A-A

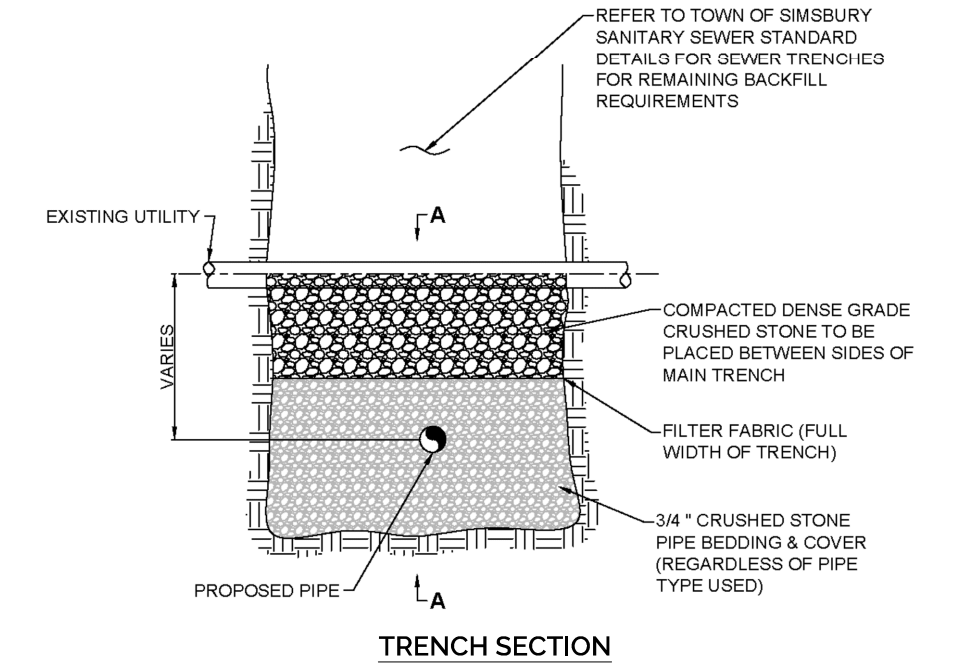


- STANDARD NOTES:
- PLACE 1" UNDERGROUND UTILITY WARNING TAPE UNDER THE EXISTING UTILITY REGARDLESS OF THE DISTANCE BETWEEN THE PIPES. PLACE AN ADDITIONAL LAYER OF WARNING TAPE ABOVE THE EXISTING PIPE.
 - PROVIDE THE APPROPRIATE UNDERGROUND UTILITY WARNING TAPE OVER THE EXISTING UTILITY PIPE THAT HAS BEEN DISTURBED DURING INSTALLATION OF THE SANITARY SEWER. PROVIDE WARNING TAPE REGARDLESS IF EXISTING PIPE WAS NOT DISCOVERED.

TOWN OF SIMSBURY DETAIL - PIPE SUPPORT UTILITY CROSSING
NOT TO SCALE

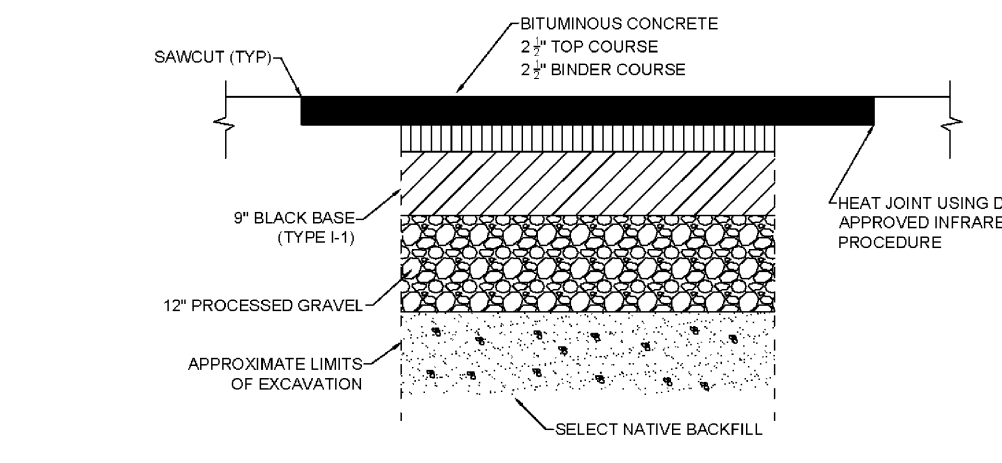


TOWN OF SIMSBURY DETAIL - PERMANENT TRENCH REPAIR
NOT TO SCALE

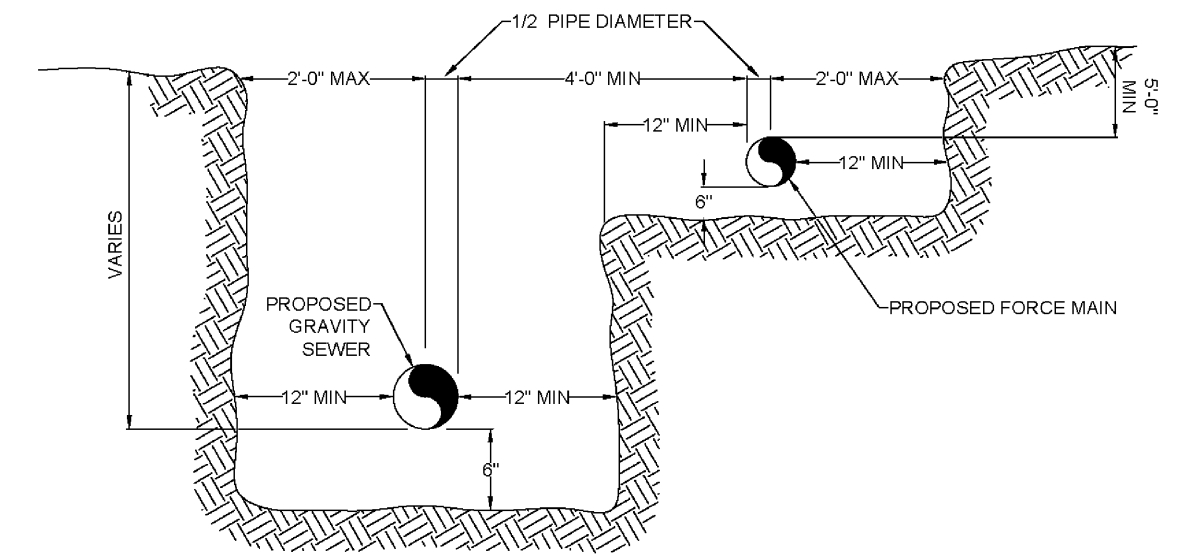

- STANDARD NOTES:
- REFER TO TOWN OF SIMSBURY SANITARY SEWER DETAILS FOR INDIVIDUAL SEWER PIPE TRENCH DETAILS.

TOWN OF SIMSBURY DETAIL - COMMON GRAVITY SEWER & FORCE MAIN TRENCH
NOT TO SCALE

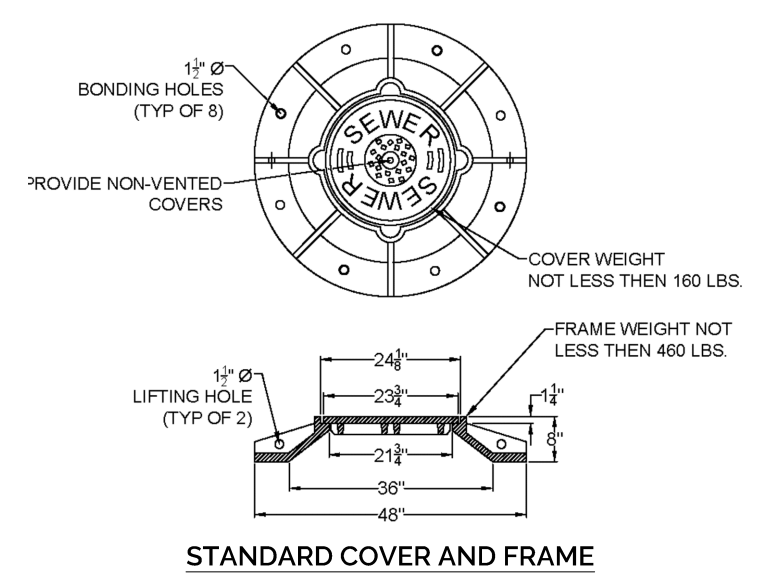


- STANDARD NOTES:
- COVER TO BE NON-VENTED, METROPOLITAN DISTRICT COMMISSION AND/CO STANDARD.
 - WATERTIGHT MANHOLE FRAMES AND COVERS SHALL ONLY BE USED AS DIRECTED BY THE WPCA OR TECHNICAL CONSULTANT. USE SHALL BE LIMITED TO ITS LOW PRESSURE SEWER AND FORCE MAIN STRUCTURES, OR IN FLOOD PLAIN AREAS.

TOWN OF SIMSBURY DETAIL - STANDARD MANHOLE FRAME & COVER
NOT TO SCALE

- NOTES:
- SELECT BACKFILL MATERIAL SHALL BE BANK-RUN GRAVEL GRADATION C, FORM 817, 2019, OR PROCESSED AGGREGATE CAN BE USED IN LIEU OF BANK-RUN GRAVEL OR APPROVED NATIVE MATERIAL.
 - ALL MATERIALS AND CONSTRUCTION METHODS SHALL CONFORM TO CONNECTICUT DOT STANDARD SPECIFICATIONS FOR ROADS, BRIDGES AND INCIDENTAL CONSTRUCTION FORM 817, 2019 OR AS AMENDED.
 - ALL UTILITIES SHALL BE INSTALLED IN ACCORDANCE WITH ALL MUNICIPAL AND UTILITY AUTHORITY REQUIREMENTS AND SPECIFICATIONS.
 - ALL PROPOSED MATERIALS SHALL BE INSTALLED AS SHOWN OR MATCH EXISTING CONDITIONS AS APPROVED BY THE MUNICIPALITY.
 - CONTRACTOR RESPONSIBLE FOR EXCAVATION, BEDDING, CONDUIT & BACKFILL.

TYPICAL E/T/C UTILITY TRENCH
NOT TO SCALE

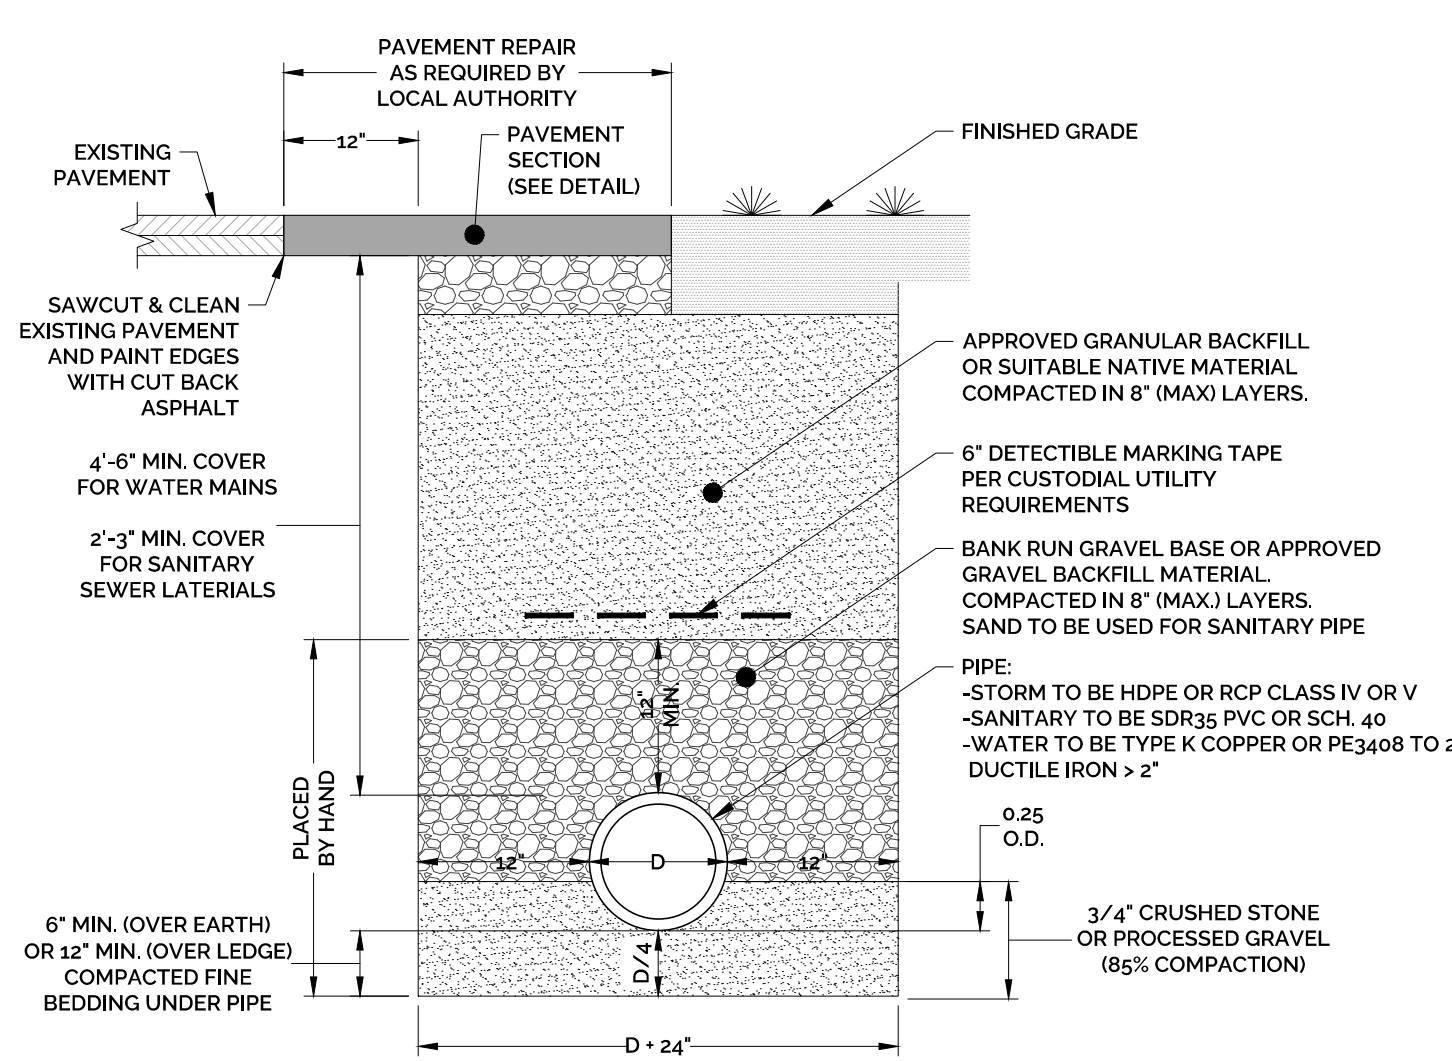


- NOTES:
- SELECT BACKFILL MATERIAL SHALL BE BANK-RUN GRAVEL GRADATION C, FORM 817, 2019, OR PROCESSED AGGREGATE CAN BE USED IN LIEU OF BANK-RUN GRAVEL OR APPROVED NATIVE MATERIAL.
 - ALL MATERIALS AND CONSTRUCTION METHODS SHALL CONFORM TO CONNECTICUT DOT STANDARD SPECIFICATIONS FOR ROADS, BRIDGES AND INCIDENTAL CONSTRUCTION FORM 817, 2019 OR AS AMENDED.
 - ALL UTILITIES SHALL BE INSTALLED IN ACCORDANCE WITH ALL MUNICIPAL AND UTILITY AUTHORITY REQUIREMENTS AND SPECIFICATIONS.
 - ALL PROPOSED MATERIALS SHALL BE INSTALLED AS SHOWN OR MATCH EXISTING CONDITIONS AS APPROVED BY THE MUNICIPALITY.
 - USE WATERTIGHT RUBBER CASSETS ASTM C443 IN ALL PIPE JOINTS.

TYPICAL TRENCH
NOT TO SCALE

ACCEPTABLE FILL MATERIALS: STORMTECH MC-3500 CHAMBER SYSTEMS

Table with 4 columns: MATERIAL LOCATION, DESCRIPTION, AASHTO MATERIAL CLASSIFICATIONS, COMPACTION / DENSITY REQUIREMENT

- PLEASE NOTE: 1. THE LISTED AASHTO DESIGNATIONS ARE FOR GRADATIONS ONLY. THE STONE MUST ALSO BE CLEAN, CRUSHED, ANGULAR...

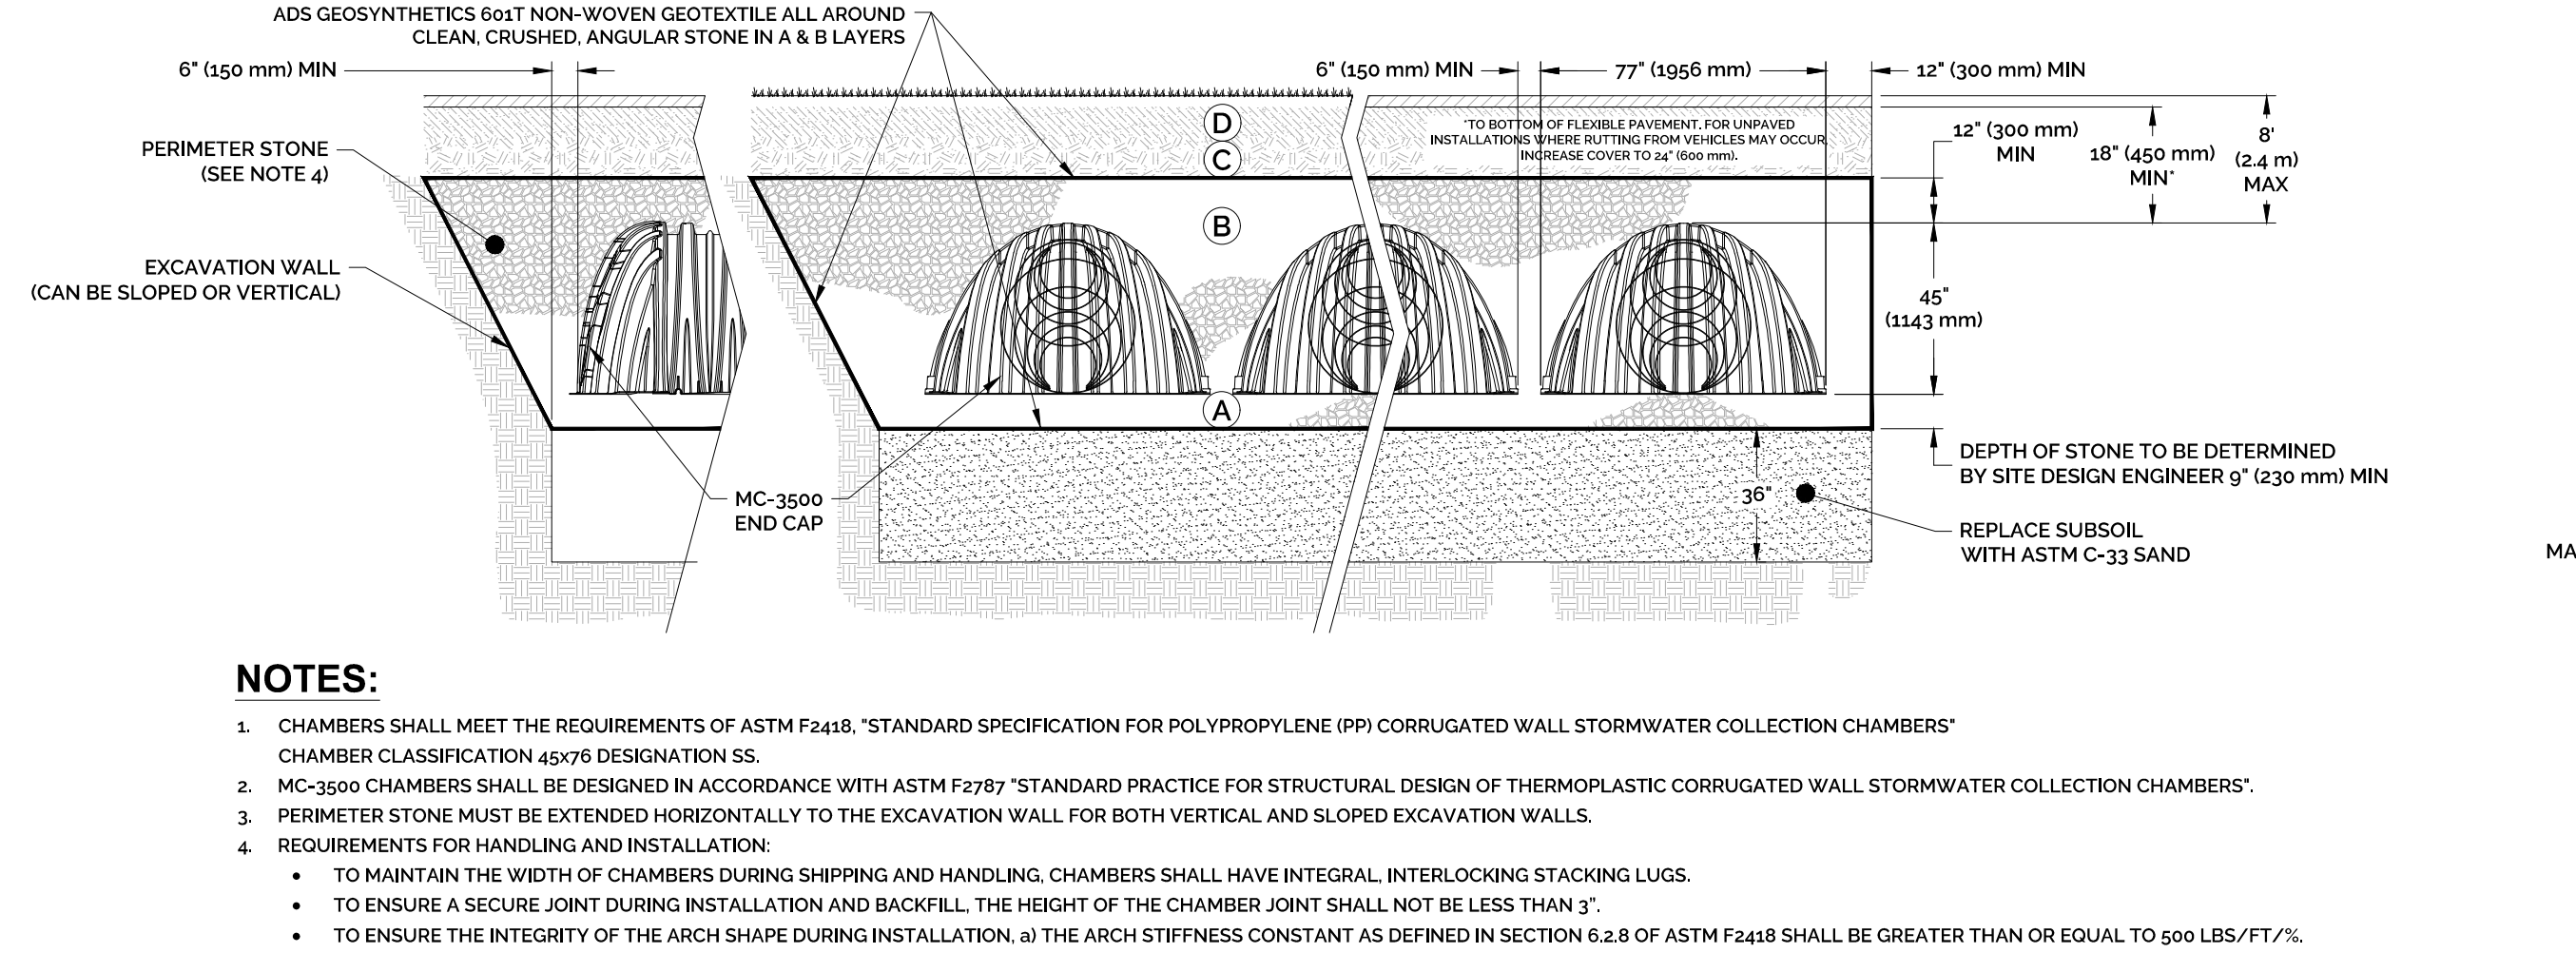

NOTES:

- 1. CHAMBERS SHALL MEET THE REQUIREMENTS OF ASTM F2418. 'STANDARD SPECIFICATION FOR POLYPROPYLENE (PP) CORRUGATED WALL STORMWATER COLLECTION CHAMBERS'...

ADS STORMTECH MC-3500 CROSS SECTION DETAIL

NOT TO SCALE

INSPECTION & MAINTENANCE


- STEP 1) INSPECT ISOLATOR ROW PLUS FOR SEDIMENT
A.1. INSPECTION PORTS (IF PRESENT)
A.2. REMOVE/OPEN LED ON NYLOPLAST INLINE DRAIN...

NOTES

- 1. INSPECT EVERY 6 MONTHS DURING THE FIRST YEAR OF OPERATION. ADJUST THE INSPECTION INTERVAL BASED ON PREVIOUS OBSERVATIONS...

ADS STORMTECH MC-3500 ISOLATOR ROW PLUS DETAIL

NOT TO SCALE

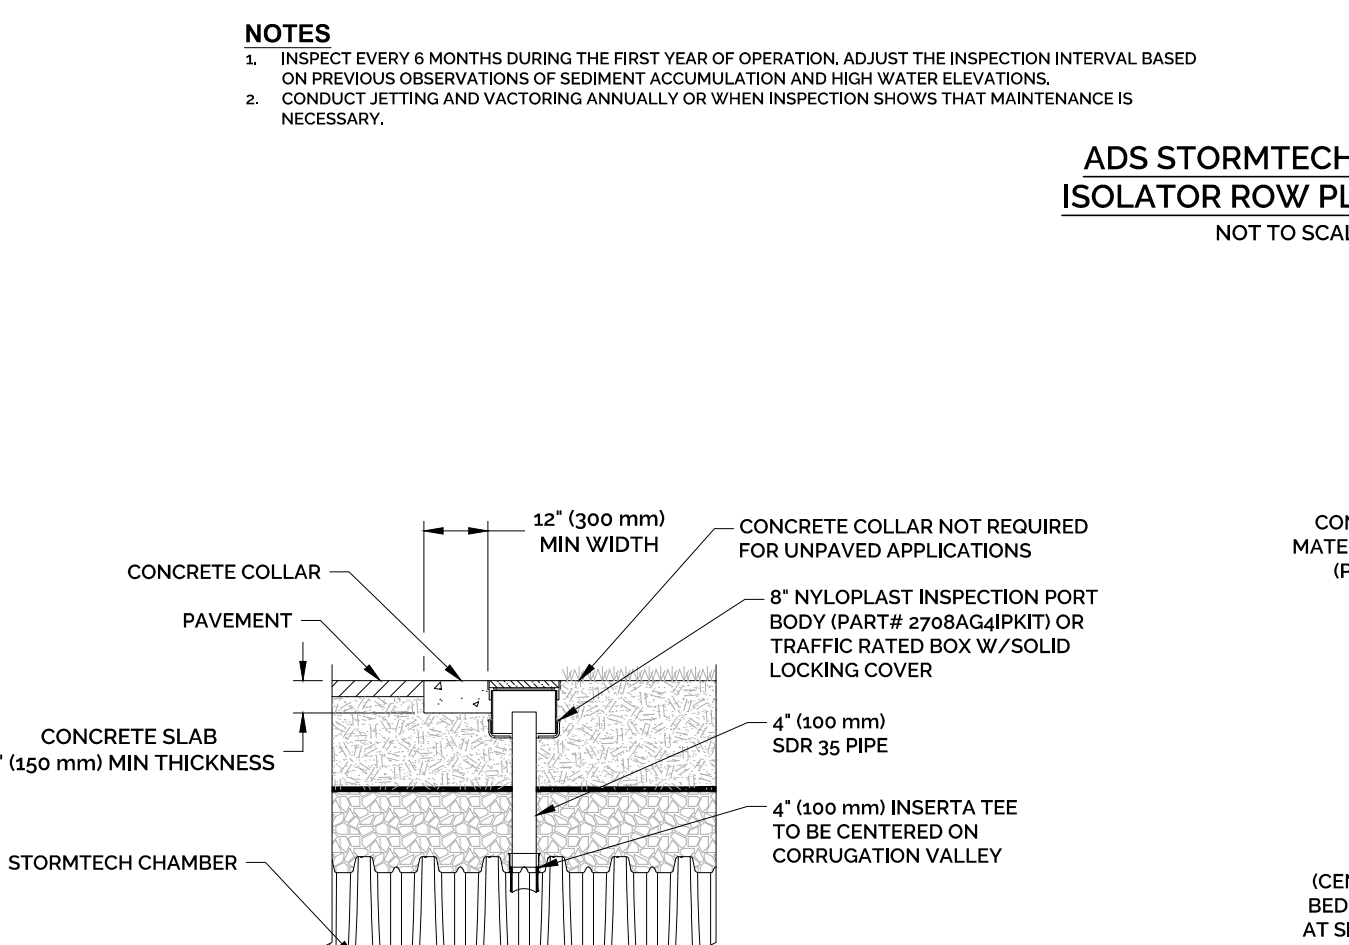

- NOTES: 1. INSPECTION PORTS MAY BE CONNECTED THROUGH ANY CHAMBER CORRUGATION VALLEY.

4" PVC INSPECTION PORT DETAIL (MC SERIES CHAMBER)

NOT TO SCALE


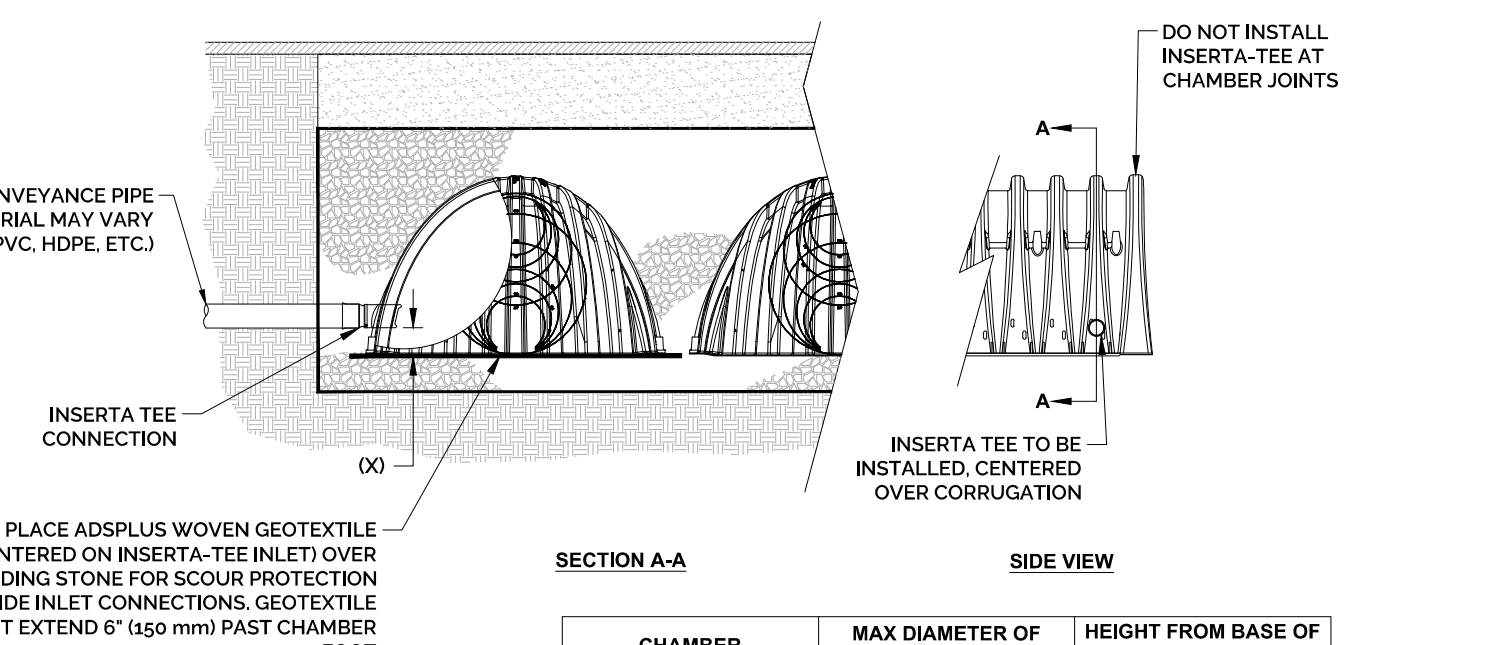


Table with 3 columns: CHAMBER, MAX DIAMETER OF INSERTA TEE, HEIGHT FROM BASE OF CHAMBER (X)


NOTES: 1. PART NUMBERS WILL VARY BASED ON INLET PIPE MATERIALS. CONTACT STORMTECH FOR MORE INFORMATION.

ADS STORMTECH INSERTA-TEE SIDE VIEW DETAIL


NOT TO SCALE

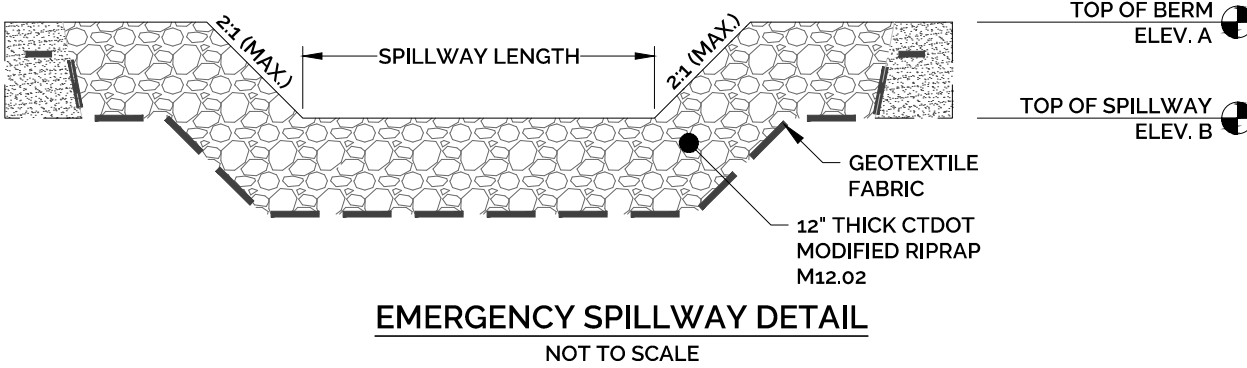

EMERGENCY SPILLWAY DETAIL NOT TO SCALE

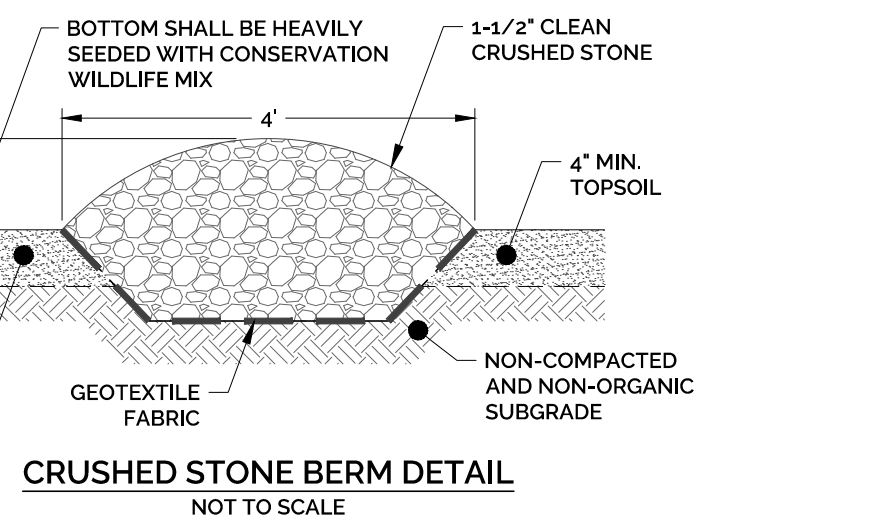

CRUSHED STONE BERM DETAIL NOT TO SCALE

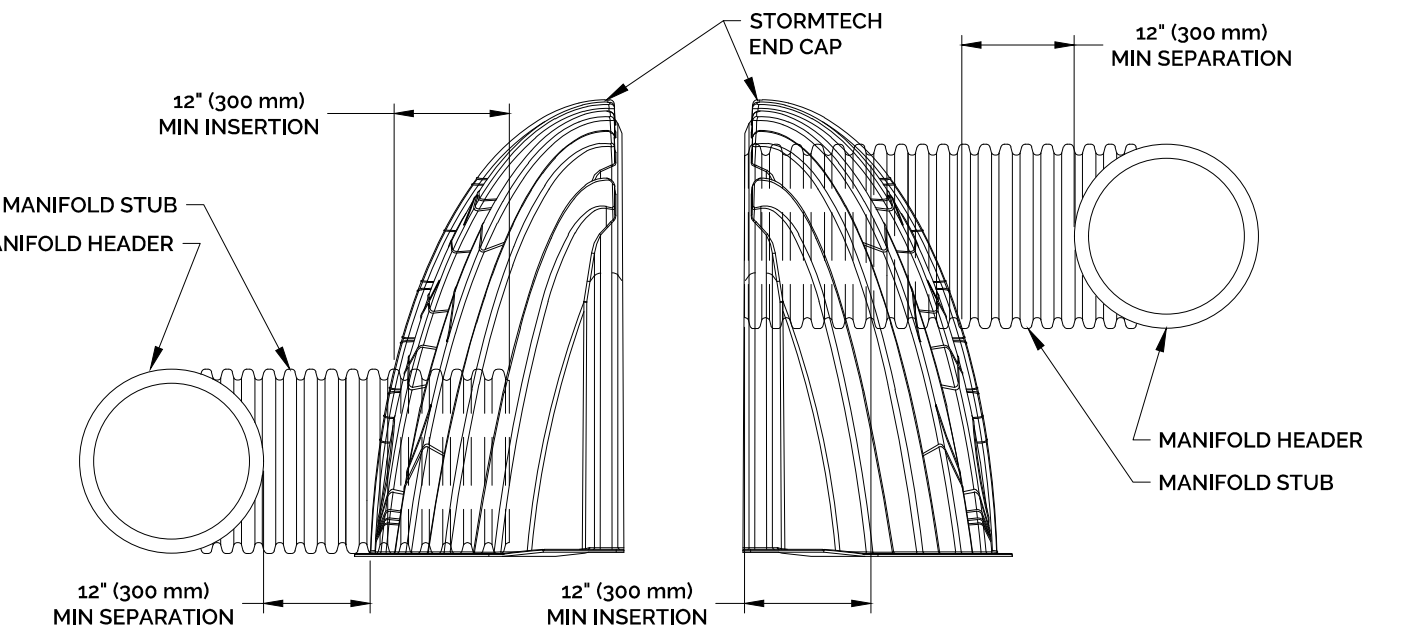

NOTE: MANIFOLD STUB MUST BE LAID HORIZONTAL FOR A PROPER FIT IN END CAP OPENING.

ADS STORMTECH MC-3500 END CAP INSERTION DETAIL

NOT TO SCALE

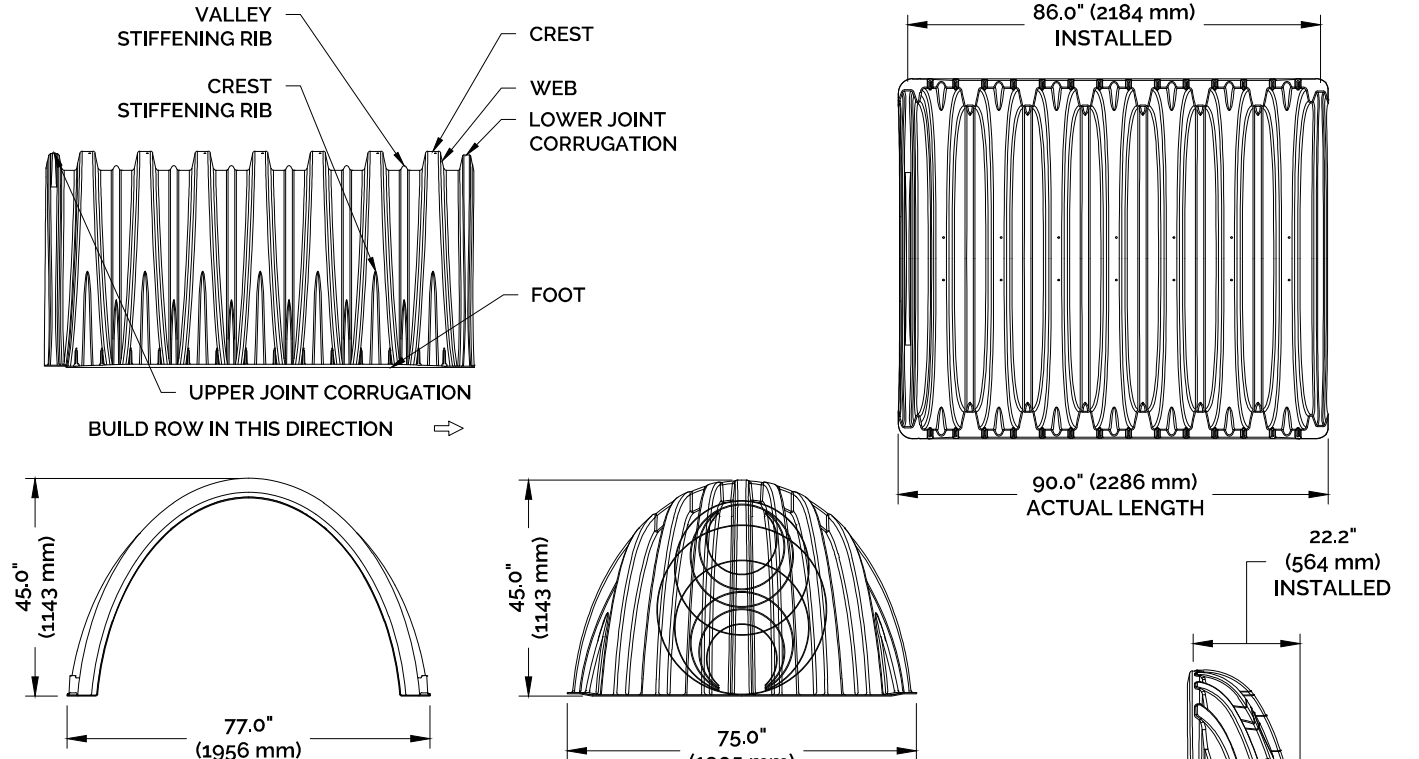


Table with 3 columns: PART #, SUB, B, C. Lists specifications for various chamber models.


*ASSUMES 12" (305 mm) STONE ABOVE, 9" (229 mm) STONE FOUNDATION, 6" (152 mm) STONE BETWEEN CHAMBERS, 6" (152 mm) STONE PERIMETER IN FRONT OF END CAPS AND 40% STONE POROSITY.

- CUSTOM PARTIAL CUT INVERTS ARE AVAILABLE UPON REQUEST. INVERTED MANIFOLDS INCLUDE 12-24" (300-600 mm) SIZE ON SIZE AND 15-18" (375-450 mm) SIZE ON SIZE.


ADS STORMTECH MC-3500 TECHNICAL SPECIFICATIONS

NOT TO SCALE

Table with 4 columns: BASIN ID, TOP OF BERM ELEV. A, TOP OF SPILLWAY ELEV. B, BOTTOM OF BASIN ELEV. C

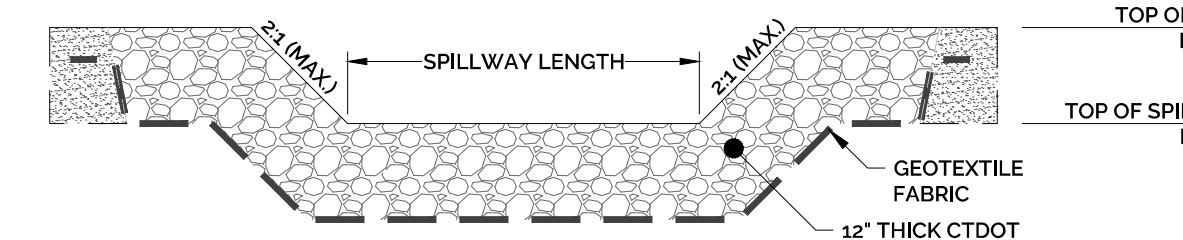

EMERGENCY SPILLWAY DETAIL NOT TO SCALE

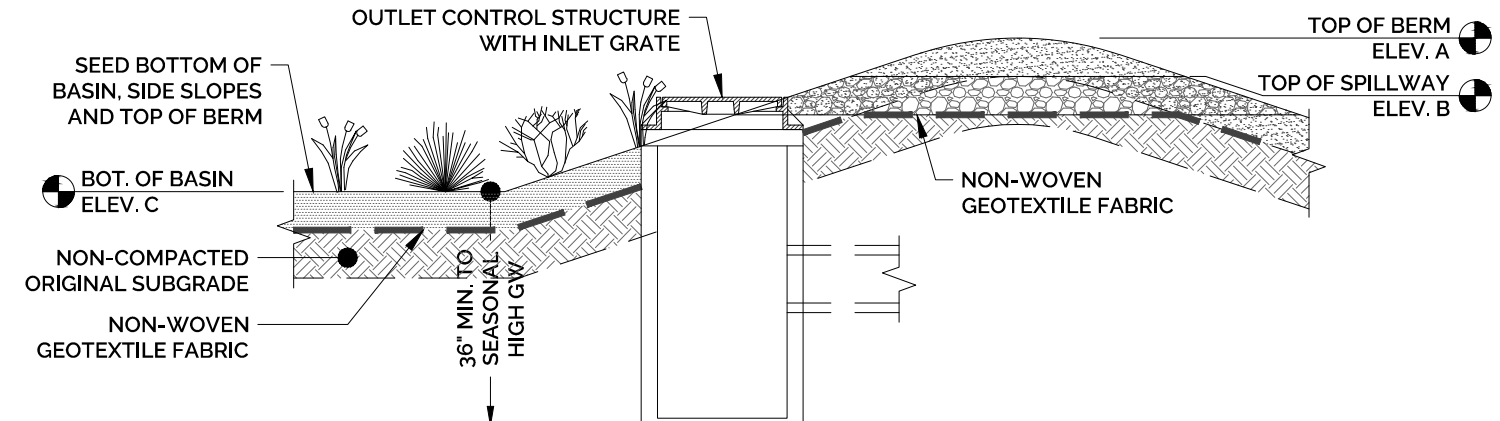

BIORETENTION BASIN CONSTRUCTION SEQUENCE

- 1. REMOVE EXISTING TOPSOIL, SURFACE LEAF LITTER, ETC. FROM BIORETENTION BASIN AREA AND STOCKPILE FOR REUSE.
2. AVOID COMPACTION OF NATURAL SOILS WITHIN BOTTOM AREA OF BIORETENTION BASIN BY CONSTRUCTION EQUIPMENT...


BIORETENTION BASIN DETAILS

NOT TO SCALE


Table with 7 columns: STRUCTURE ID, TOP OF FRAME ELEV. A, TOP OF WEIR PLATE ELEV. B, UPPER ORIFICE INVERT ELEV. C, LOWER ORIFICE INVERT ELEV. D, INLET PIPE INVERT ELEV. E, OUTLET PIPE 1 INVERT ELEV. F, OUTLET PIPE 2 INVERT ELEV. G

INLET CONTROL STRUCTURE (ICS) AND OUTLET CONTROL STRUCTURE (OCS)

NOT TO SCALE

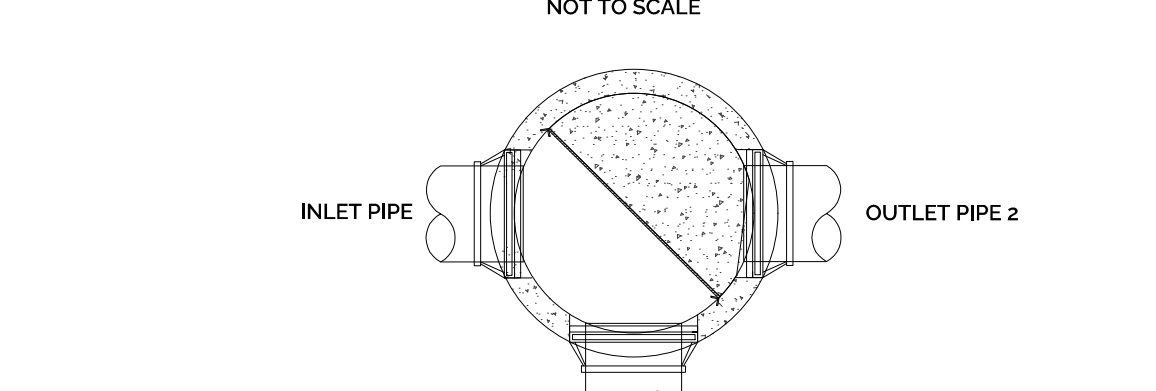

WEIR PLATE DETAIL

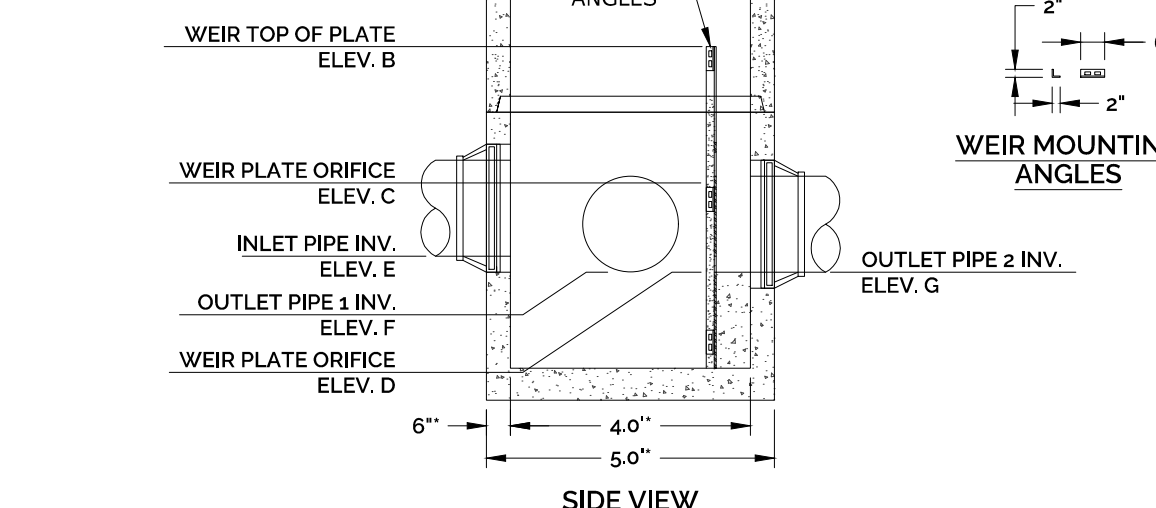

NOTE: 1/2" OR 6" DIA. PRECAST BASES MAY BE USED WHEN REQUIRED DUE TO SIZE OR NUMBER OF PIPES AT THE MANHOLE. PRECAST REDUCERS WILL BE PLACED ABOVE THE 6" AND 8" BASES...

INLET/OUTLET CONTROL STRUCTURE DETAIL

NOT TO SCALE

232 Greenmanville Avenue Suite 201 Mystic, CT 06355 860-980-8008 (O) 413-579-4488 (M) www.hh-engineers.com

STAMP

Table with columns: REVISIONS PER ENGINEERING REVIEW COMMENTS & IWA COMMENTS, DATE, DESCRIPTION OF REVISION

STORMWATER MANAGEMENT DETAILS VESSEL MULTI-FAMILY HOUSING

PROPERTY ADDRESS: 446 HOPMEADOW STREET, SIMSBURY, CT 06089 PREPARED FOR: VESSEL RE HOLDINGS, LLC 46 WEST 55TH STREET, NEW YORK, NY 10019

Table with columns: PROJECT NO., SCALE, DRAWN BY, DATE, CHECKED BY, DATE