

TARIFFVILLE CONNECTION, MULTI-USE TRAIL FROM HOPMEADOW ST. (RT.10 & 202) TO CURTISS AND PATTISON PARKS

TARIFFVILLE ROAD (CT ROUTE 315)
SIMSBURY, CONNECTICUT

REGULATORY PERMIT DRAWINGS MAY 2022

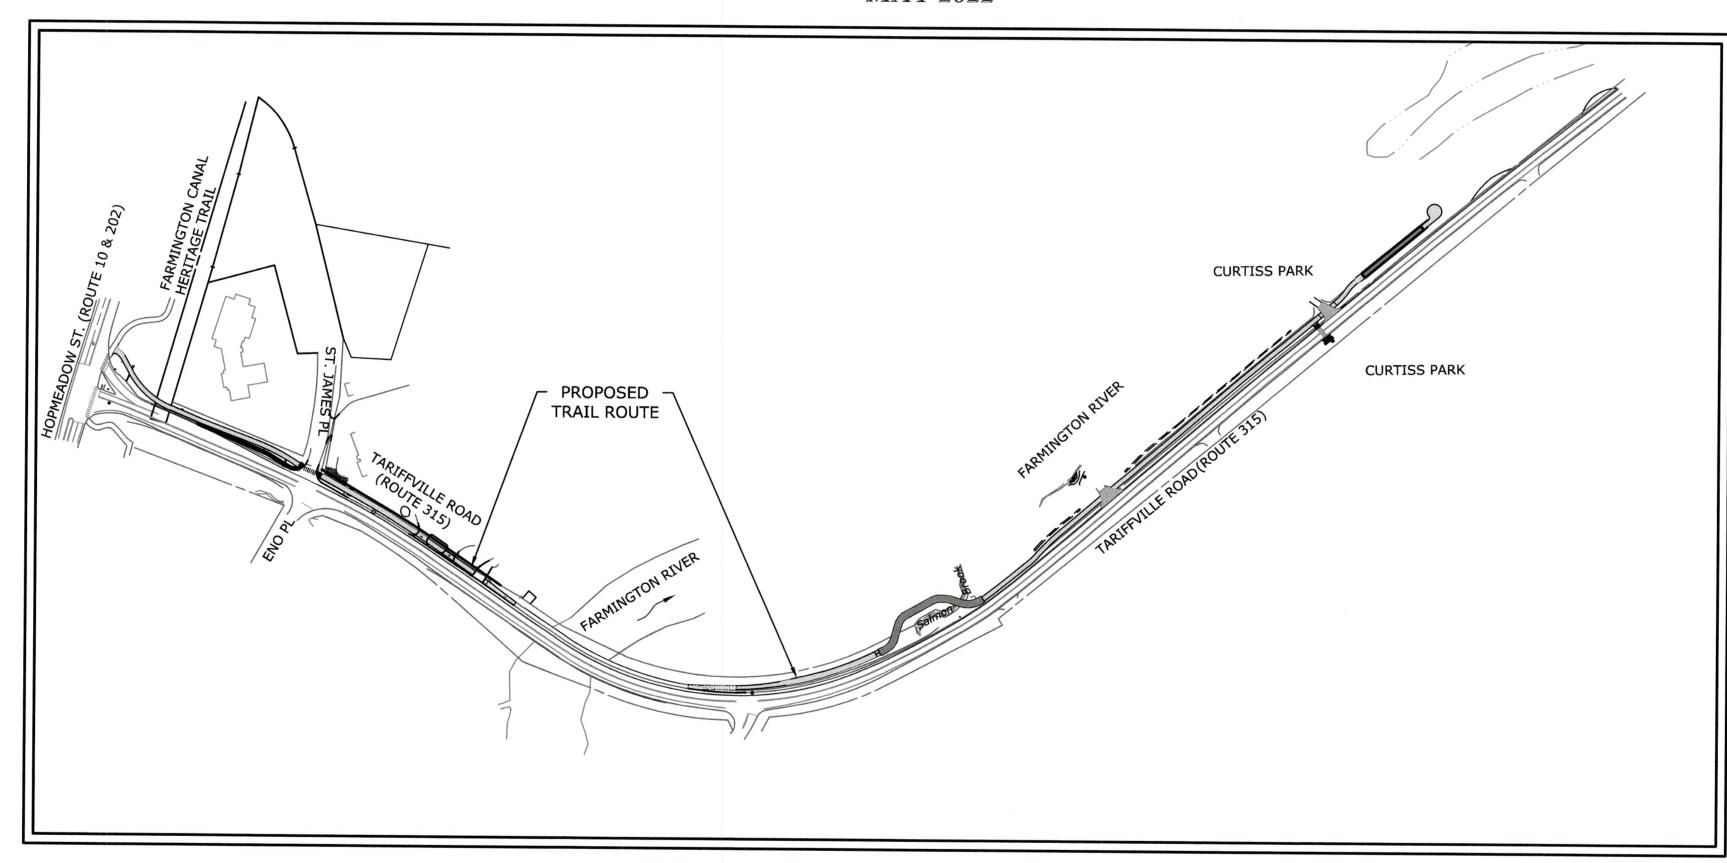

PROJECT SITE VICINITY MAP:

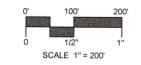

PREPARED BY:


SLR

99 REALTY DRIVE
CHESHIRE, CT 06410
203.271.1773


SLRCONSULTING.COM

PREPARED FOR:

TOWN OF SIMSBURY 933 HOPMEADOW STREET SIMSBURY, CONNECTICUT 06070

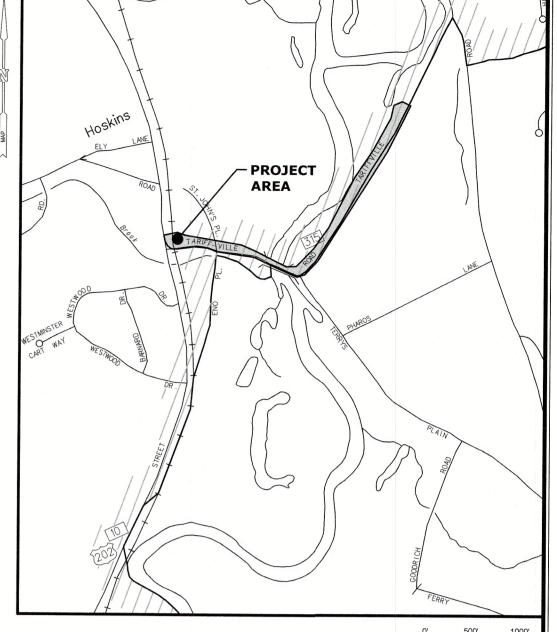

LOCATION MAP:

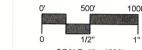


LIST OF DRAWINGS


NO.	NAME	TITLE
01	<u>-</u>	TITLE SHEET
02	IN	INDEX PLAN, NOTES AND TYPICAL SECTIONS
03	SD-1	MISCELLANEOUS DETAILS
04	SE-1	SEDIMENT & EROSION CONTROL DETAILS
05-07	BO-1 - BO-3	BORING LOGS
08-10	EX-1 - EX-3	EXISTING CONDITIONS & BASELINE LAYOUT PLAN
11-13	LA-1 - LA-3	LAYOUT PLAN
14	TCS-1	TRAFFIC CONTROL SIGNAL PLAN
15-19		F.A. HESKETH & ASSOCIATES, INC. ROADWAY PLANS
20-23	PRO-1 - PRO-4	TRAIL - PROFILE
24-26	RI-01A - RI-03A	REGULATORY IMPACT PLAN (STATE AND FEDERAL IMPACTS)
27-29	RI-01B - RI-03B	REGULATORY IMPACT PLAN (FLOODWAY AND FLOOD PLAIN IMPACTS)
30-31	STR-1 - STR-2	STRUCTURAL PLAN AND PROFILE
32-33	STRD-1 - STRD-2	STRUCTURAL DETAILS
34-45	XSC-1 - XSC-12	CROSS SECTIONS
		HIGHWAY STANDARDS
		TRAFFIC STANDARDS

APPROVED BY:

ERIC WELLMAN
FIRST SELECTMAN
TOWN OF SIMSBURY
DATE:

DESIGNED BY:

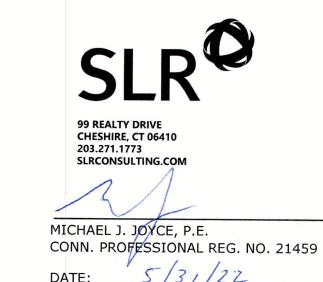

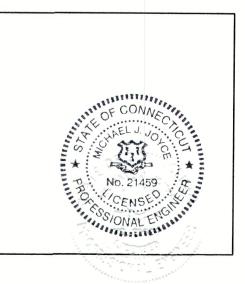



CT DOT - 818 CONSTRUCTION NOTES

INCIDENTAL CONSTRUCTION FORM 818 SECTION 12.11 AS REVISED.

LATEST SPECIAL PROVISIONS AND TYPICAL STATE STANDARD DETAILS.

FLOOD CONTINGENCY PLAN

NATIONAL WEATHER SERVICE (NORTON, MASS): (508) 622-3250

STOPS AND CHANCES OF FURTHER RAINFALL FALL BELOW 50 PERCENT

2. THE NWS ISSUES A "FLOOD WATCH" FOR HARTFORD COUNTY.

RESTORE REQUIRED SEDIMENT AND EROSION CONTROLS.

SIMSBURY ENGINEERING DEPARTMENT: SIMSBURY FIRE DEPARTMENT:

SIMSBURY POLICE DEPARTMENT:

REVIEWING THE PLAN TO ENSURE COMPLIANCE WITH ALL REQUIREMENTS SPECIFIED THEREIN.

THAT SHALL BE TYPE 8 OR 9 REFLECTIVE SHEETING

REMOVAL OF PAVEMENT MARKINGS ALONG STATE ROADWAYS SHALL BE COMPLETED BY A NON-DESTRUCTIVE METHOD IN COMPLIANCE WITH THE STATE OF CONNECTICUT DEPARTMENT OF TRANSPORTATION STANDARD FOR ROAD, BRIDGES, AND

NEW PAVEMENTS MARKINGS SHALL BE PAINTED WITH EPOXY RESIN PAINT IN COMPLIANCE WITH THE STATE OF CONNECTICUT DEPARTMENT OF TRANSPORTATION STANDARD SPECIFICATIONS FOR ROADS, BRIDGES, AND INCIDENTAL CONSTRUCTION FORM

NEW SIGN MATERIAL AND SHEETING SHALL BE MADE OF REFLECTIVE MATERIAL IN COMPLIANCE WITH STATE OF CONNECTICUT DEPARTMENT OF TRANSPORTATION STANDARD SPECIFICATIONS FOR ROADS, BRIDGES, AND INCIDENTAL CONSTRUCTION FORM 818 SECTION 12.08 AS REVISED. TYPE 1 REFLECTIVE SHEETING SHALL BE USED FOR SIGNS WITH WHITE BACKGROUND, TYPE 3 REFLECTIVE SHEETING SHALL BE USED FOR SIGNS WITH RED BACKGROUND

ALL SIGNS AND PAVEMENT MARKINGS INSTALLED ALONG THE STATE ROAD MUST CONFORM TO THE "MANUAL ON UNIFORM TRAFFIC CONTROL DEVICES," THE LATEST STATE OF CONNECTICUT CATALOG OF SIGNS AND STANDARD AS REVISED.

THE PERMITTED SITE WILL BE REPLACED BY THE CONTRACTOR AS DIRECTED BY THE DISTRICT PERMIT SECTION AT NO COST

TRANSPORTATION STANDARD SPECIFICATIONS FOR ROADS, BRIDGES AND INCIDENTAL CONSTRUCTION FORM 818 WITH THE

THIS FLOOD CONTINGENCY PLAN IS INTENDED TO ADDRESS RESPONSE PROCEDURES FOR FLOOD EVENTS OCCURRING DURING CONSTRUCTION. THIS PLAN WILL BE INCLUDED IN THE CONTRACT DOCUMENTS, AND THE CONTRACTOR IS RESPONSIBLE FOR

THE PROJECT SITE IS SUBJECT TO FLOODING. THE CONTRACTOR SHALL MONITOR WEATHER REPORTS AND BE PREPARED TO STOP WORK AND STABILIZE THE SITE IF MORE THAN 1 INCH OF RAINFALL IS PREDICTED BY THE NATIONAL WEATHER SERVICE (NWS) WITH A 70 PERCENT OR GREATER CHANCE OF PRECIPITATION WITHIN 72 HOURS. WORK SHALL BE HALTED UNTIL PRECIPITATION

A QUALIFIED INSPECTOR WILL OVERSEE THE CONSTRUCTION ACTIVITIES AND WILL BE RESPONSIBLE TO NOTIFY THE CONTRACTOR TO EXECUTE THE EMERGENCY MEASURES OUTLINED. THE INSPECTOR WILL DECLARE "EMERGENCY CONDITIONS" UNDER THE

1. THE NWS PREDICTS A HURRICANE OR OTHER SEVERE STORM EVENT SUCH AS RAINFALL IN EXCESS OF 3 INCHES PER 24-HOUR

IMMEDIATELY FOLLOWING DECLARATION OF EMERGENCY CONDITIONS, THE INSPECTOR WILL NOTIFY THE CONTRACTOR, AND THE CONTRACTOR SHALL REMOVE ALL CONSTRUCTION EQUIPMENT, MATERIALS, AND ANY FUEL OIL, GASOLINE, OR OTHER HAZARDOUS MATERIAL BEING TEMPORARILY STORED IN THE WORK AREA TO AN EQUIPMENT STAGING AREA LOCATED OUTSIDE THE BOUNDARY OF THE 1-PERCENT-ANNUAL-CHANCE FLOOD. EVERY EFFORT WILL BE MADE TO RELOCATE ALL EQUIPMENT AND MATERIALS FROM

1-PERCENT-ANNUAL-CHANCE FLOODPLAIN OR WITHIN 100 FEET OF A WETLAND OR WATERCOURSE AT ANY TIME REGARDLESS OF

DISTURBED AREAS WILL BE STABILIZED AS NECESSARY TO RESIST EROSION DURING FLOOD FLOWS. CONSTRUCTION ACTIVITIES WILL RESUME ONLY WHEN WATER SURFACE ELEVATIONS RECEDE TO A LEVEL THAT ALLOWS SAFE ACCESS FOR THE CONTRACTOR TO

AT THE CONCLUSION OF THE PROJECT, LONG TERM TRAIL MAINTENANCE WILL BE THE RESPONSIBILITY OF THE TOWN OF SIMSBURY. SIGNS INDICATING THAT THE TRAIL IS SUBJECT TO FLOODING WILL BE POSTED ALONG THE TRAIL. THE TRAIL WILL BE CLOSED BY

THE FLOODPLAIN. FUEL OIL, GASOLINE, OR OTHER HAZARDOUS MATERIALS ARE NOT TO BE STORED WITHIN THE


EMERGENCY CONTACT INFORMATION - THE FOLLOWING IS A PARTIAL LIST OF EMERGENCY TELEPOHONE NUMBERS:

(860) 658-1973

(860) 658-3100

- 7. ALL DIMENSIONS AND ELEVATIONS SHALL BE VERIFIED IN THE FIELD PRIOR TO CONSTRUCTION. ANY DISCREPANCIES SHALL BE BROUGHT TO THE ATTENTION OF THE ENGINEER.
- 8. SEDIMENT AND EROSION CONTROL MEASURES AS DEPICTED ON THESE PLANS AND DESCRIBED WITHIN THE SEDIMENT AND EROSION CONTROL NARRATIVE SHALL BE IMPLEMENTED AND MAINTAINED UNTIL PERMANENT COVER AND STABILIZATION IS ESTABLISHED. ALL SEDIMENT AND EROSION CONTROL MEASURES SHALL CONFORM TO THE "GUIDELINES FOR SOIL EROSION AND SEDIMENT CONTROL, CONNECTICUT - 2002, AND IN ALL CASES BEST MANAGEMENT PRACTICES SHALL PREVAIL.
- 9. ALL DISTURBED AREAS SHALL RECEIVE A MINIMUM OF 4" TOPSOIL, AND BE SEEDED WITH GRASS OR SODDED, OR AS SHOWN ON THE PLANS.
- 10. ALL PROPOSED CONTOURS AND SPOT ELEVATIONS INDICATE FINISHED GRADE.
- 11. ALL CONSTRUCTION MATERIALS AND METHODS SHALL CONFORM TO THE TOWN OF SIMSBURY REQUIREMENTS AND TO THE APPLICABLE SECTIONS OF THE STATE OF CONNECTICUT DEPARTMENT OF TRANSPORTATION STANDARD SPECIFICATIONS FOR ROADS, BRIDGES, FACILITIES, AND INCIDENTAL CONSTRUCTION, FORM 818 & RELATED SUPPLEMENTS.
- 12. THE PLANS REQUIRE A CONTRACTOR'S WORKING KNOWLEDGE OF LOCAL, MUNICIPAL, WATER AUTHORITY, AND STATE CODES FOR UTILITY SYSTEMS. ANY CONFLICTS BETWEEN MATERIALS AND LOCATIONS SHOWN, AND LOCAL REQUIREMENTS SHALL BE BROUGHT TO THE ATTENTION OF THE ENGINEER PRIOR TO THE EXECUTION OF WORK. THE ENGINEER WILL NOT BE HELD LIABLE FOR COSTS INCURRED TO IMPLEMENT OR CORRECT WORK WHICH DOES NOT CONFORM TO LOCAL CODE.
- 13. ALL FUEL, OIL, PAINT, OR OTHER HAZARDOUS MATERIALS SHOULD BE STORED IN A SECONDARY CONTAINER AND REMOVED TO A LOCKED INDOOR AREA WITH AN IMPERVIOUS FLOOR DURING
- 14. COMPLIANCE WITH THE PERMIT CONDITIONS IS THE RESPONSIBILITY OF BOTH THE CONTRACTOR AND THE PERMITTEE.
- 15. PERIMETER SWALES AND RESPECTIVE SILTATION BASINS SHALL BE COMPLETED AND RESTORED PRIOR TO PROCEEDING WITH OTHER SITE CONSTRUCTION.ONST
- 16. THE PROPERTY OWNER MUST MAINTAIN (REPAIR/REPLACE WHEN NECESSARY) THE SILTATION CONTROL UNTIL ALL DEVELOPMENT ACTIVITY IS COMPLETED AND ALL DISTURBED AREAS ARE PERMANENTLY

- MUST BE APPRISED OF THE SPECIES DESCRIPTION AND THE POSSIBLE PRESENCE OF A LISTED SPECIES, AND INSTRUCTED TO RELOCATE REPTILES AND AMPHIBIANS FOUND INSIDE WORK AREAS OR NOTIFY THE APPROPRIATE AUTHORITIES TO RELOCATE INDIVIDUALS.
- 6. ANY REPTILES AND AMPHIBIANS ENCOUNTERED WITHIN THE IMMEDIATE WORK AREA SHALL BE CAREFULLY MOVED TO AN ADJACENT AREA OUTSIDE OF THE EXCLUDED AREA AND FENCING SHOULD BE INSPECTED TO IDENTIFY AND REMOVE ACCESS POINT.
- 7. IN AREAS WHERE SILT FENCE IS USED FOR EXCLUSION, IT SHALL BE REMOVED AS SOON AS THE AREA IS STABLE TO ALLOW FOR REPTILE AND AMPHIBIAN PASSAGE TO RESUME.
- 8. NO HEAVY MACHINERY OR VEHICLES MAY BE PARKED IN ANY REPTILE OR AMPHIBIAN
- 9. SPECIAL PRECAUTIONS MUST BE TAKEN TO AVOID DEGRADATION OF WETLAND HABITATS INCLUDING ANY WET MEADOWS AND SEASONAL POOLS.
- 10. THE CONTRACTOR AND CONSULTING HERPETOLOGIST MUST SEARCH THE WORK AREA EACH MORNING PRIOR TO ANY WORK BEING DONE.
- 11. WHEN FELLING TREES ADJACENT TO BROOKS AND STREAMS PLEASE CUT THEM TO FALL AWAY FROM THE WATERWAY AND DO NOT DRAG TREES ACROSS THE WATERWAY OR REMOVE
- 12. AVOID AND LIMIT ANY EQUIPMENT USE WITHIN 50 FEET OF STREAMS AND BROOKS.
- 13. ANY CONFIRMED SIGHTINGS OF NORTHERN LEOPARD FROG, EASTERN HOGNOSE SNAKE, BLUE SPOTTED SALAMANDER, BOX, WOOD OR SPOTTED TURTLES SHOULD BE REPORTED AND DOCUMENTED WITH THE NDDB (NDDBREQUESTDEP@CT.GOV) ON THE APPROPRIATE SPECIAL ANIMAL FORM FOUND AT (HTTP://WWW.CT.GOV/DEEP/CWP/VIEW.ASP?A=2702&Q=323460&DEPNAV_GID=1641)

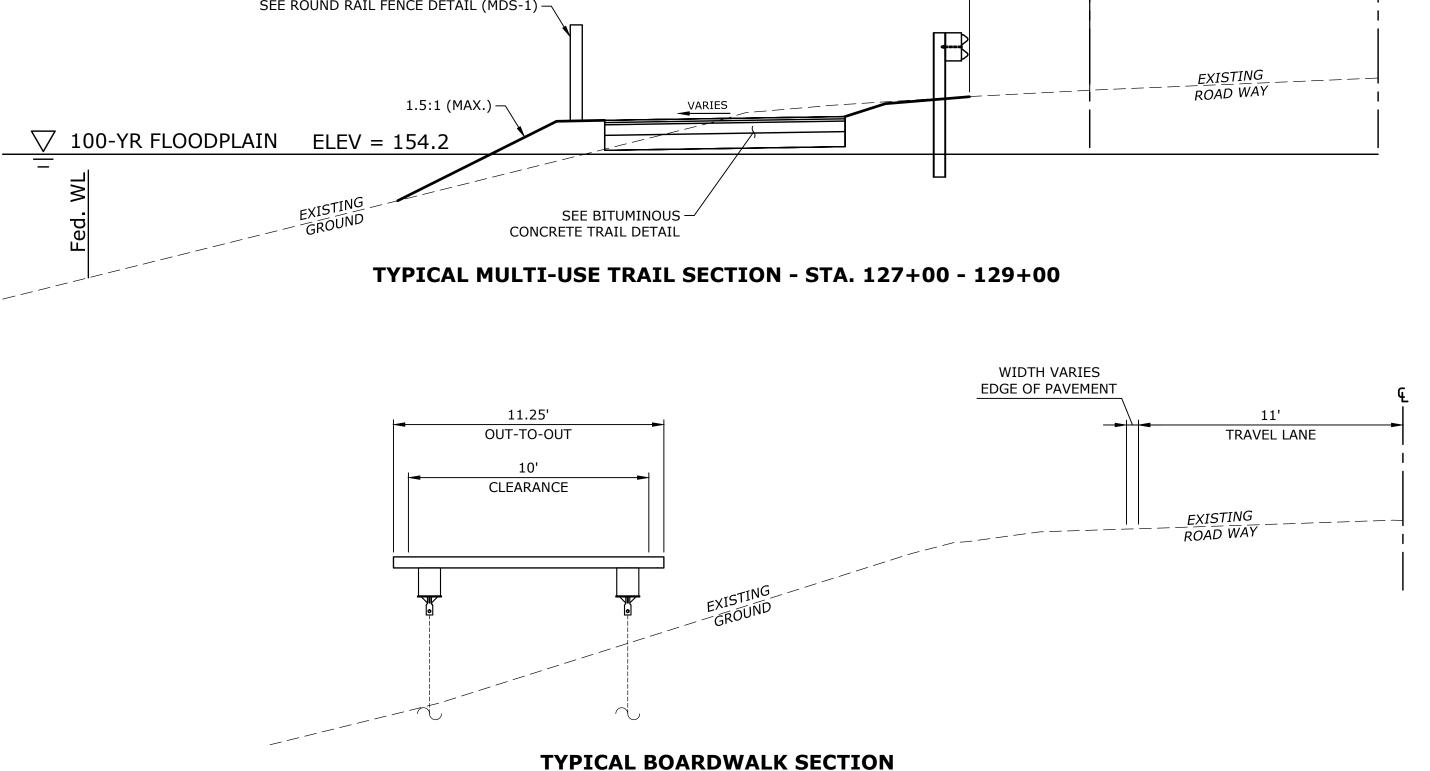


SG


1"=150'


MAY 2022


1613-20


COPYRIGHT, SLR INTERNATIONAL CORPORATION - 202

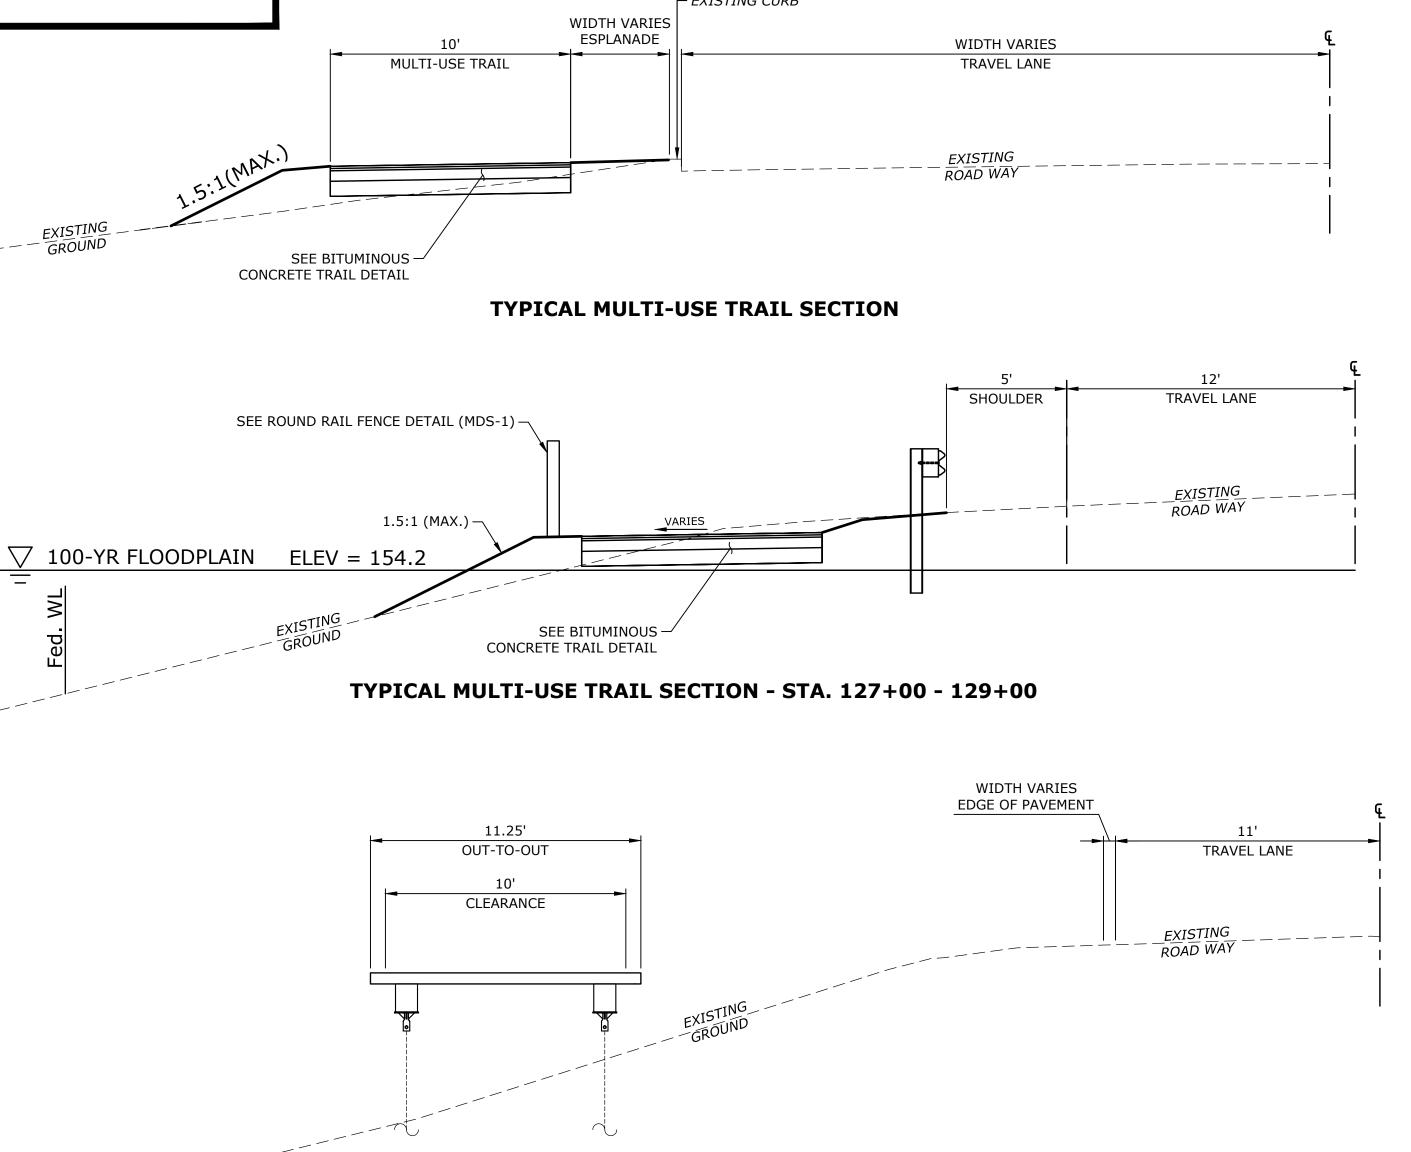


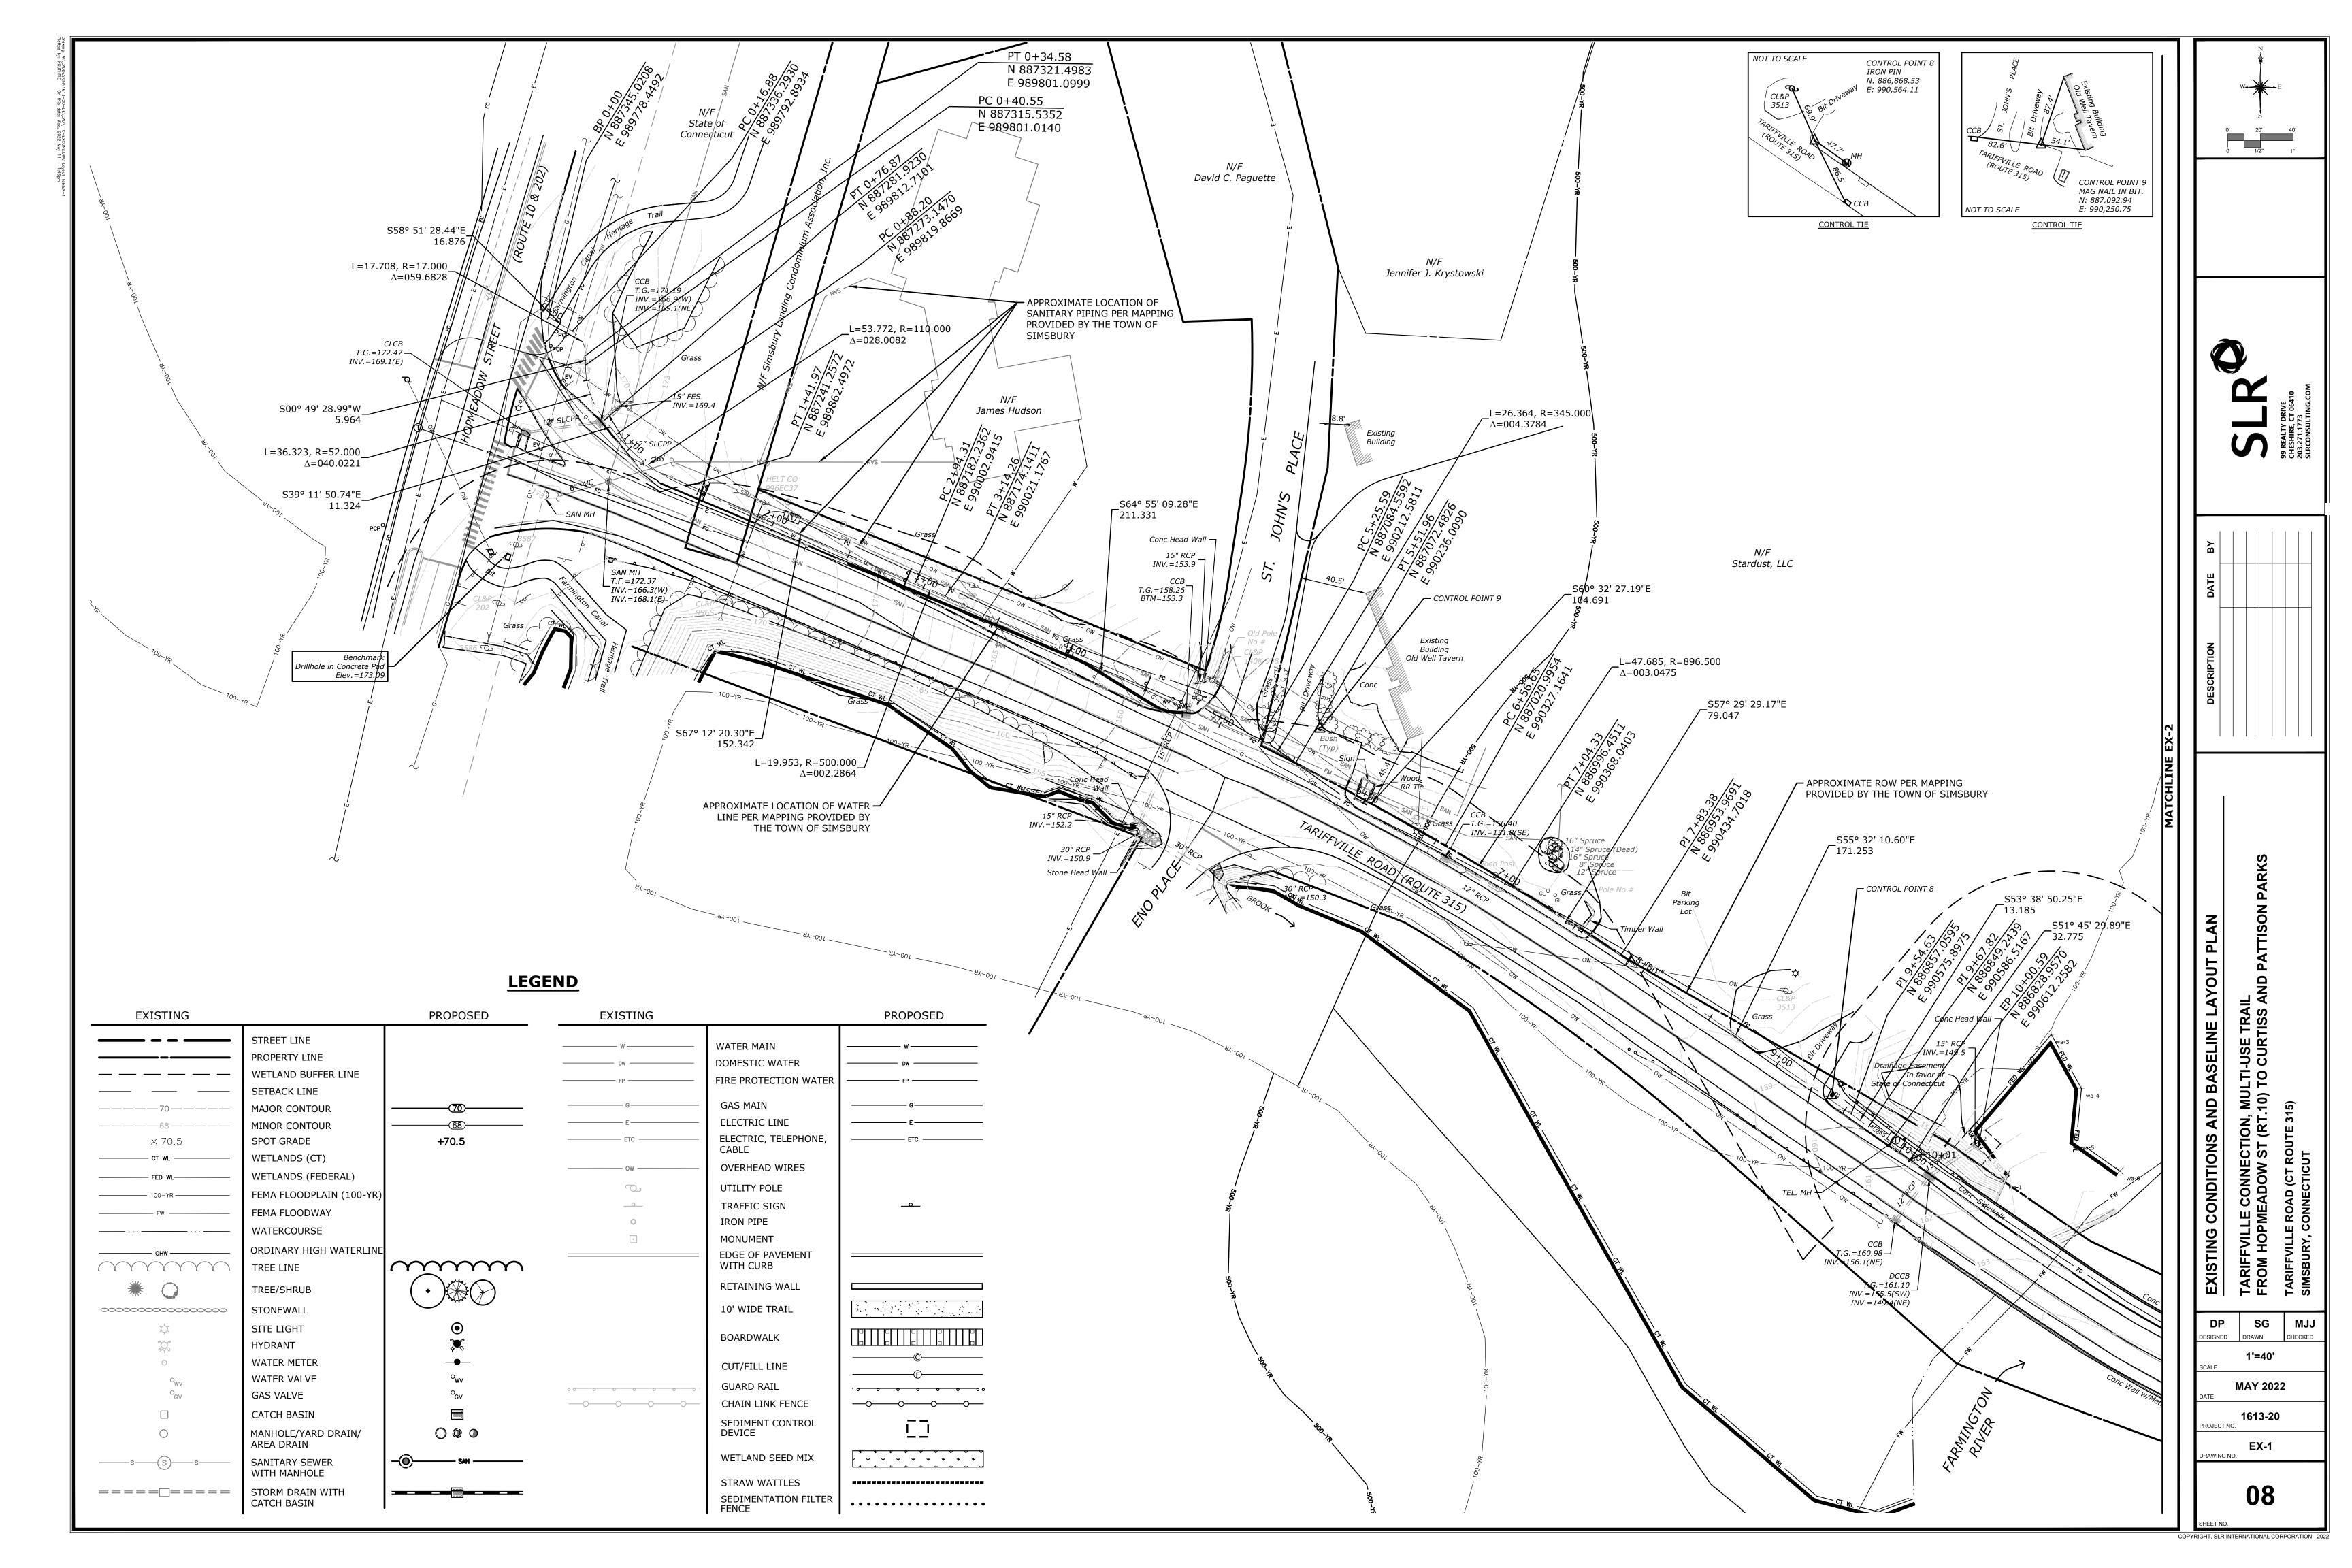


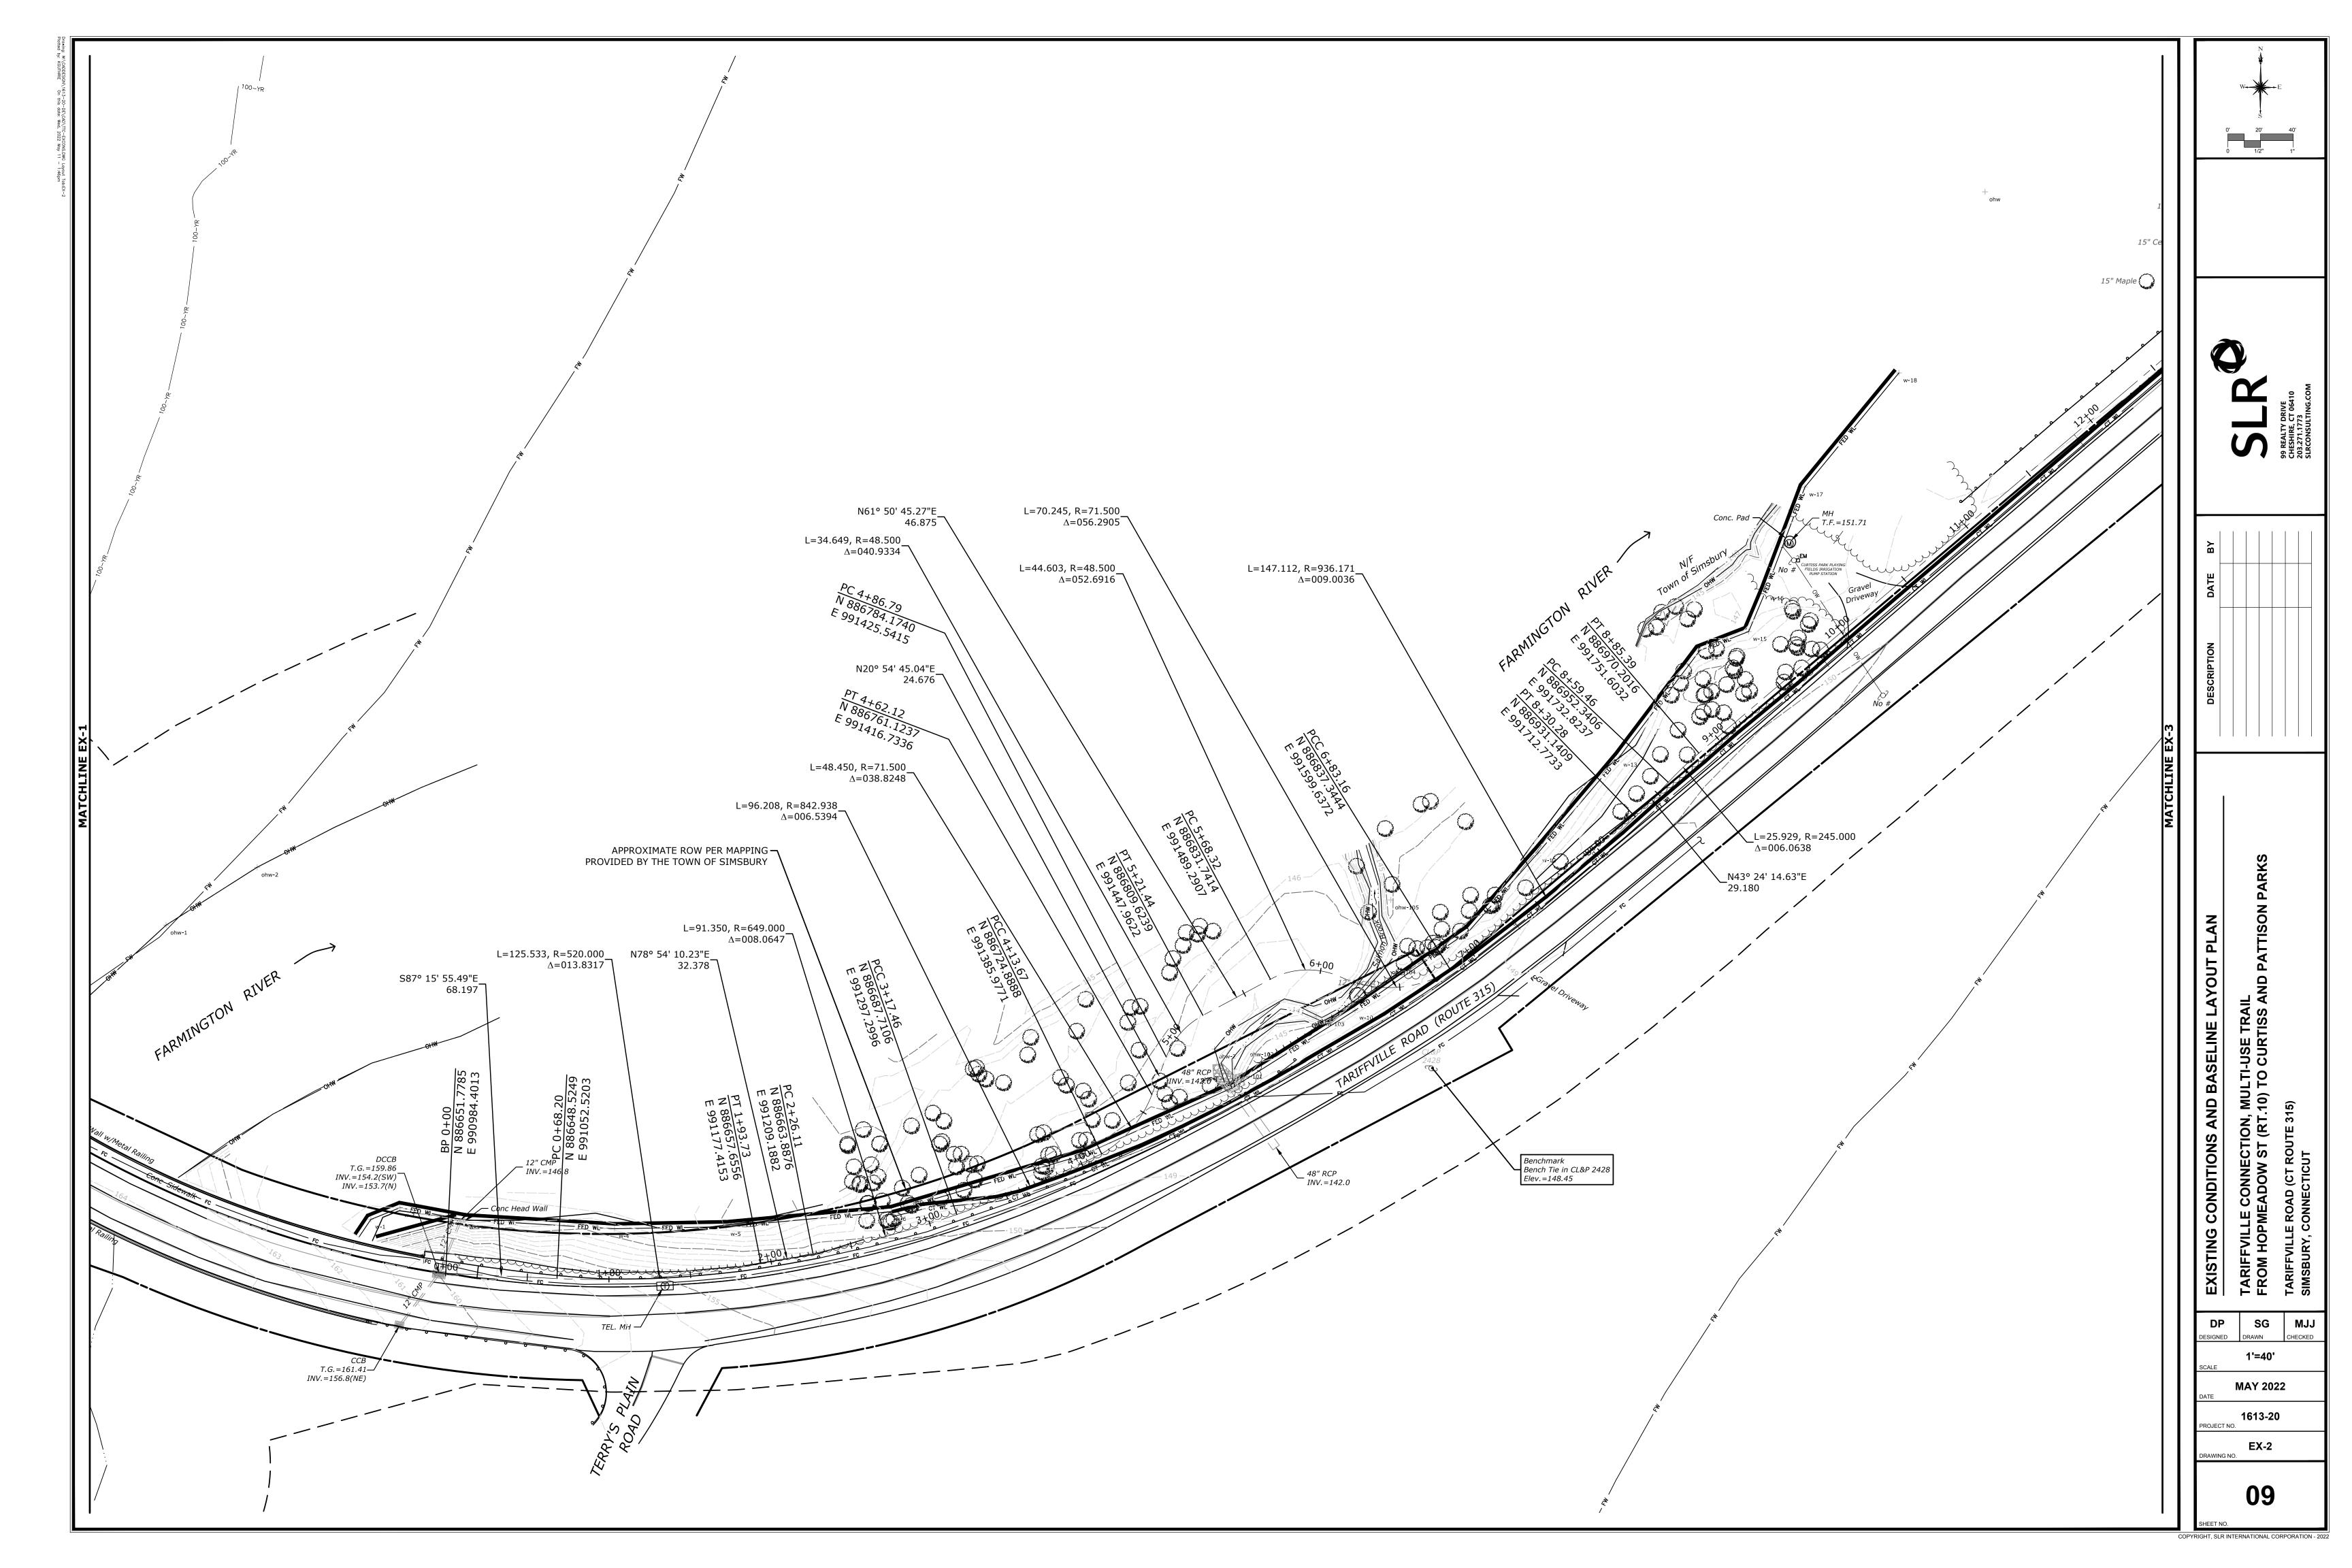


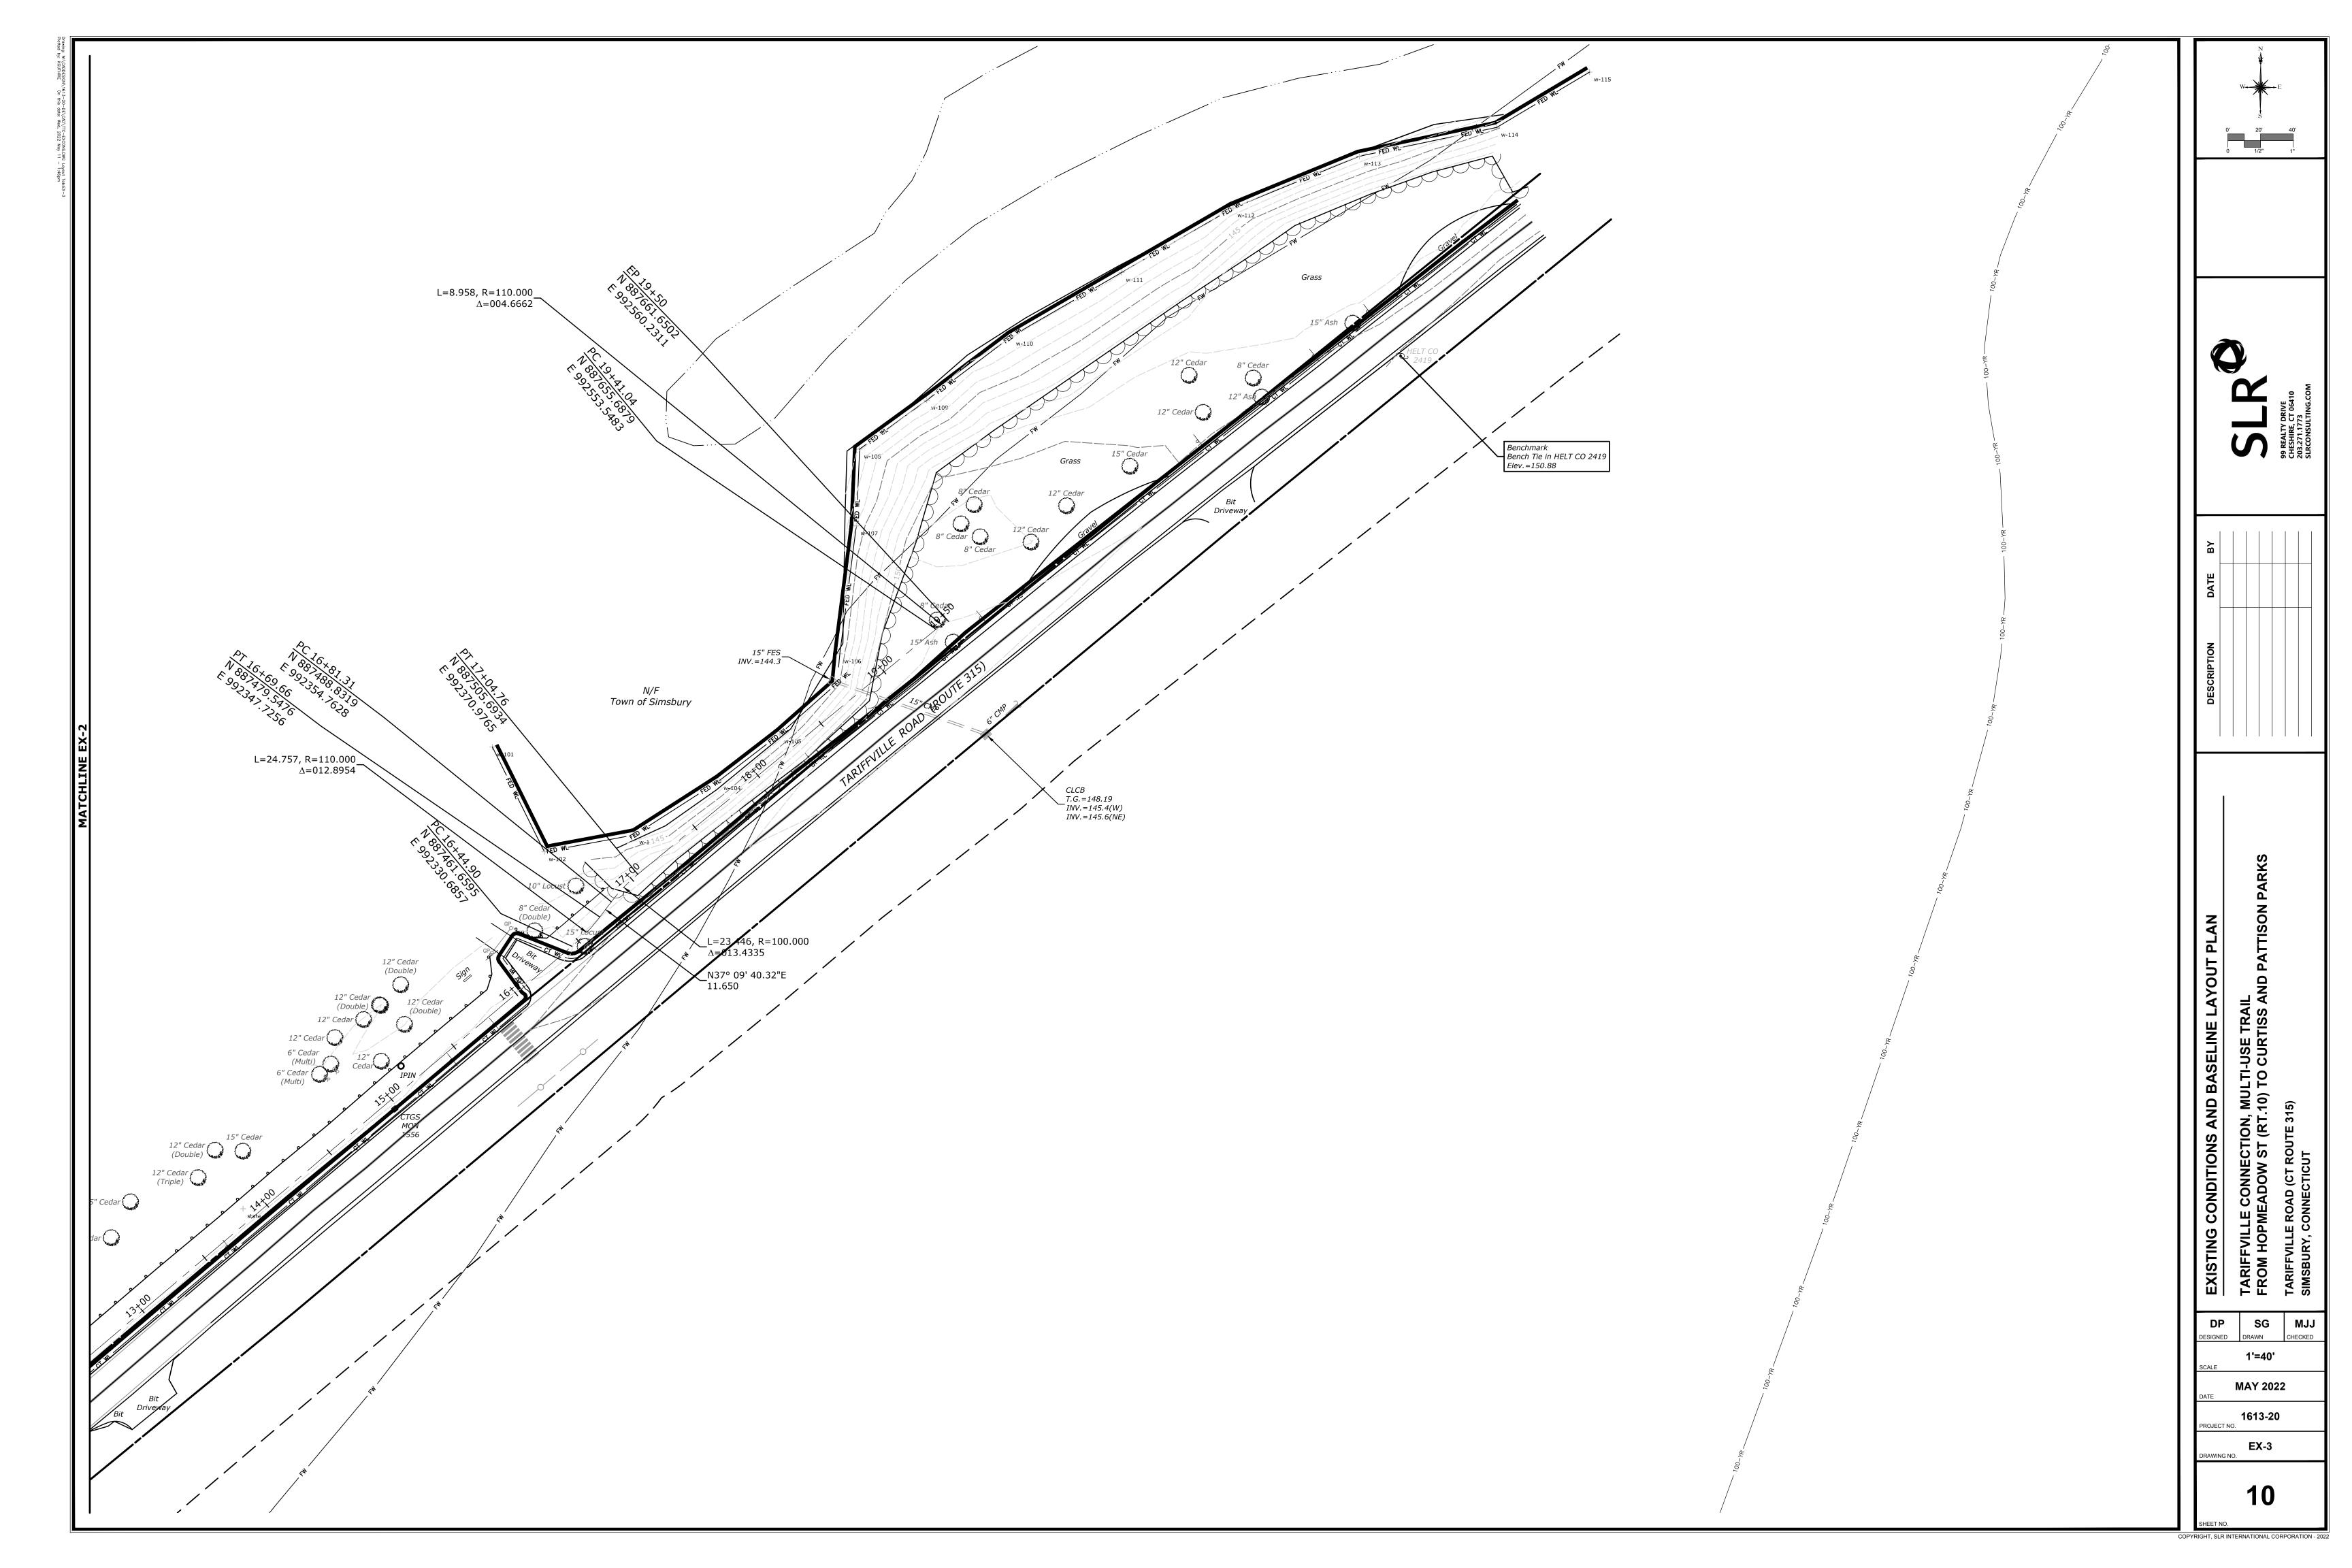


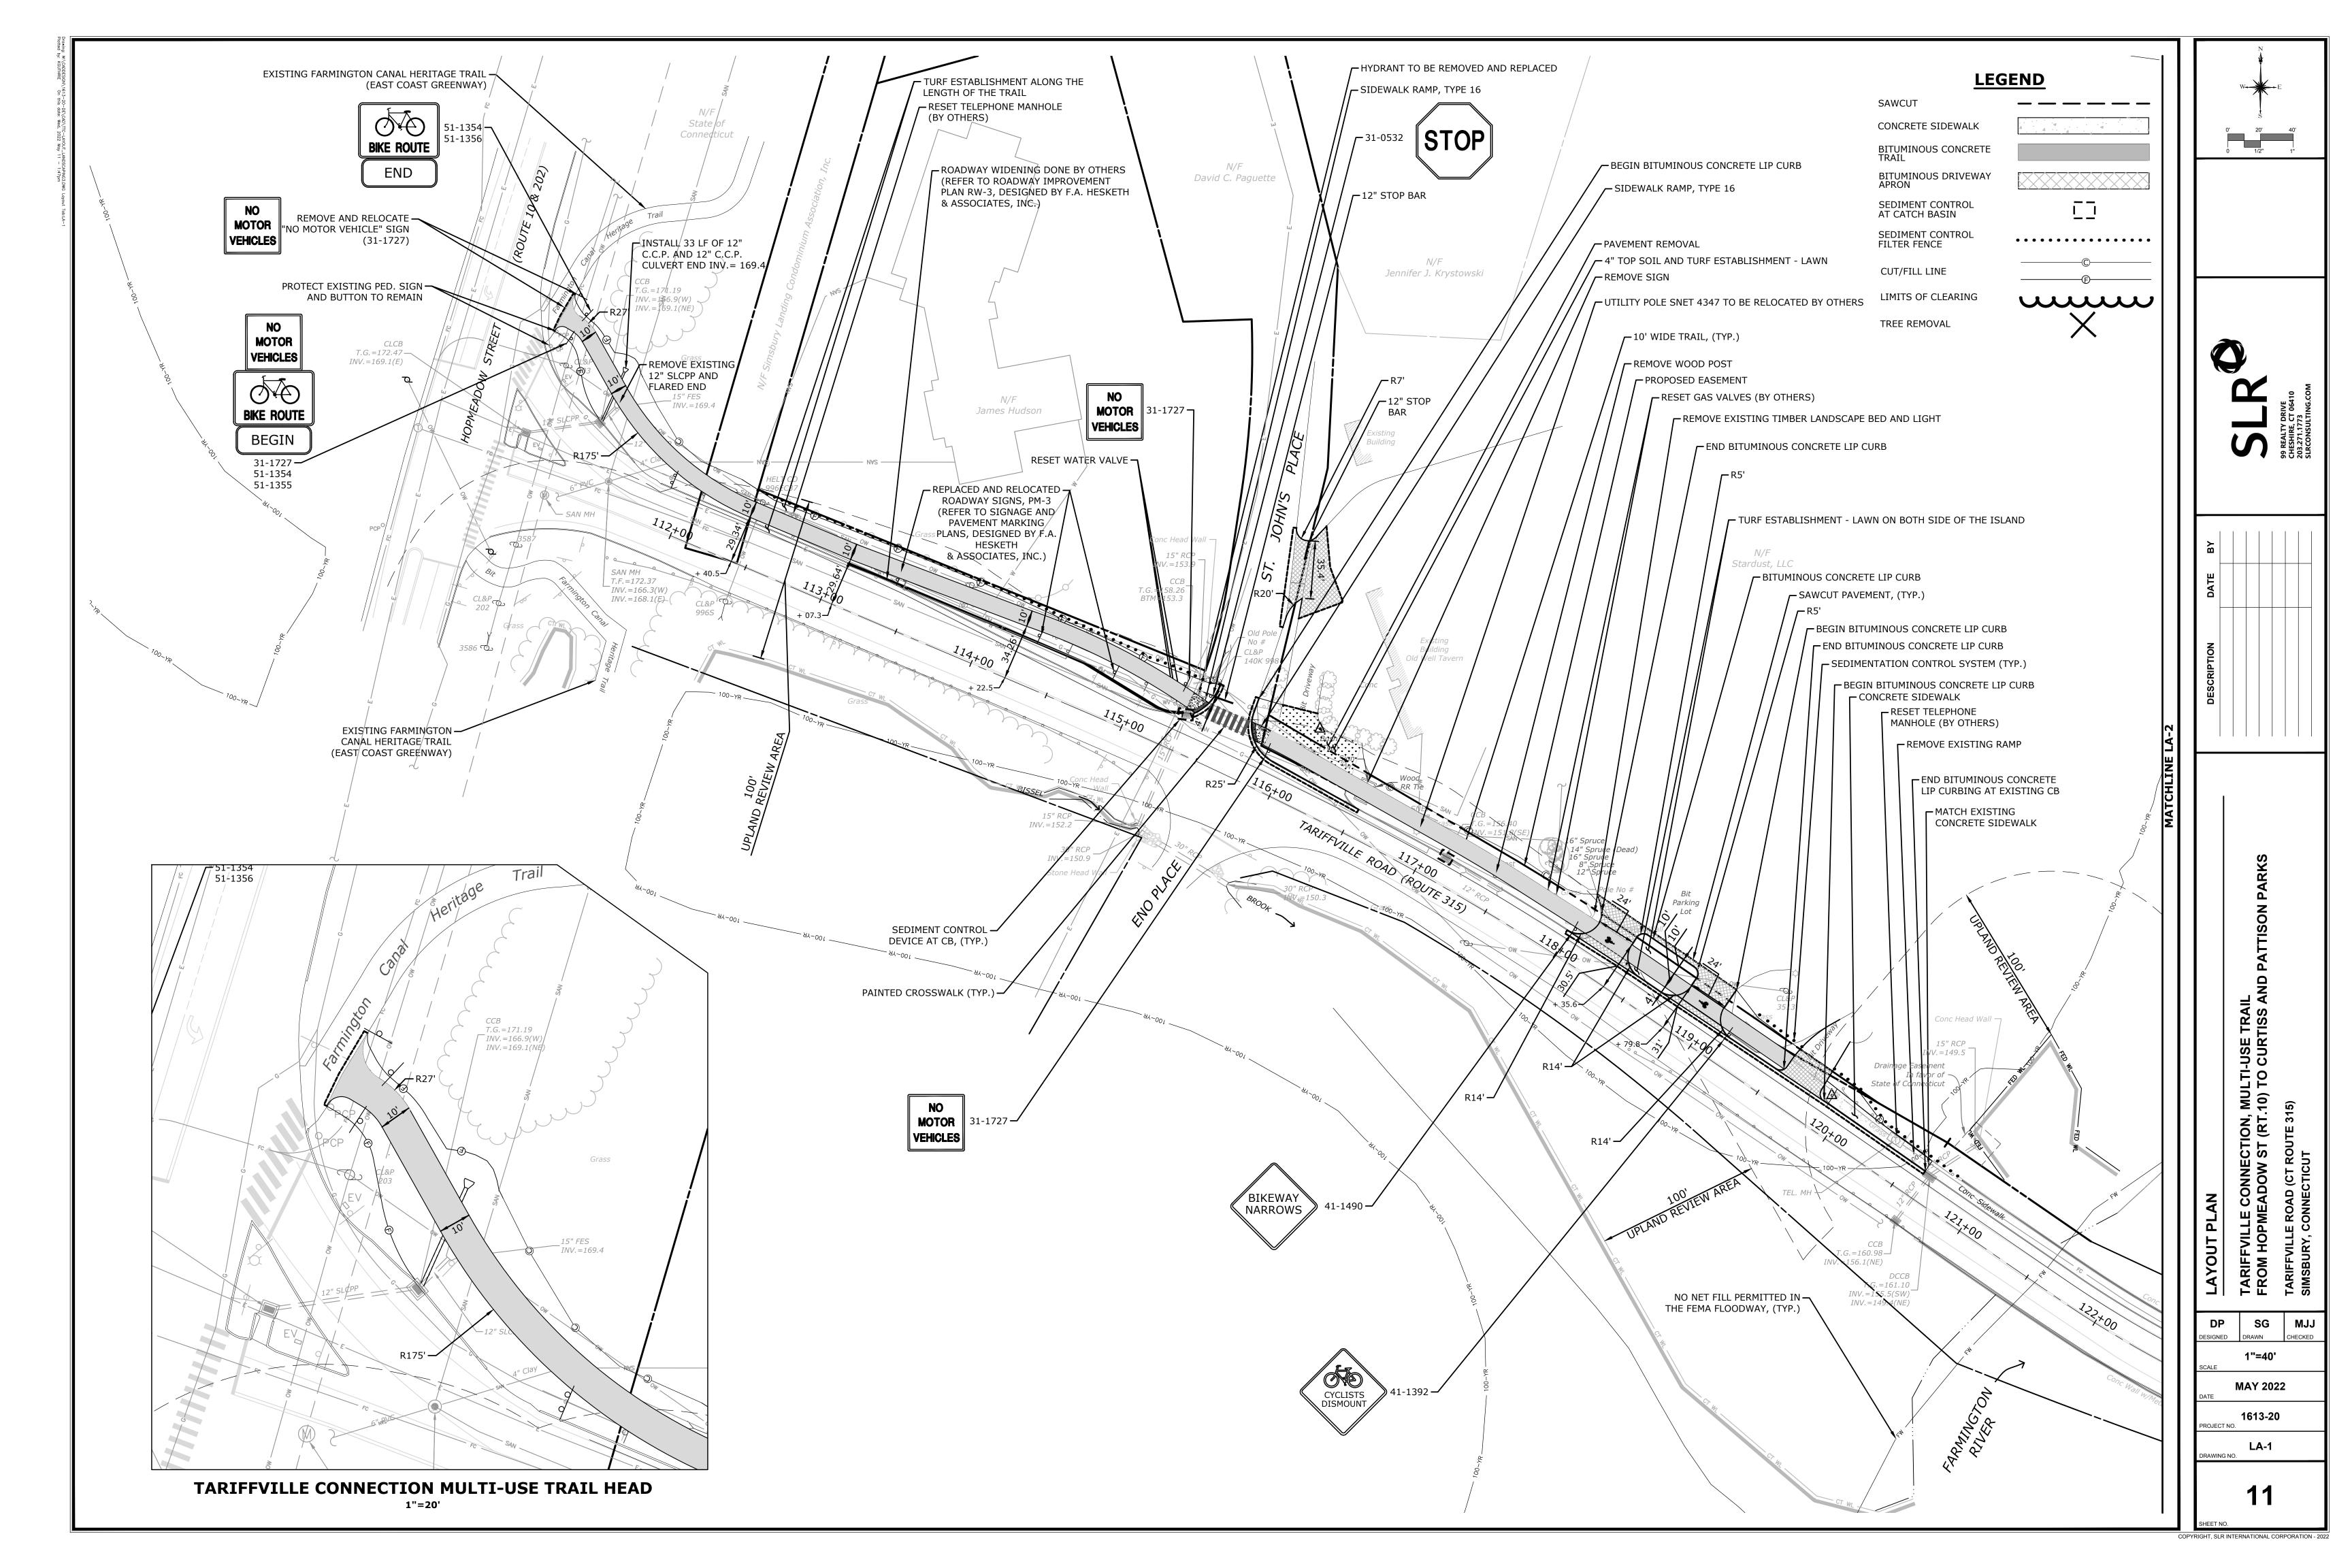


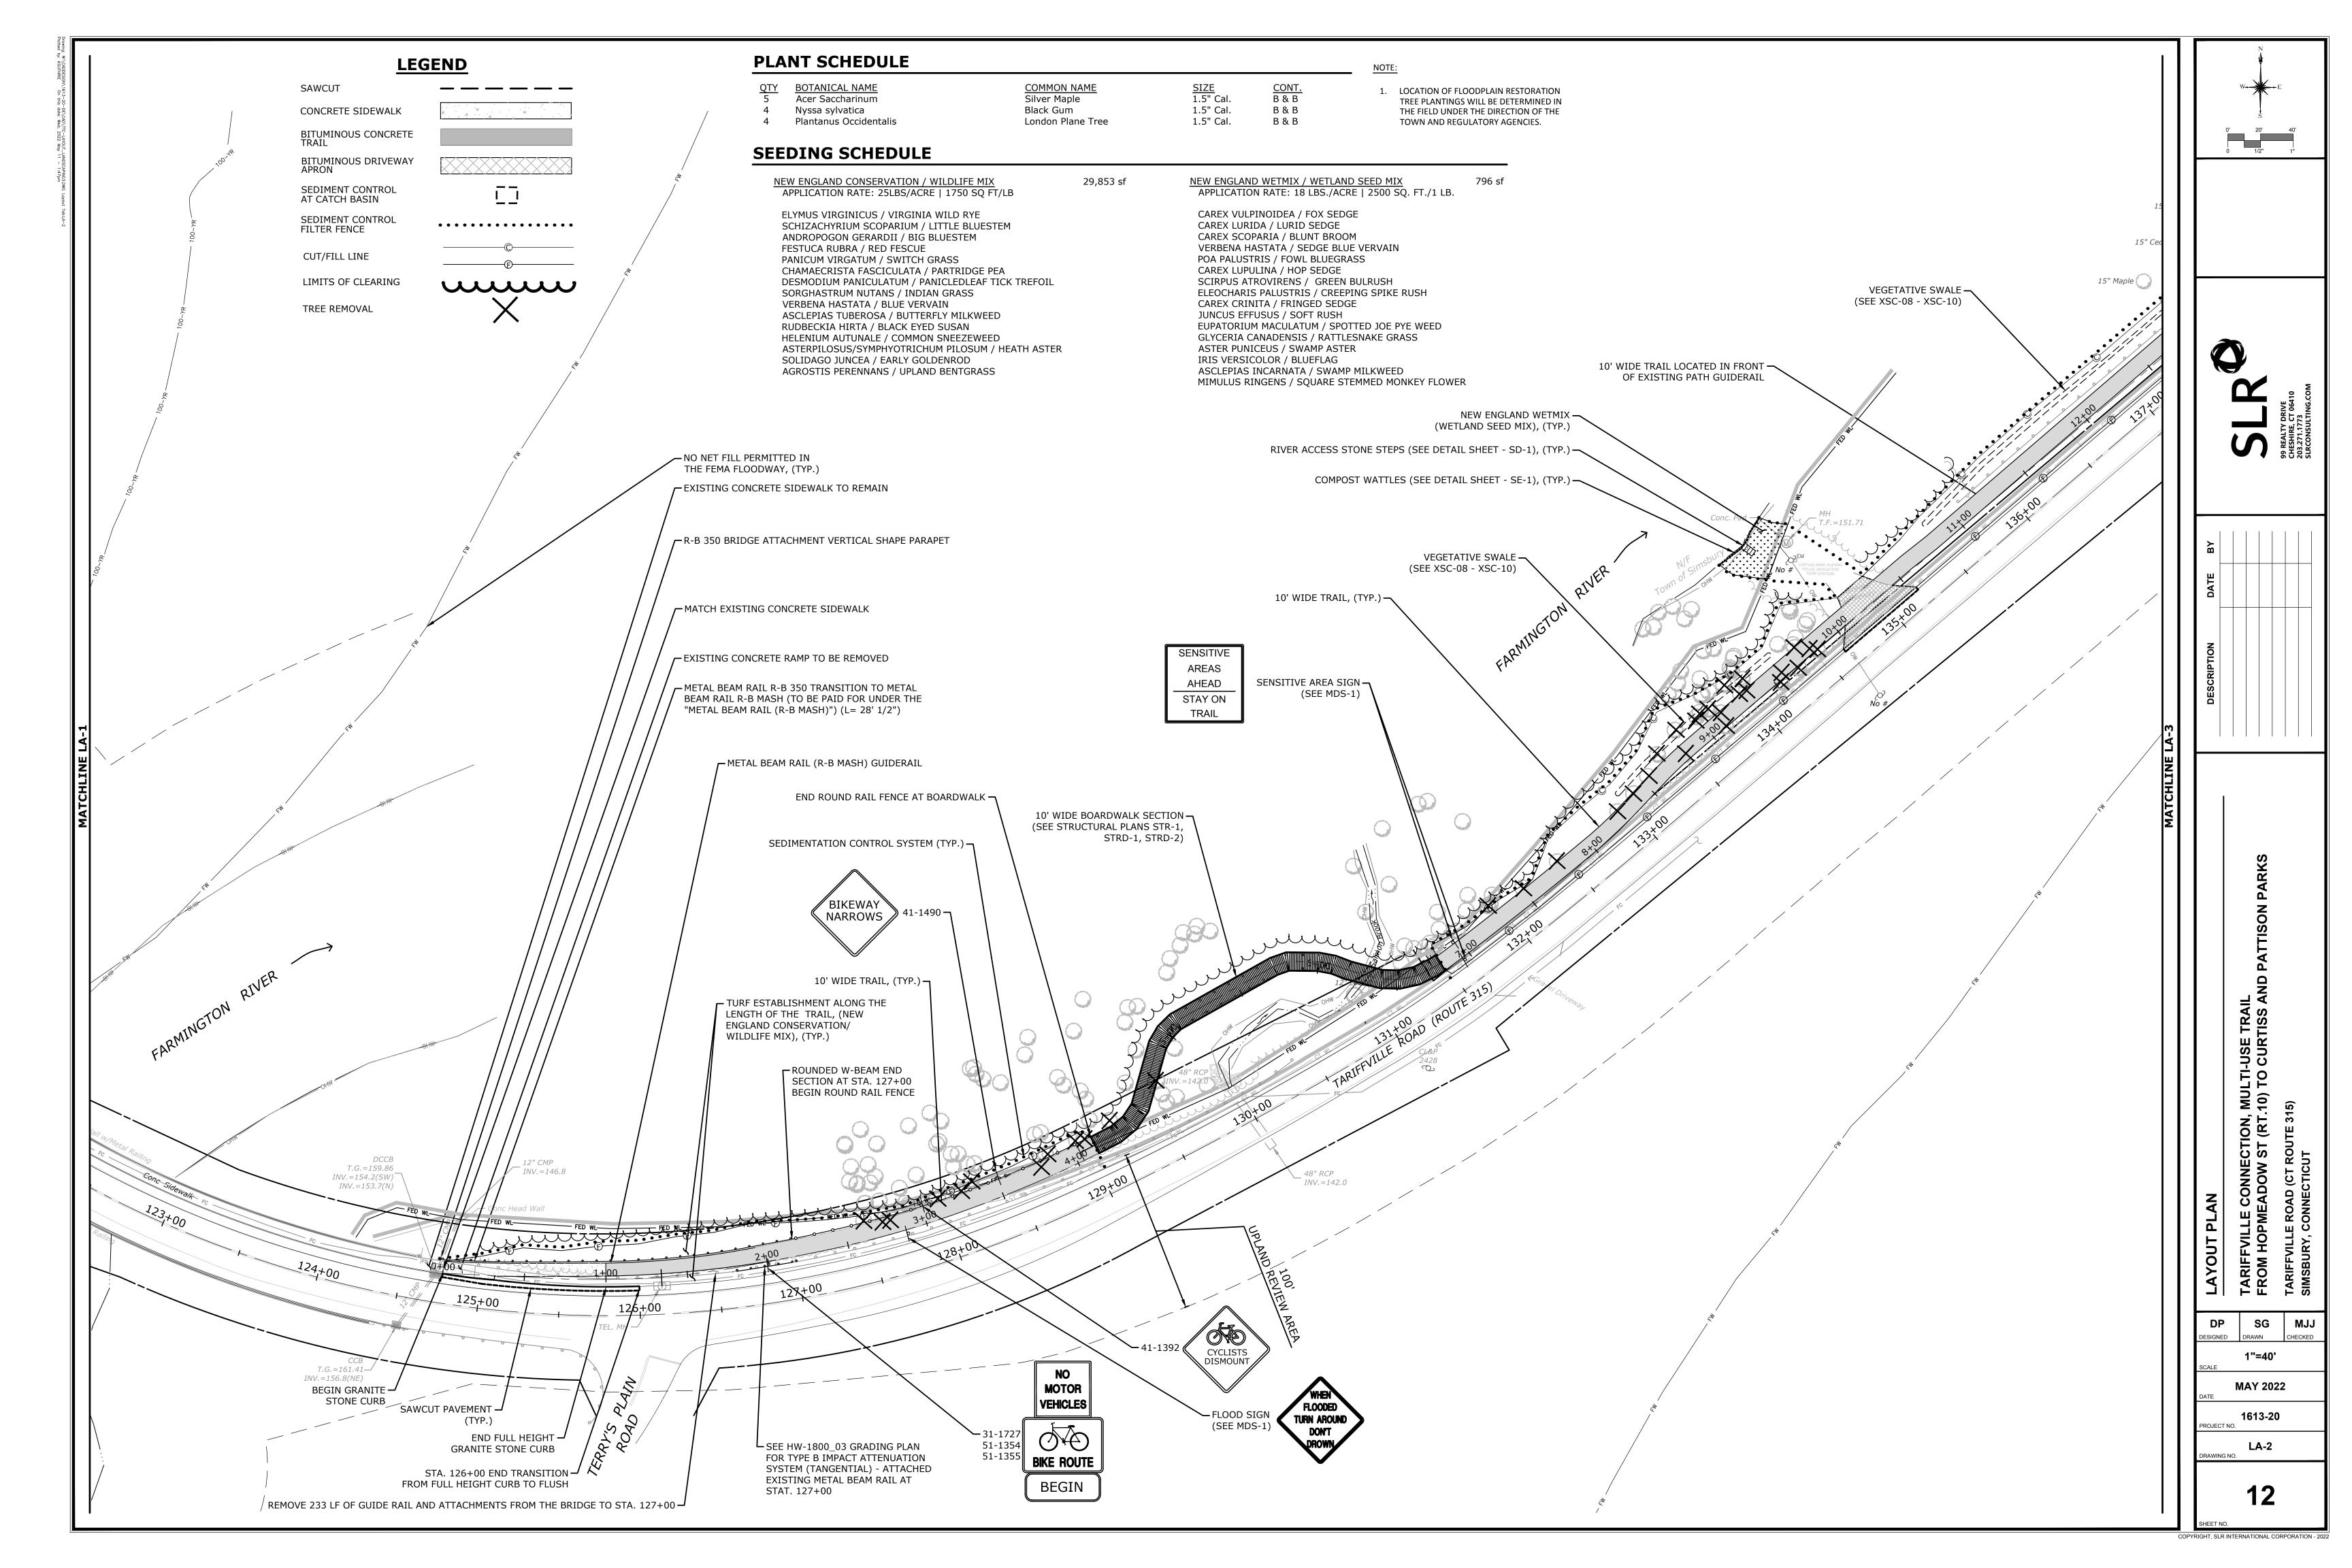


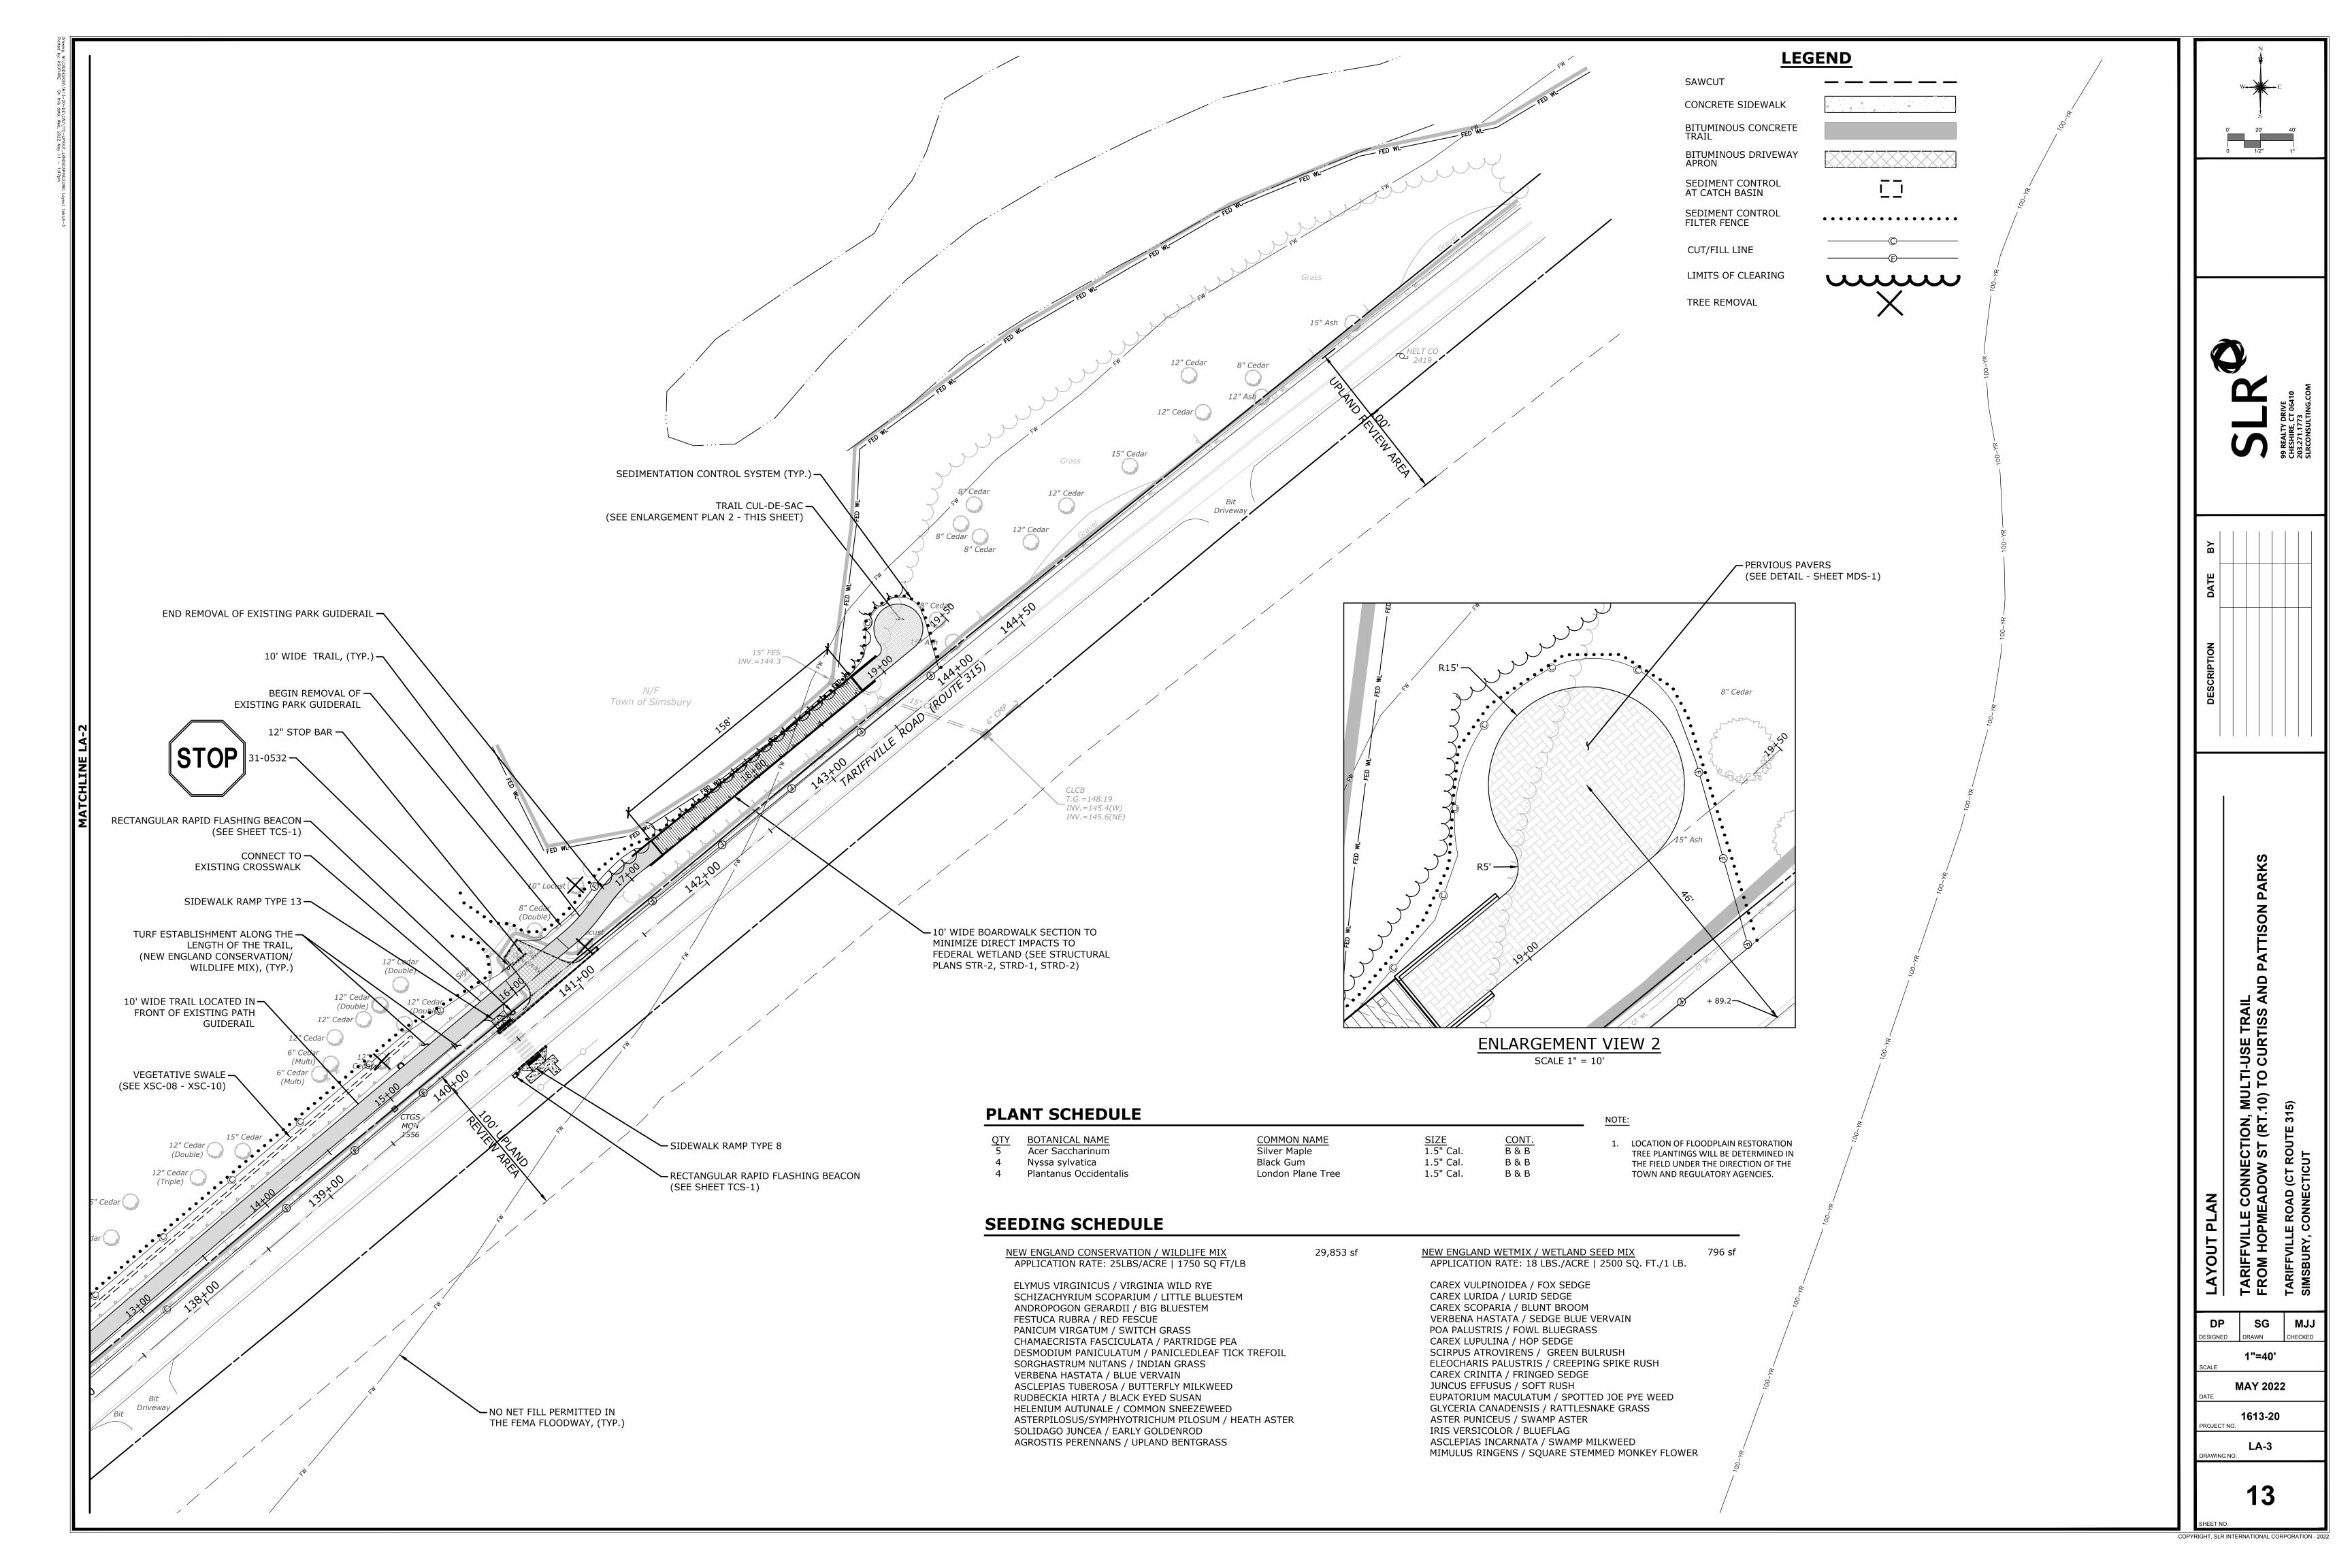


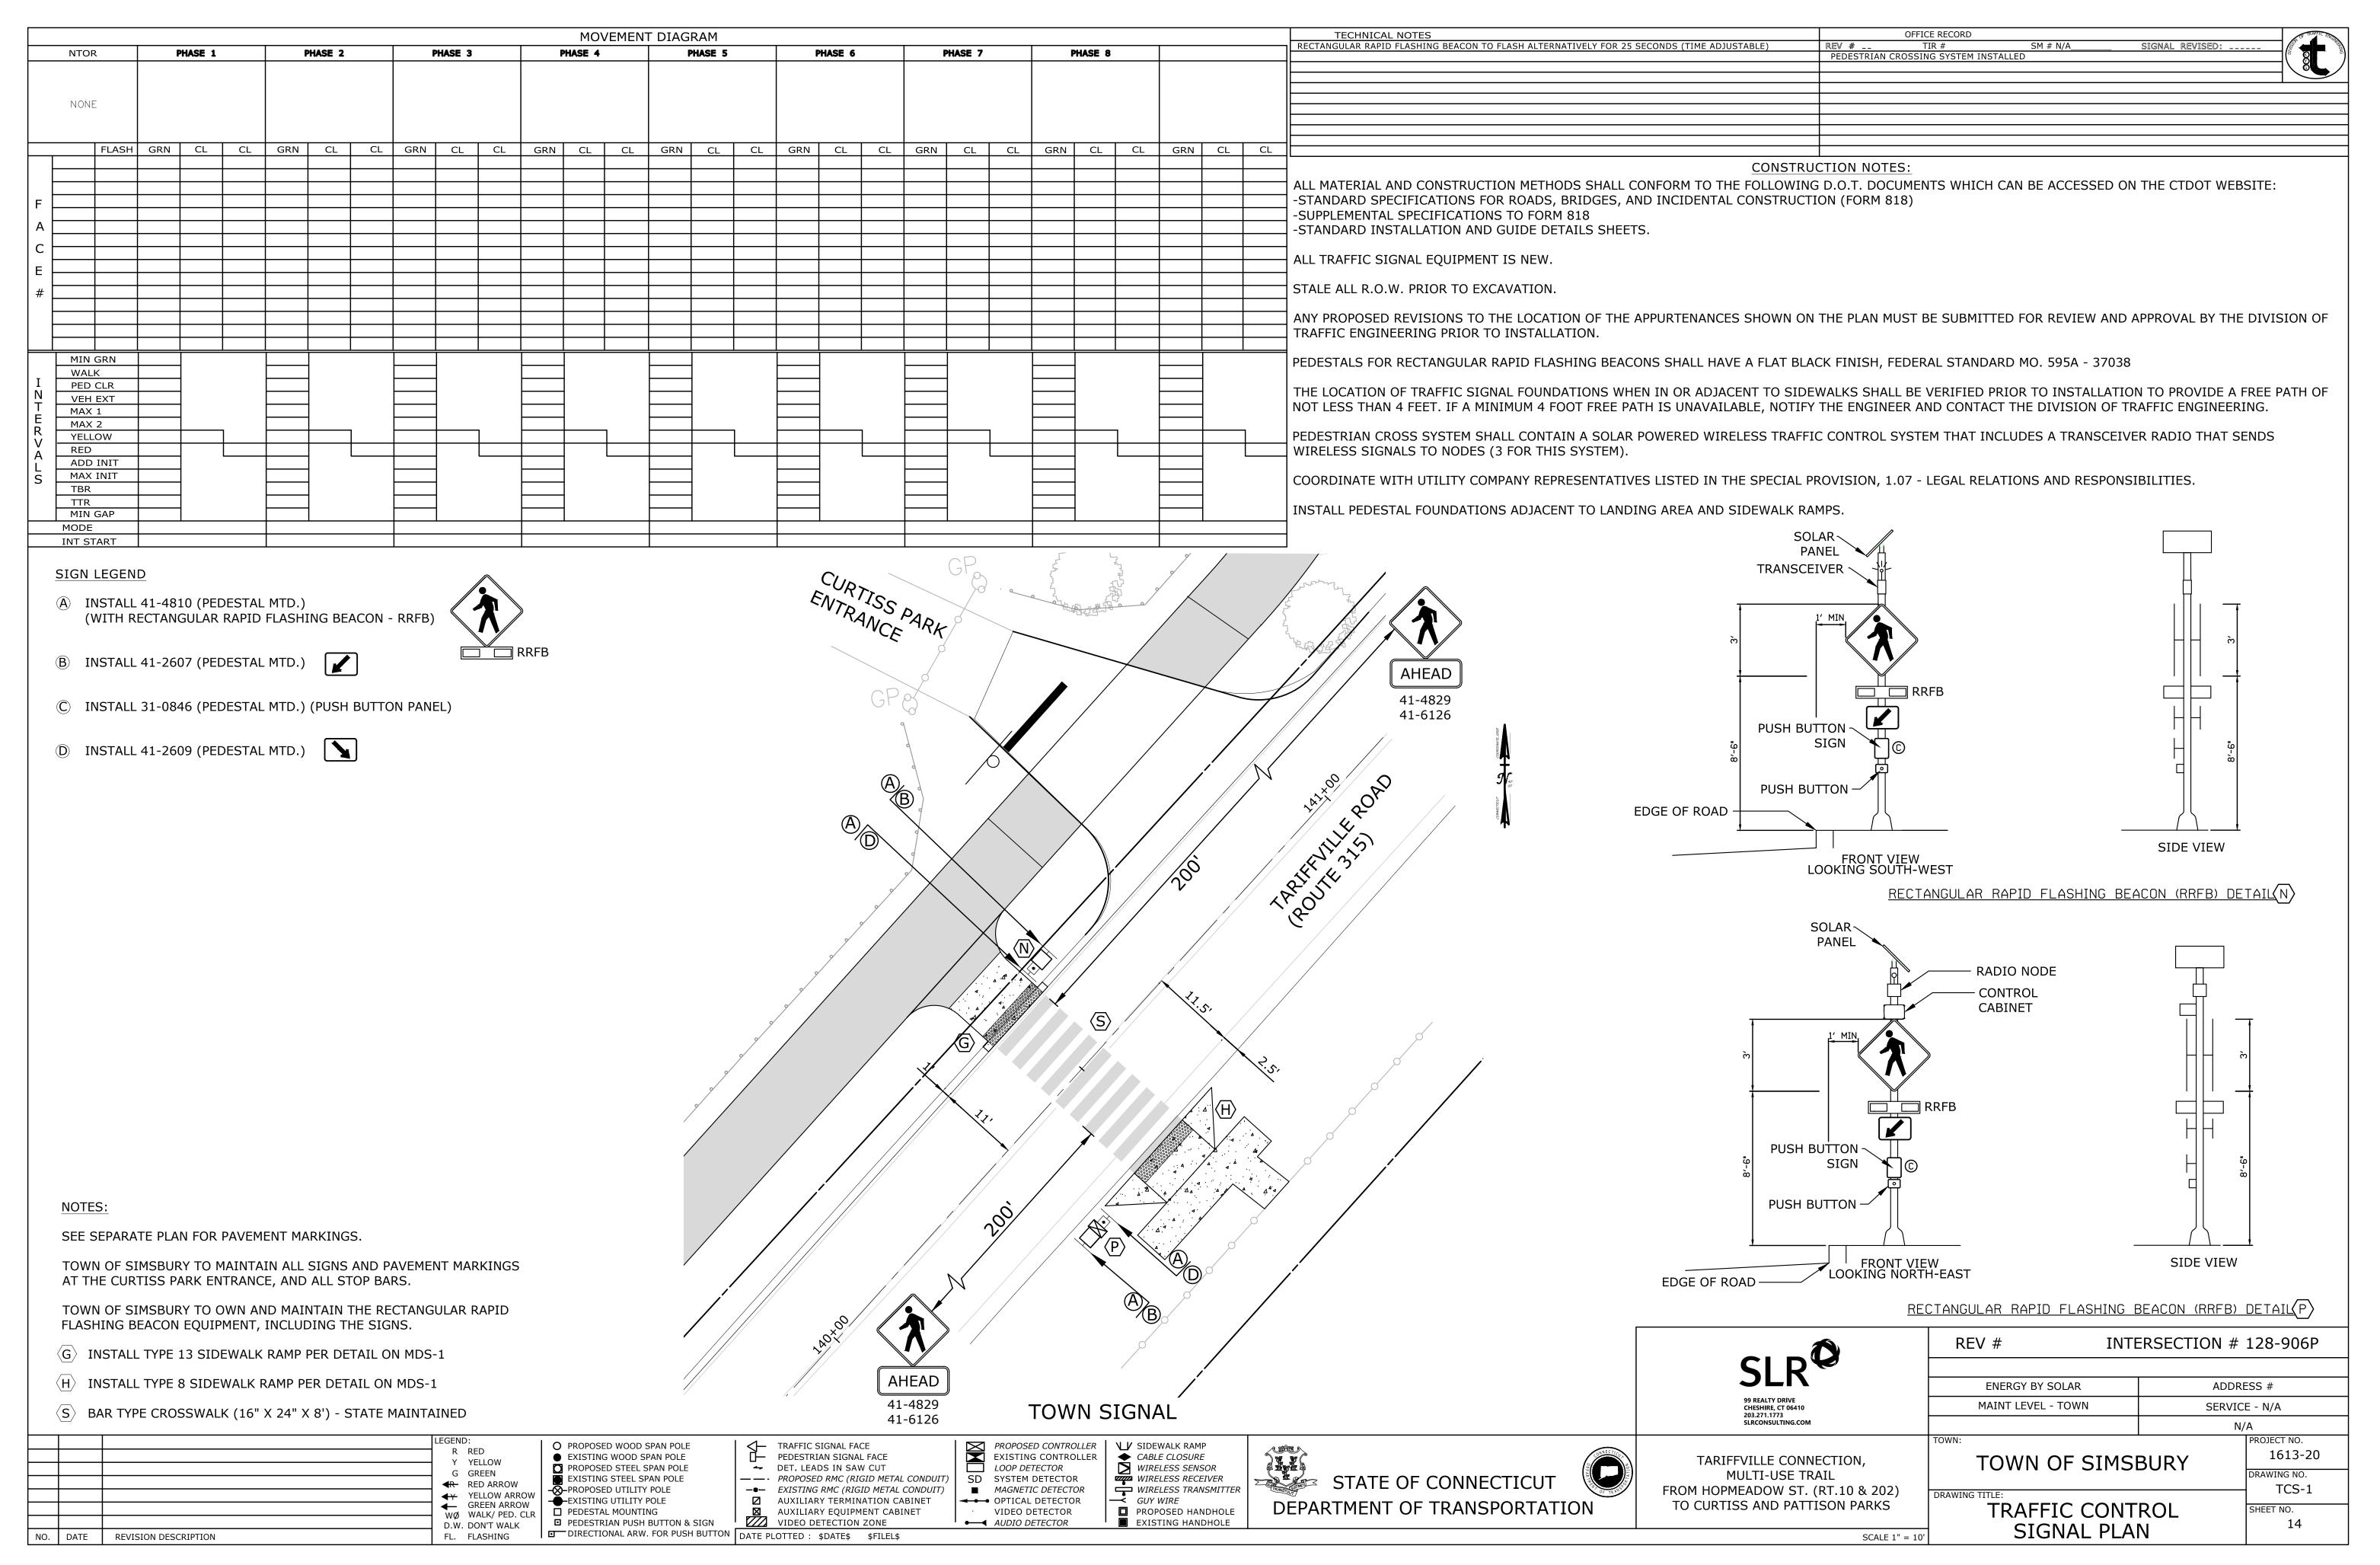


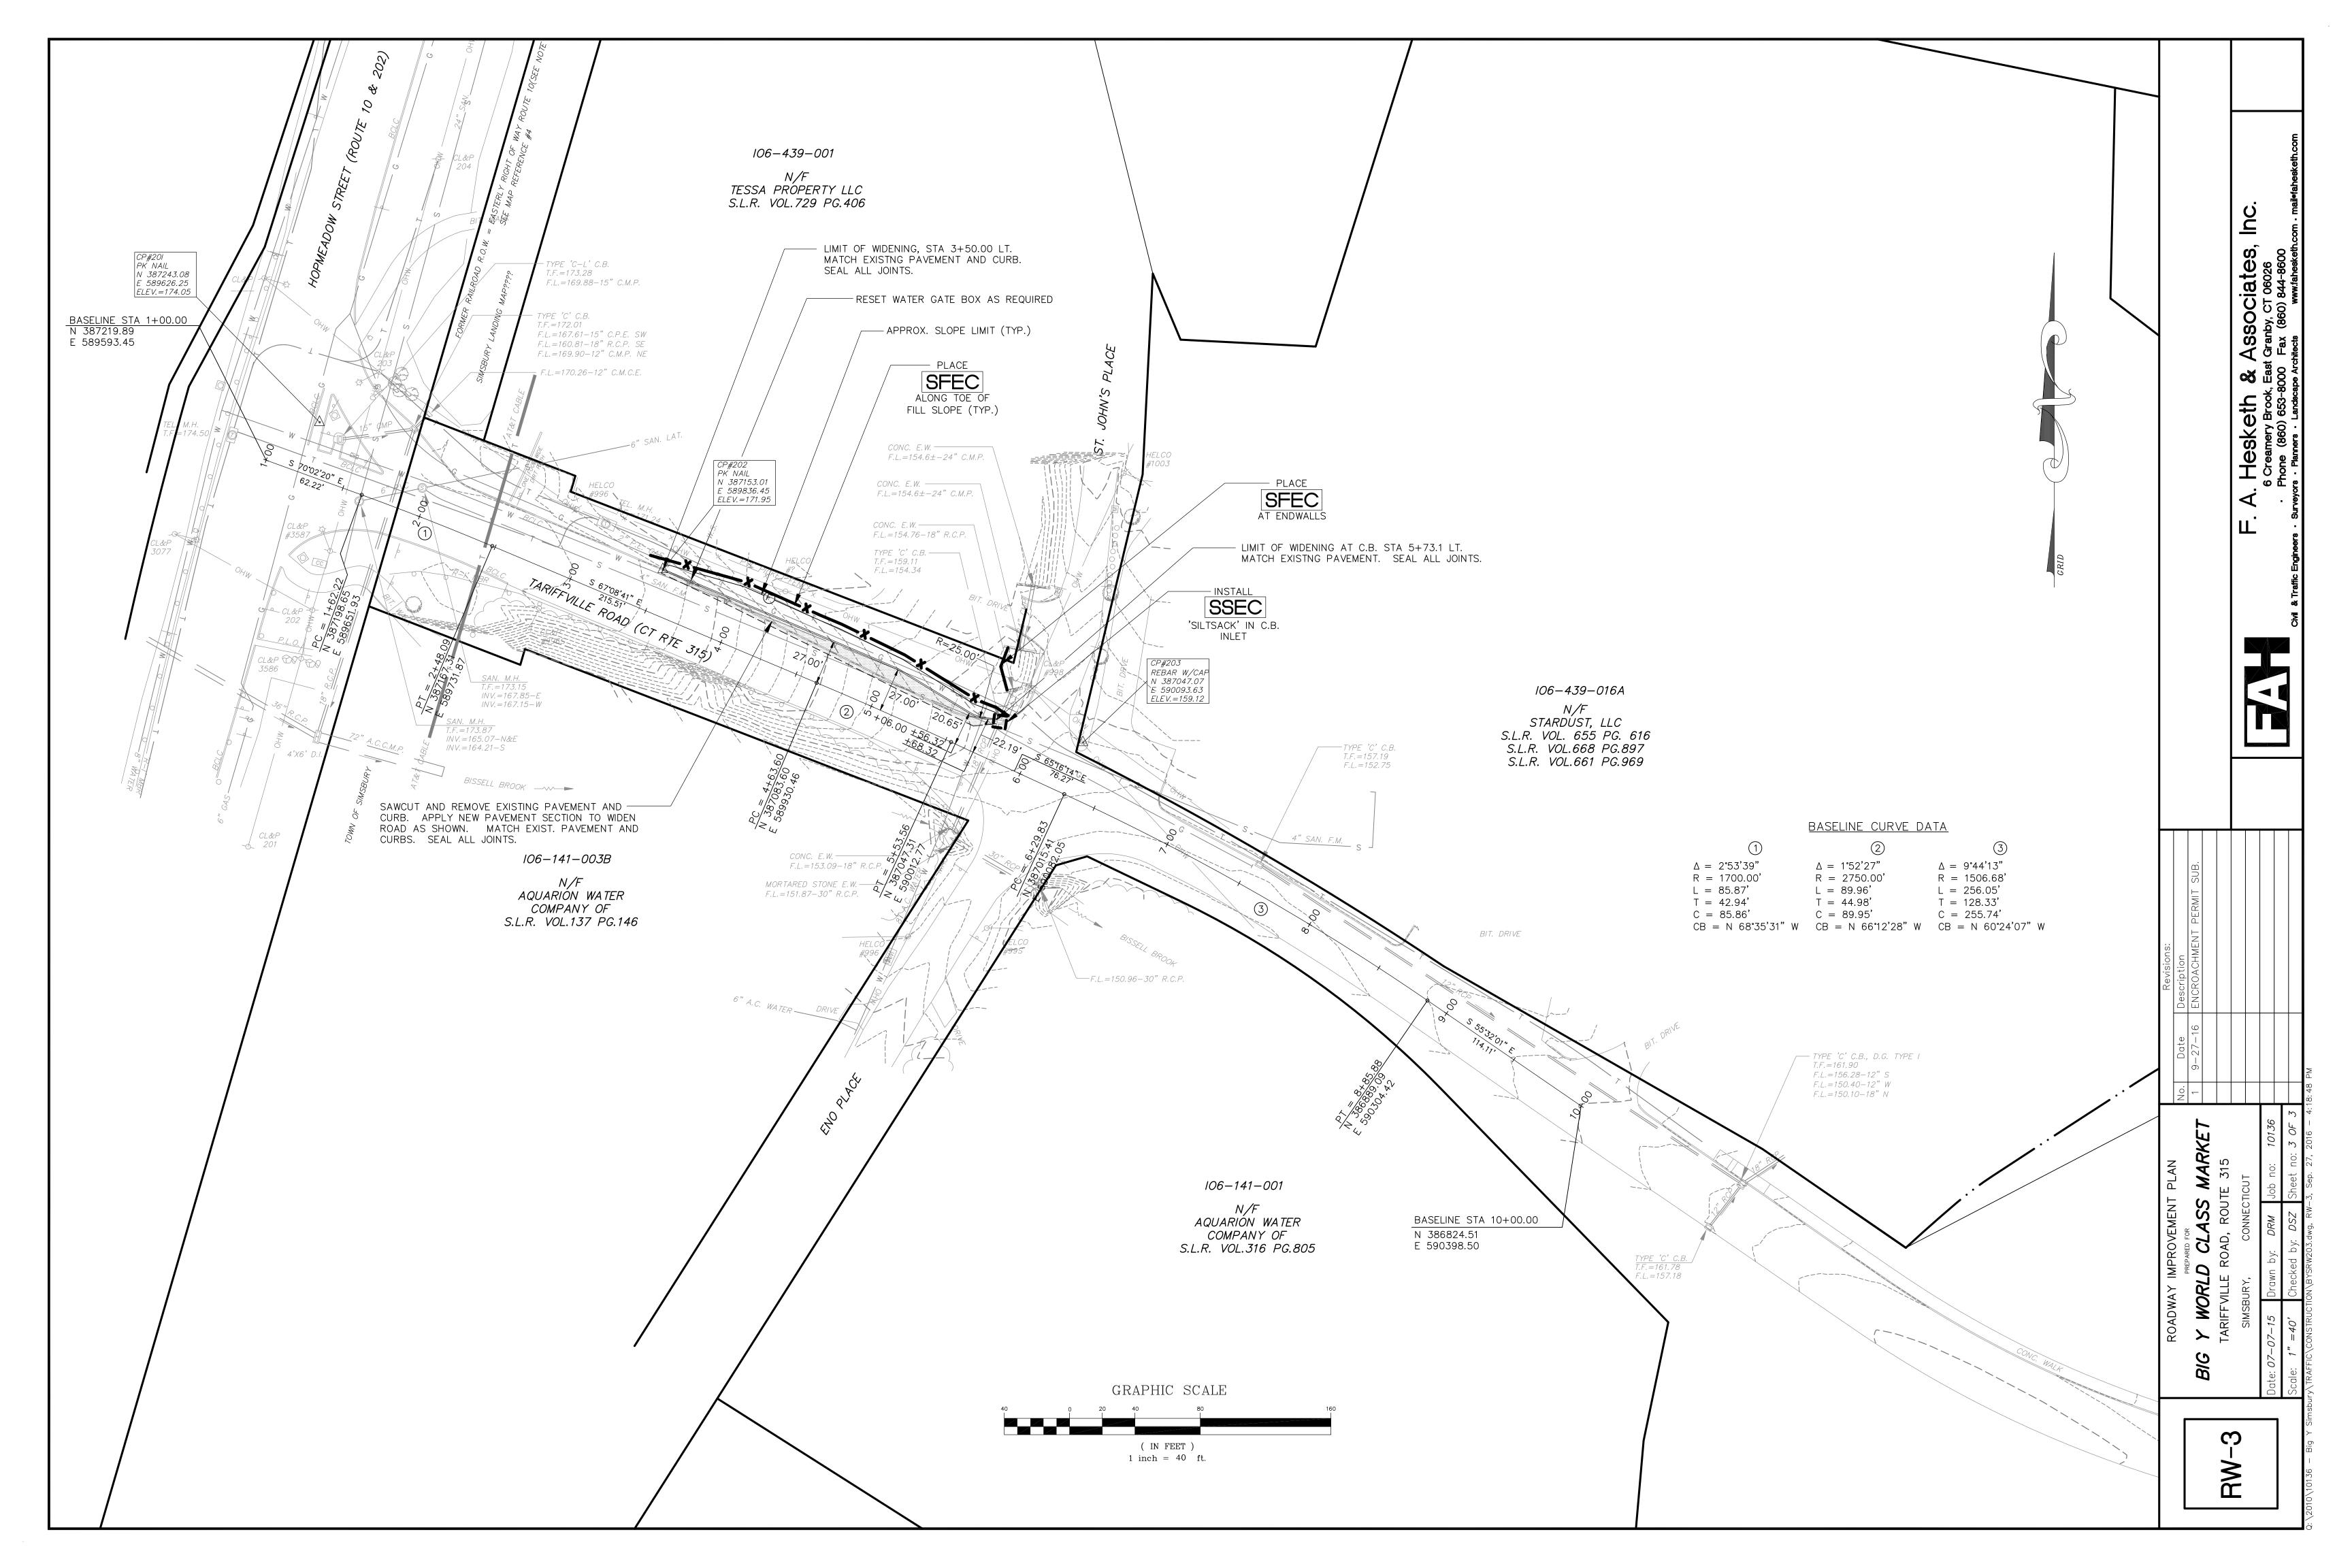


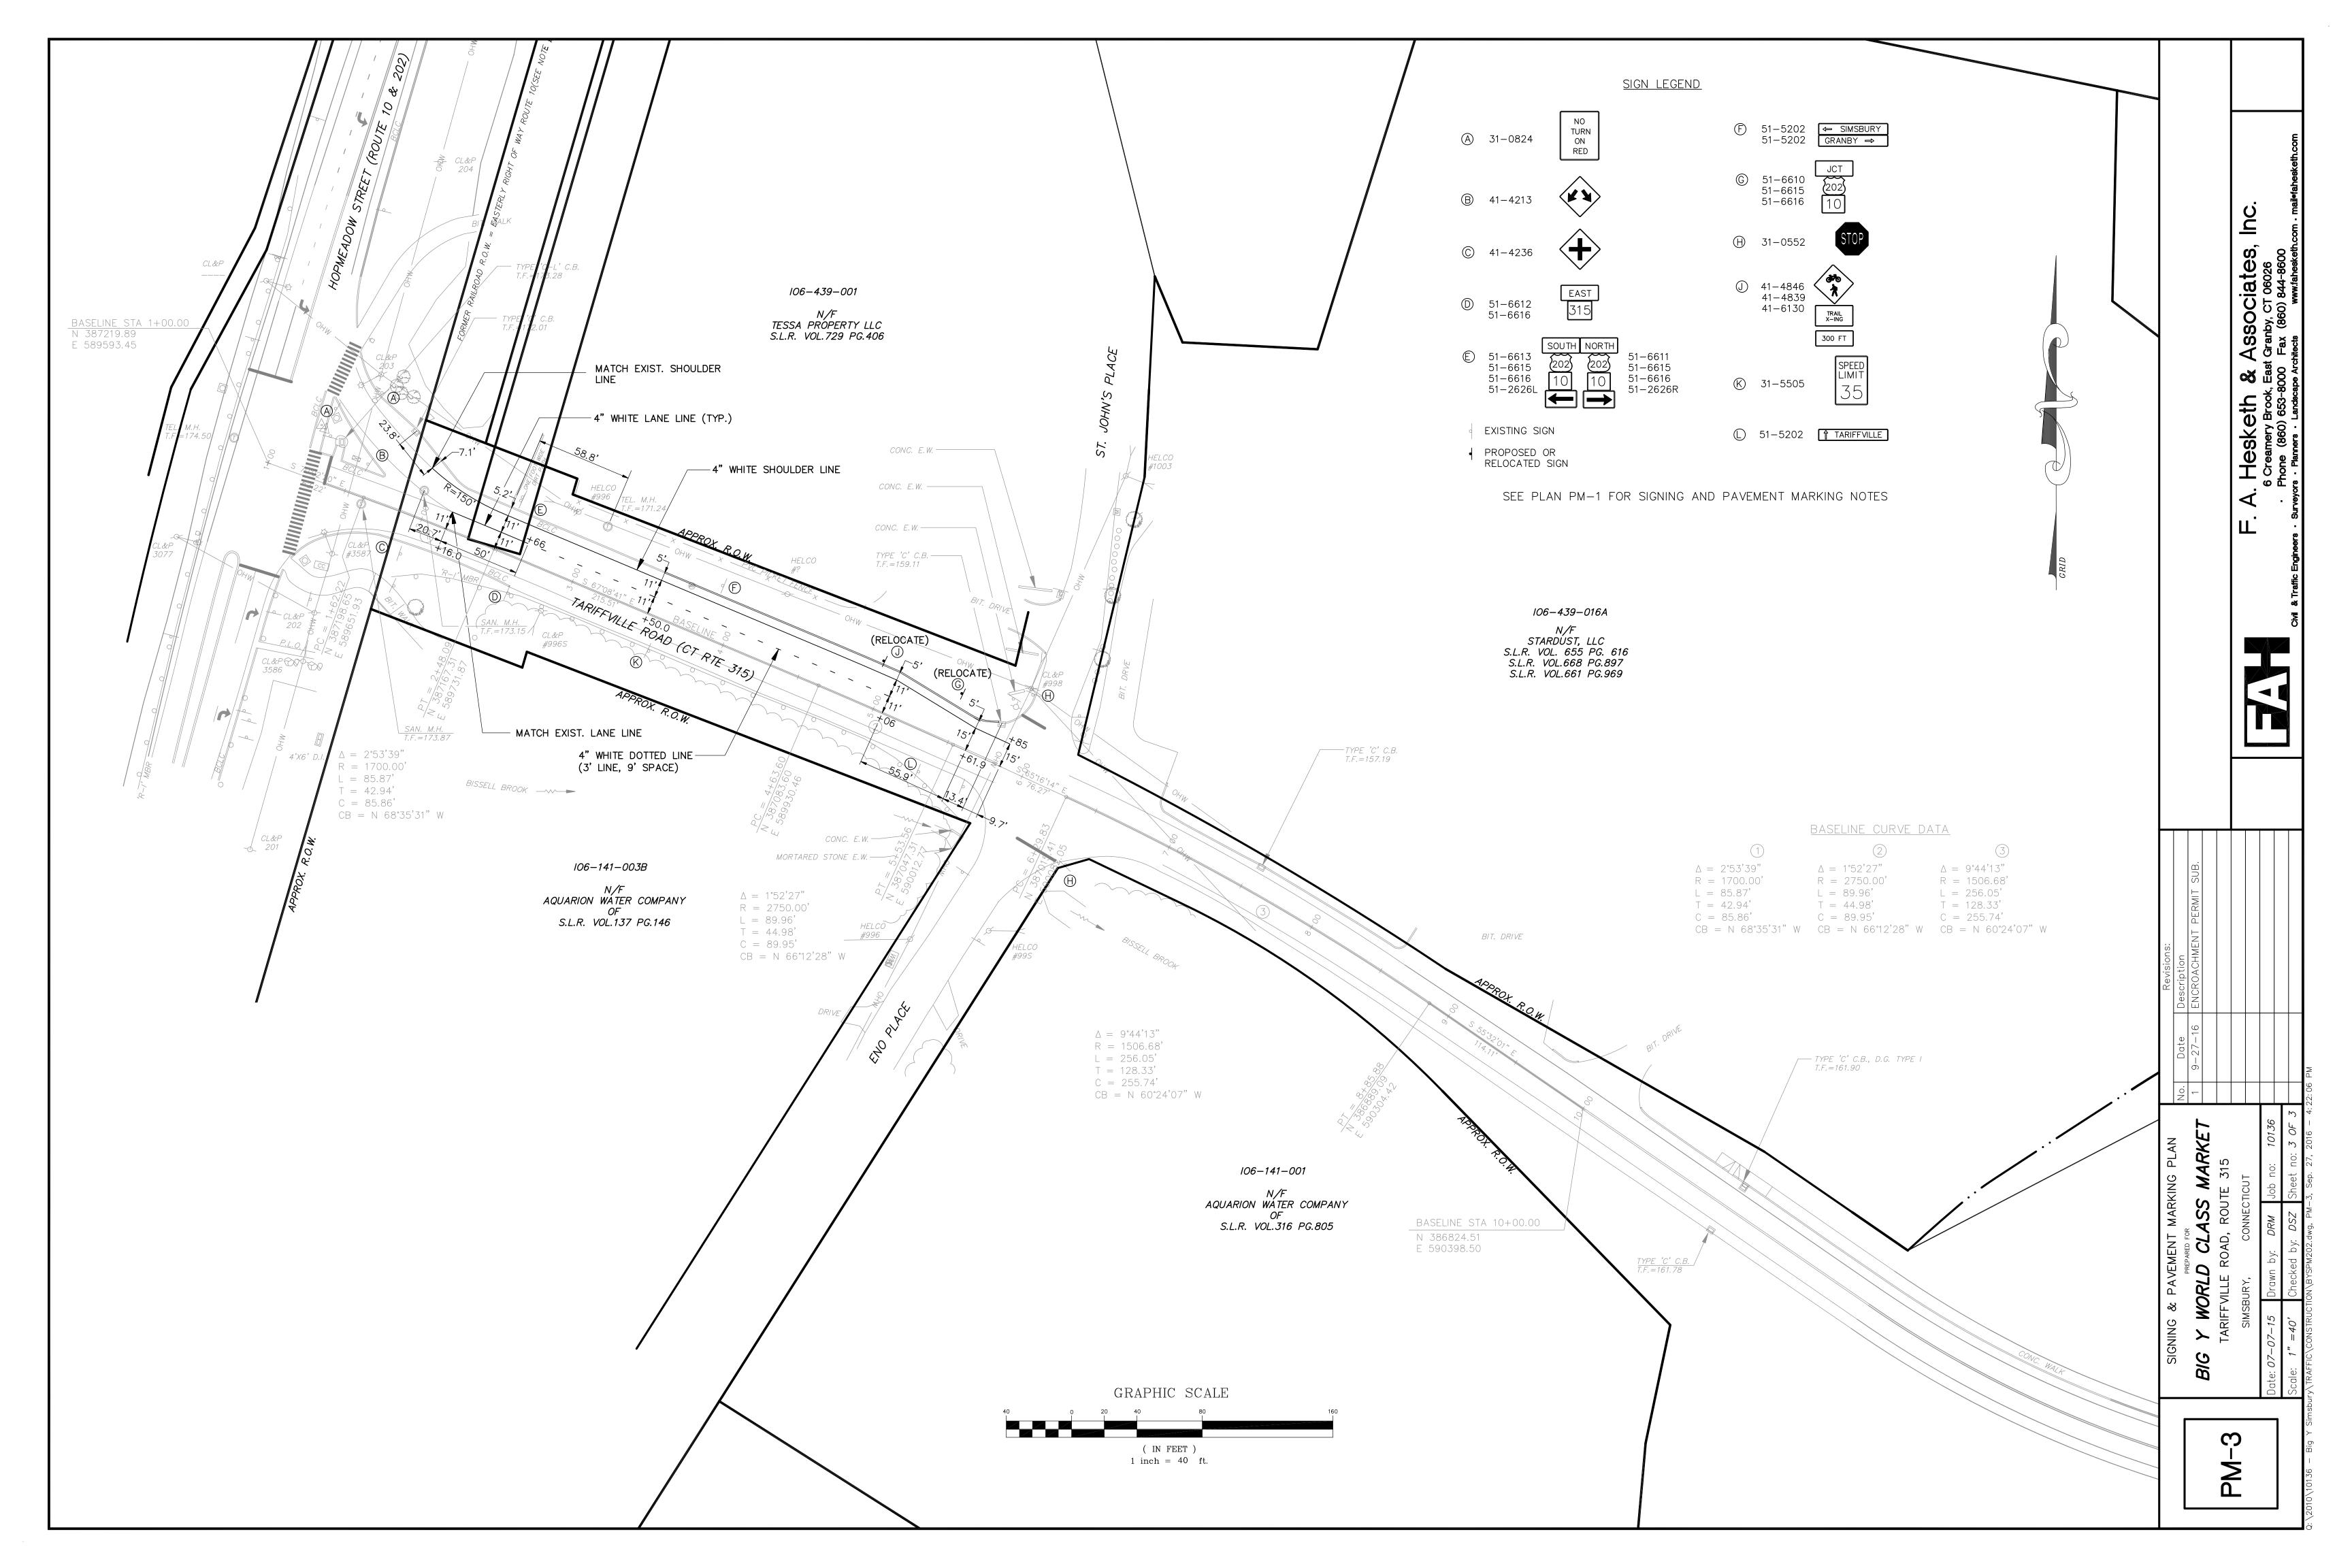


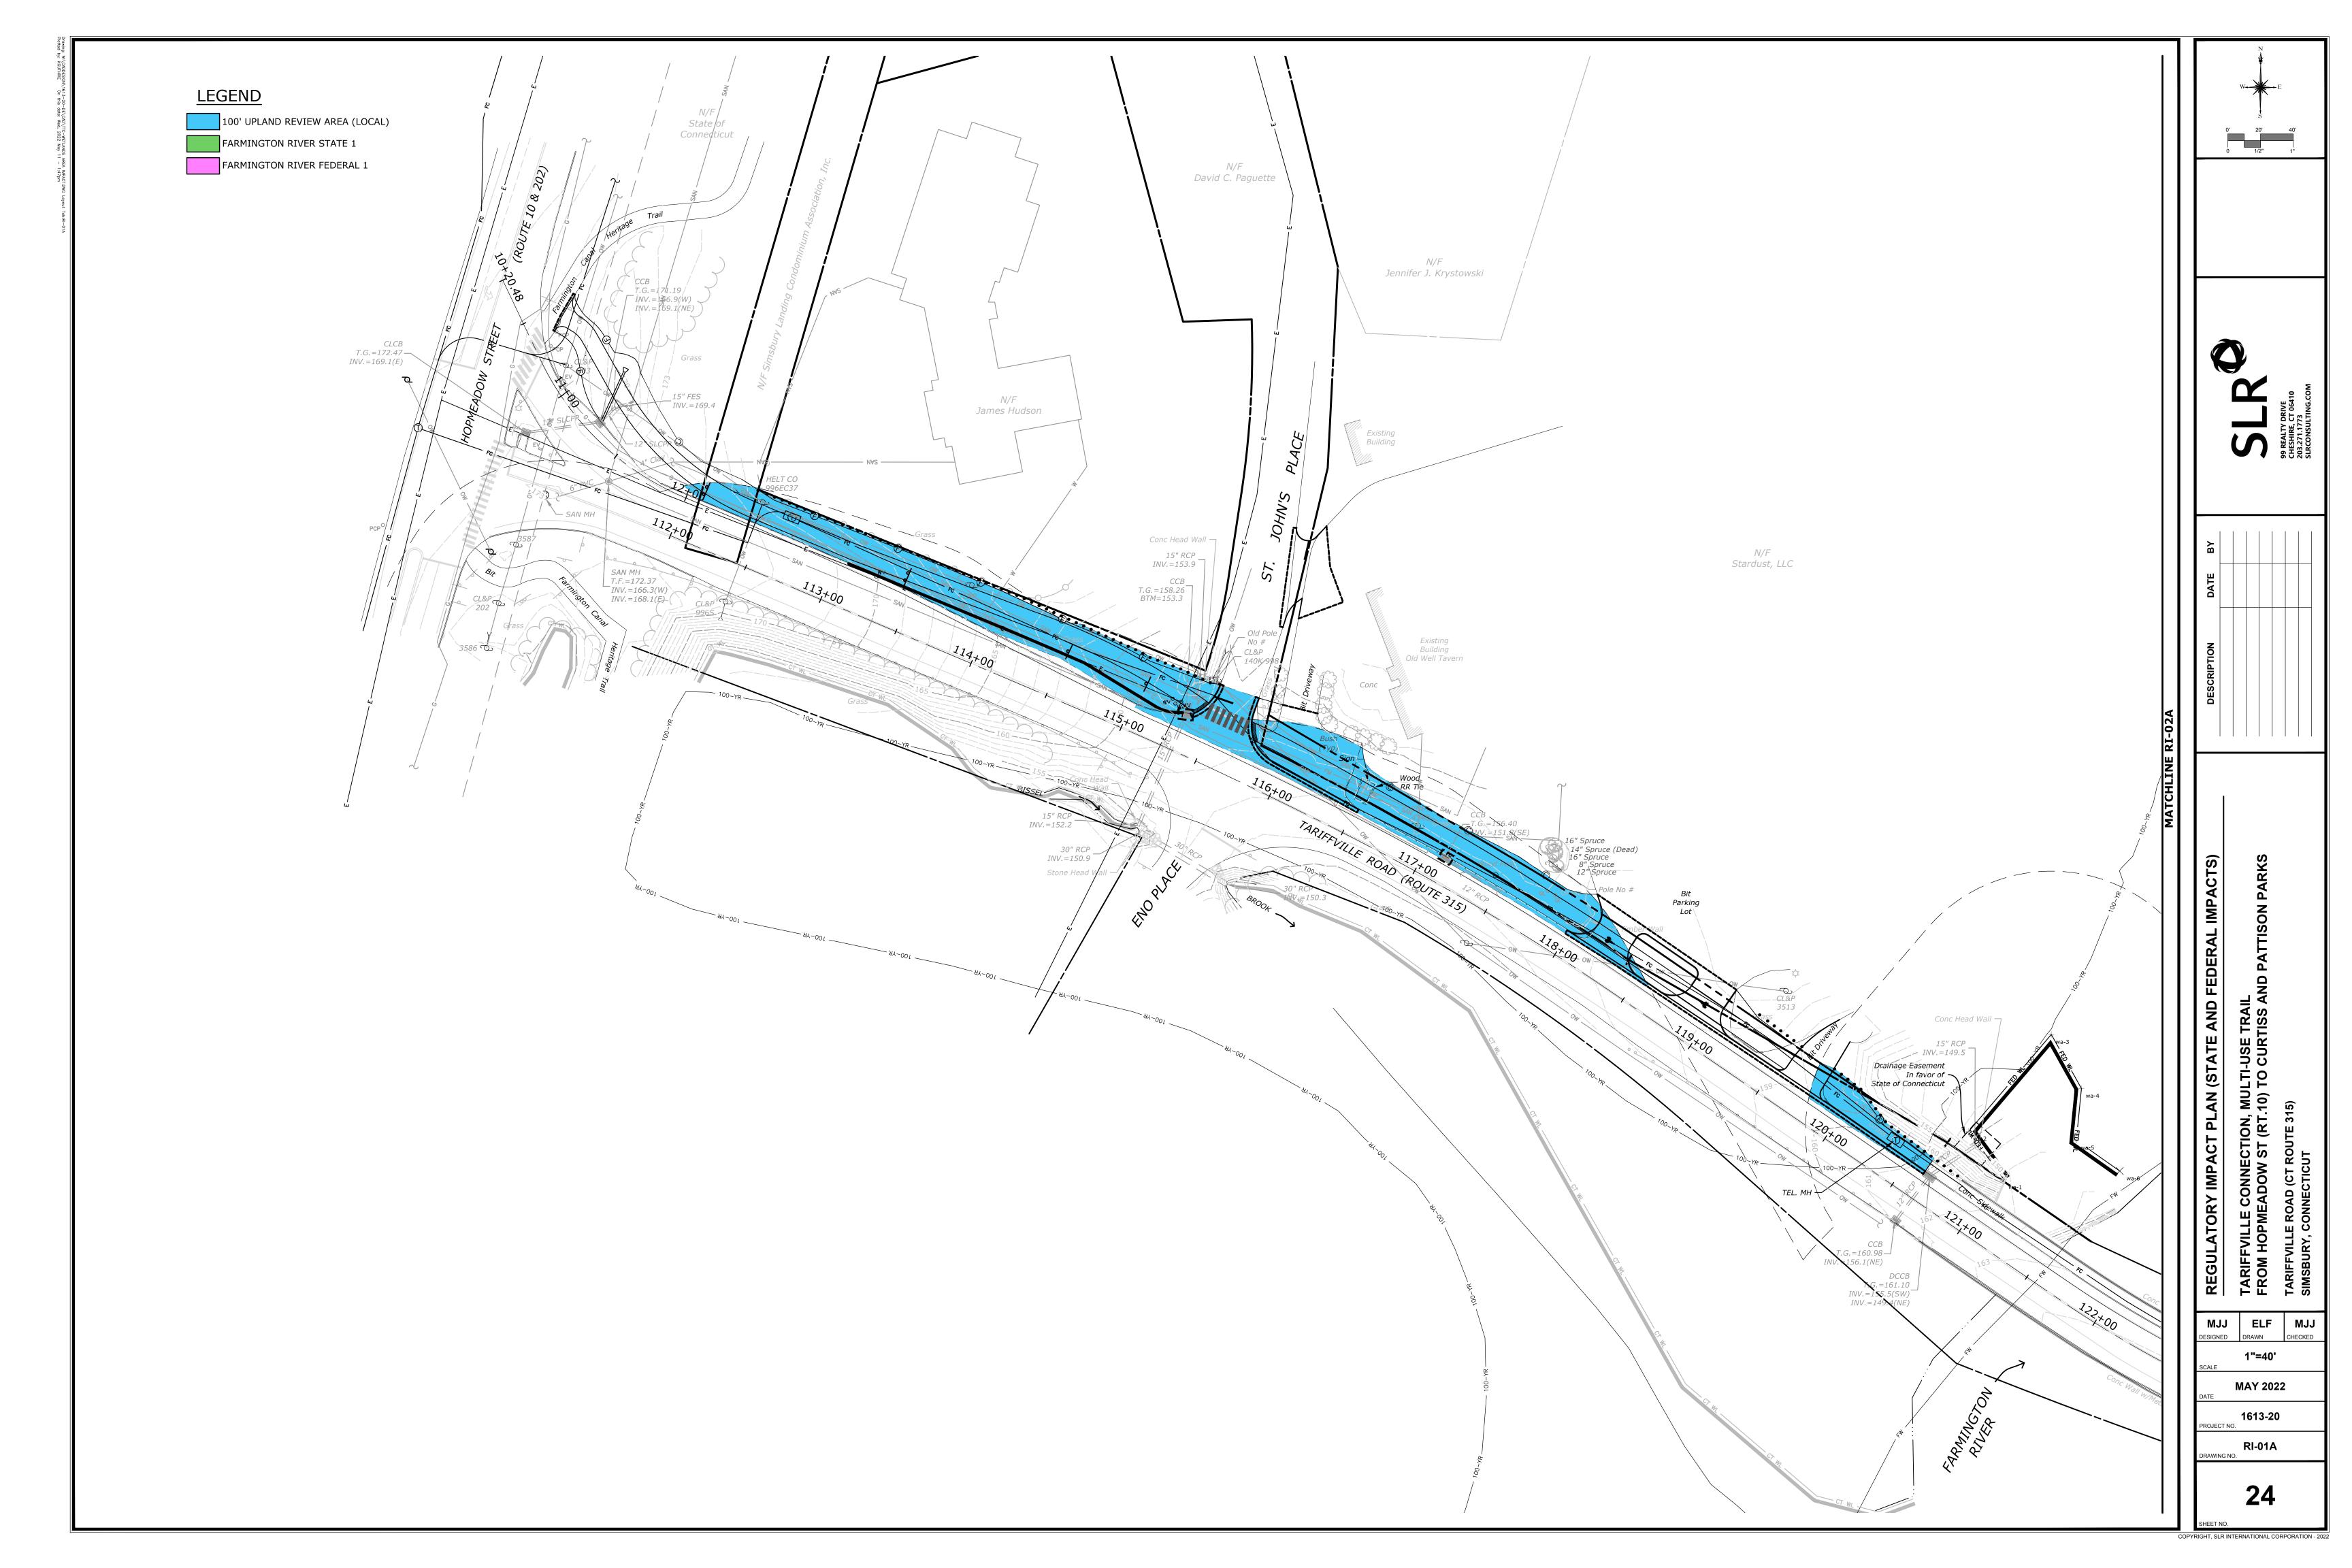

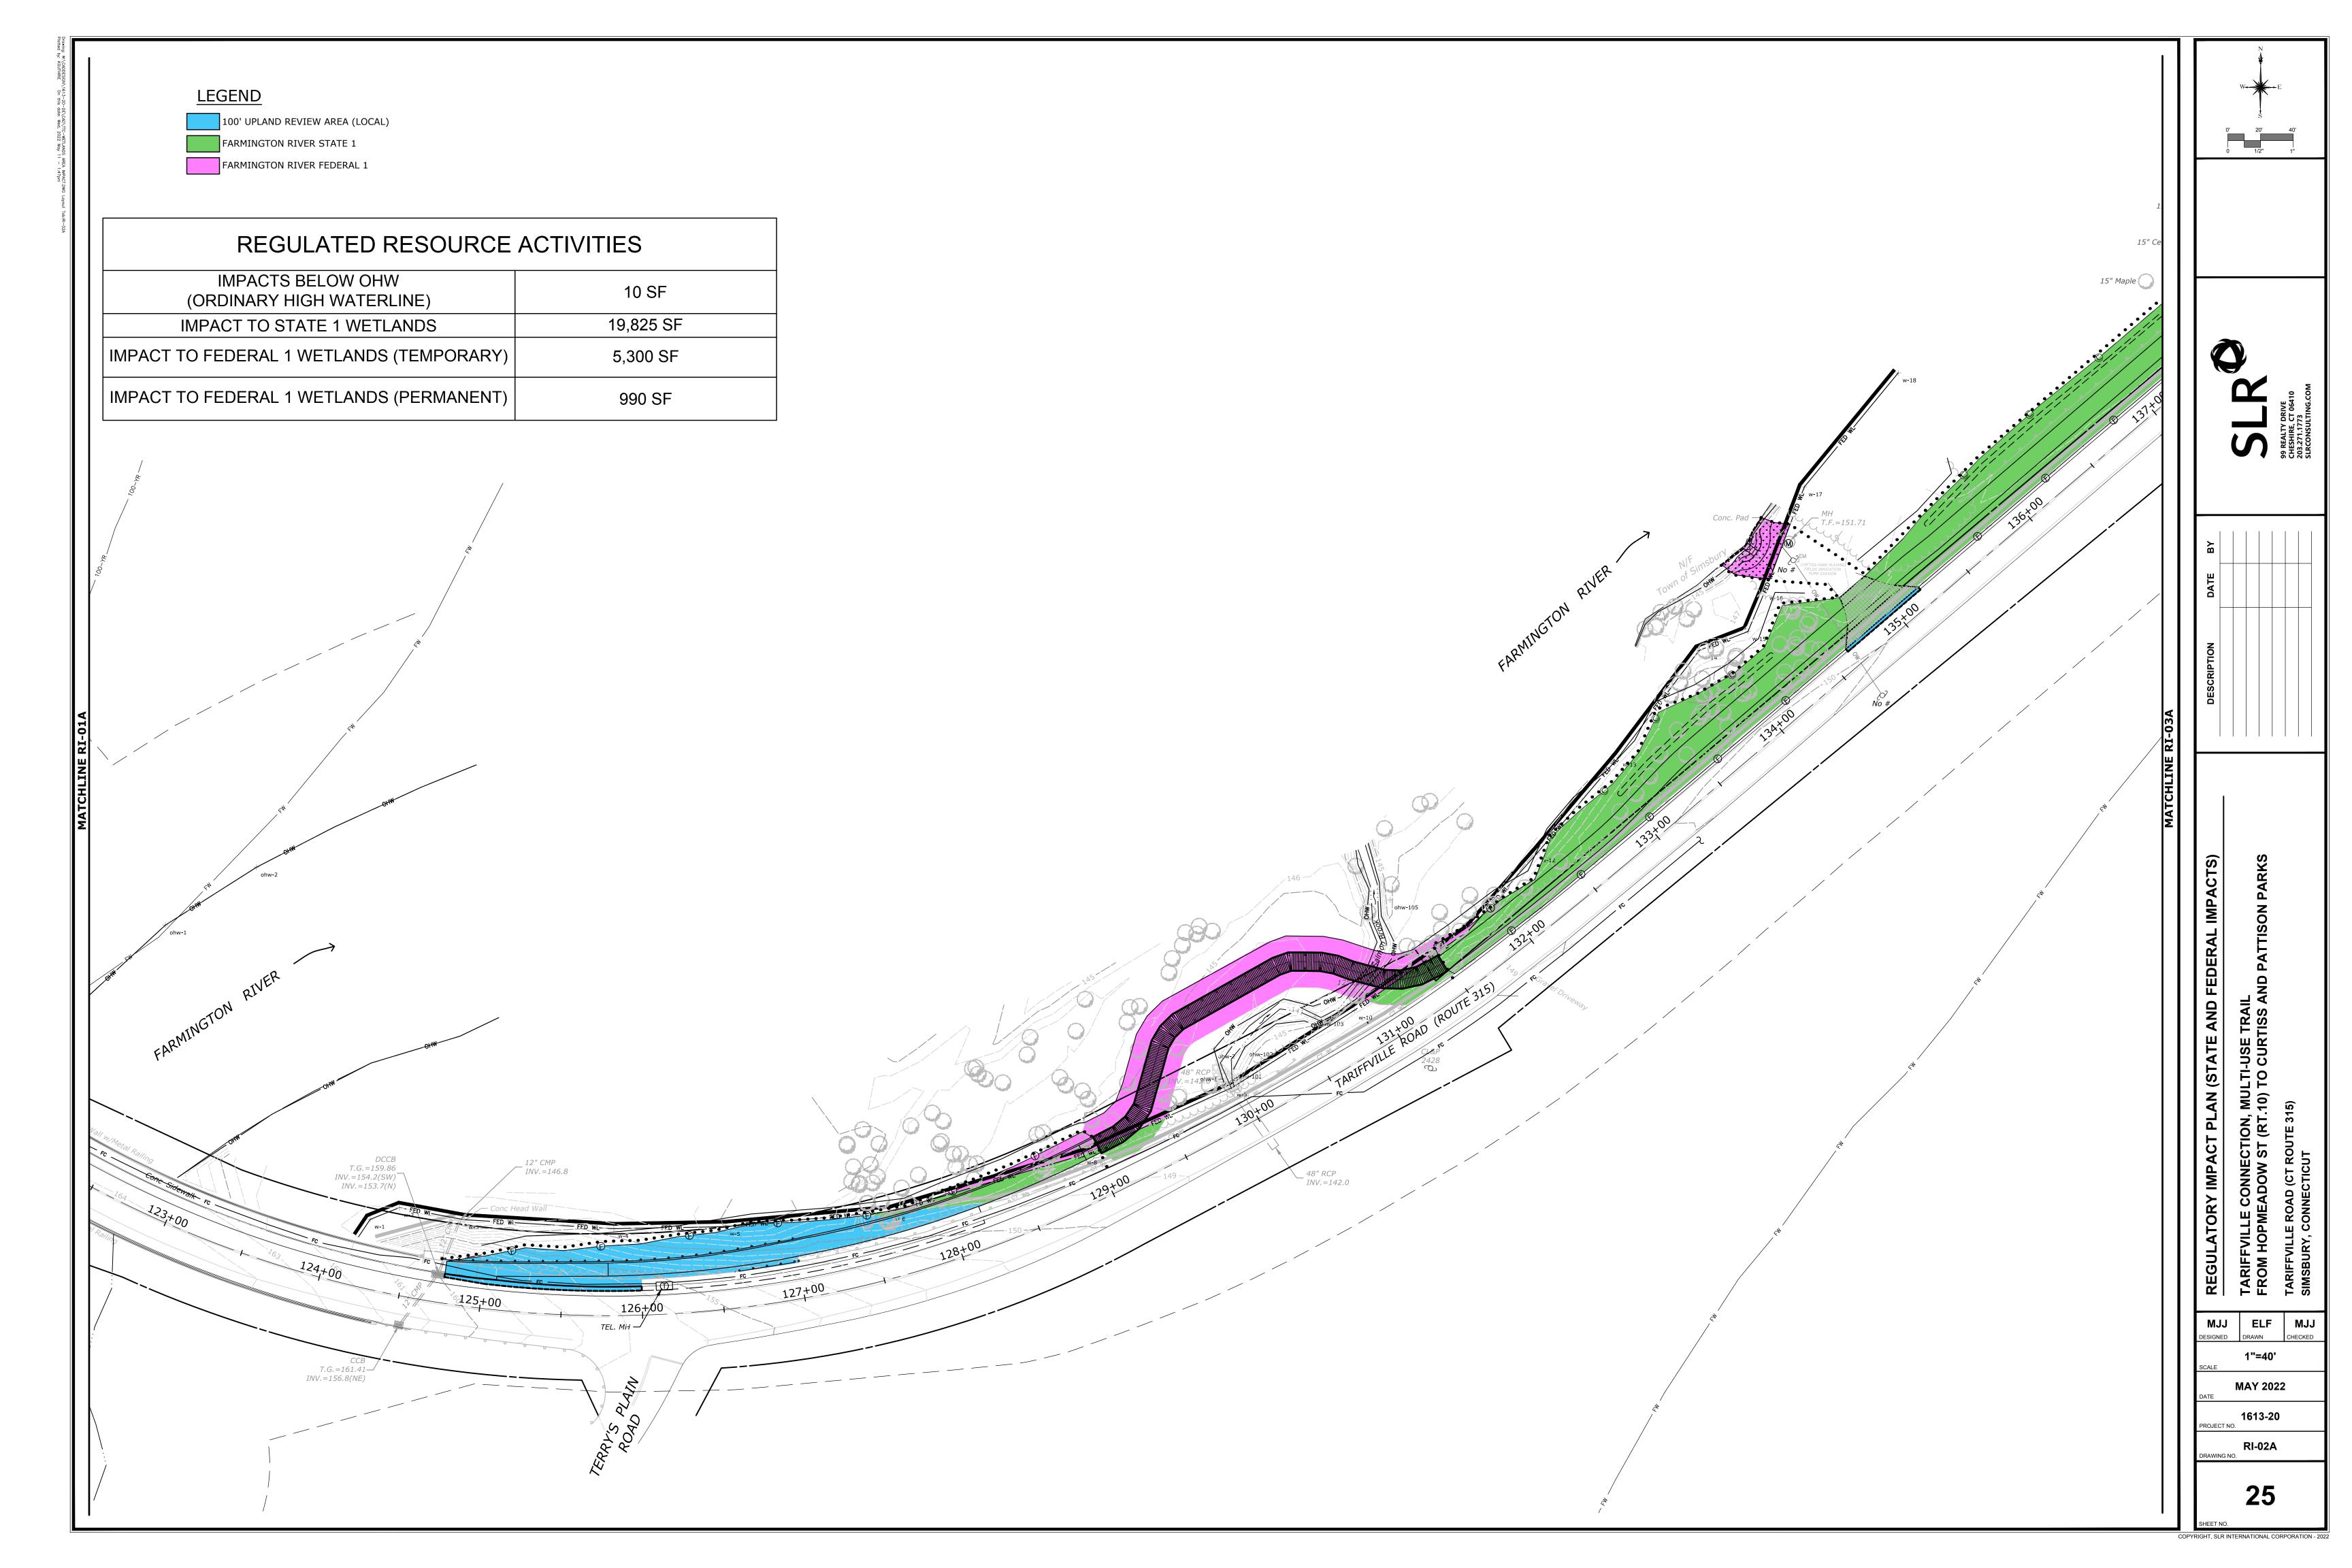

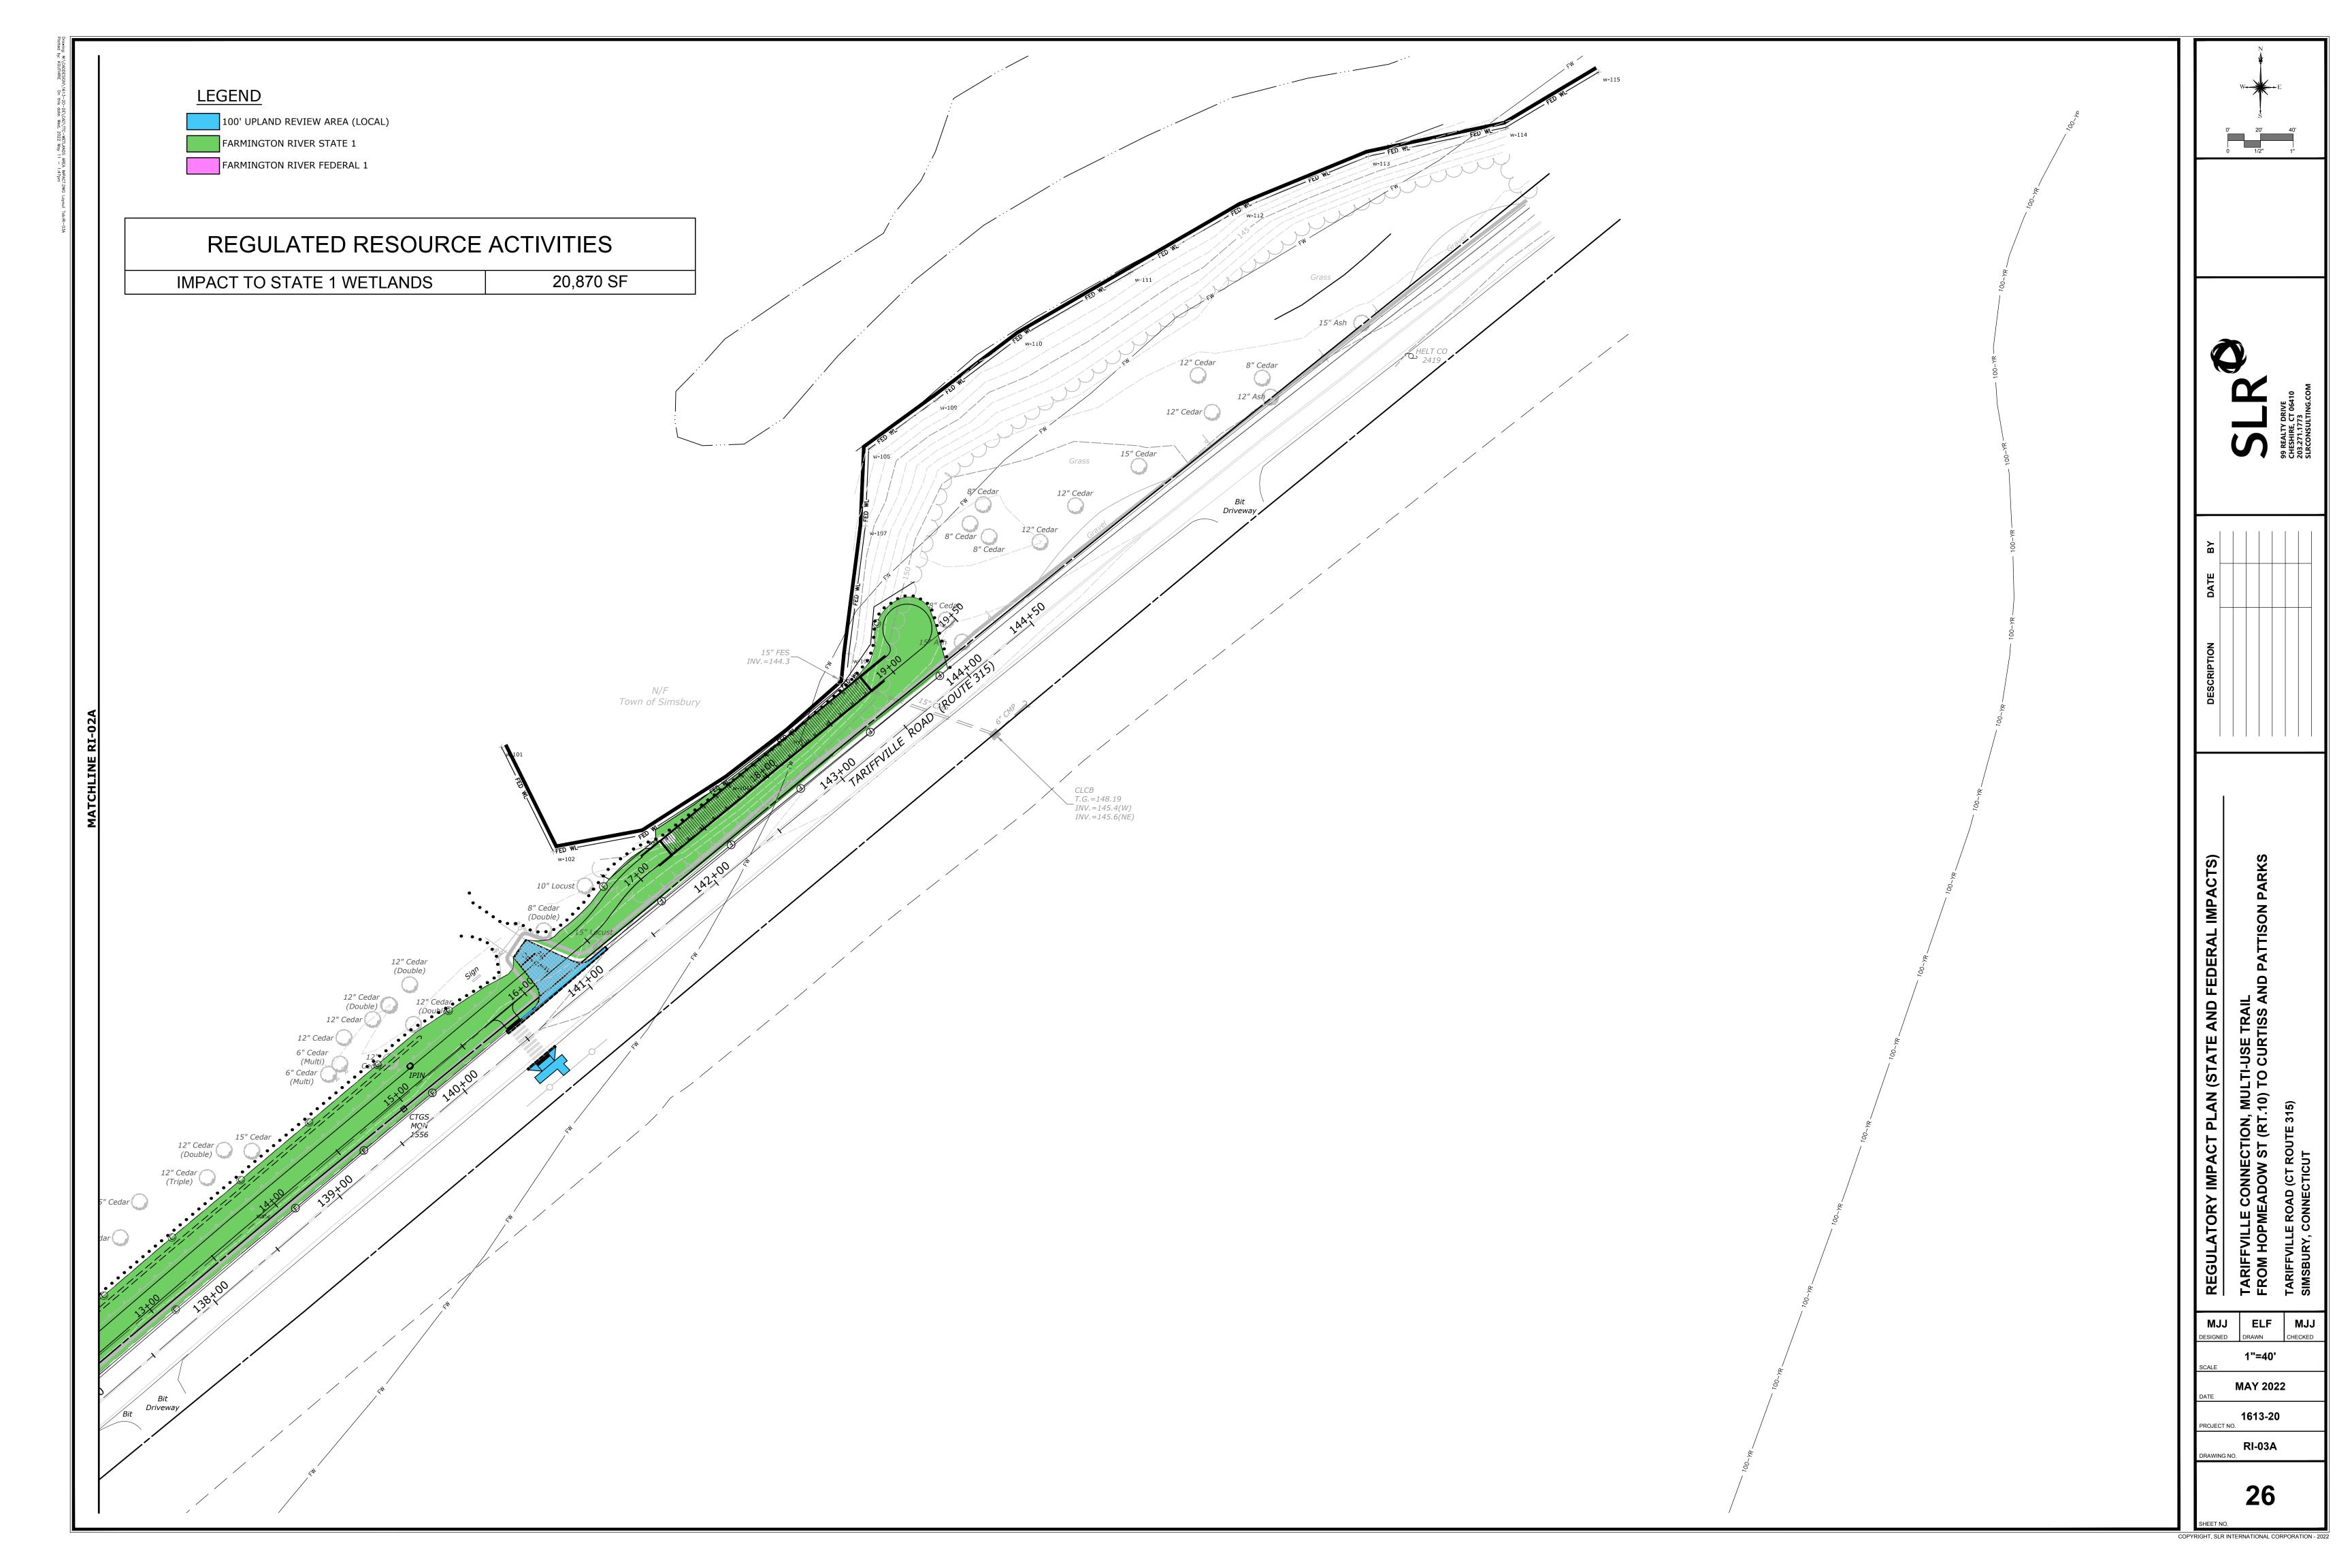

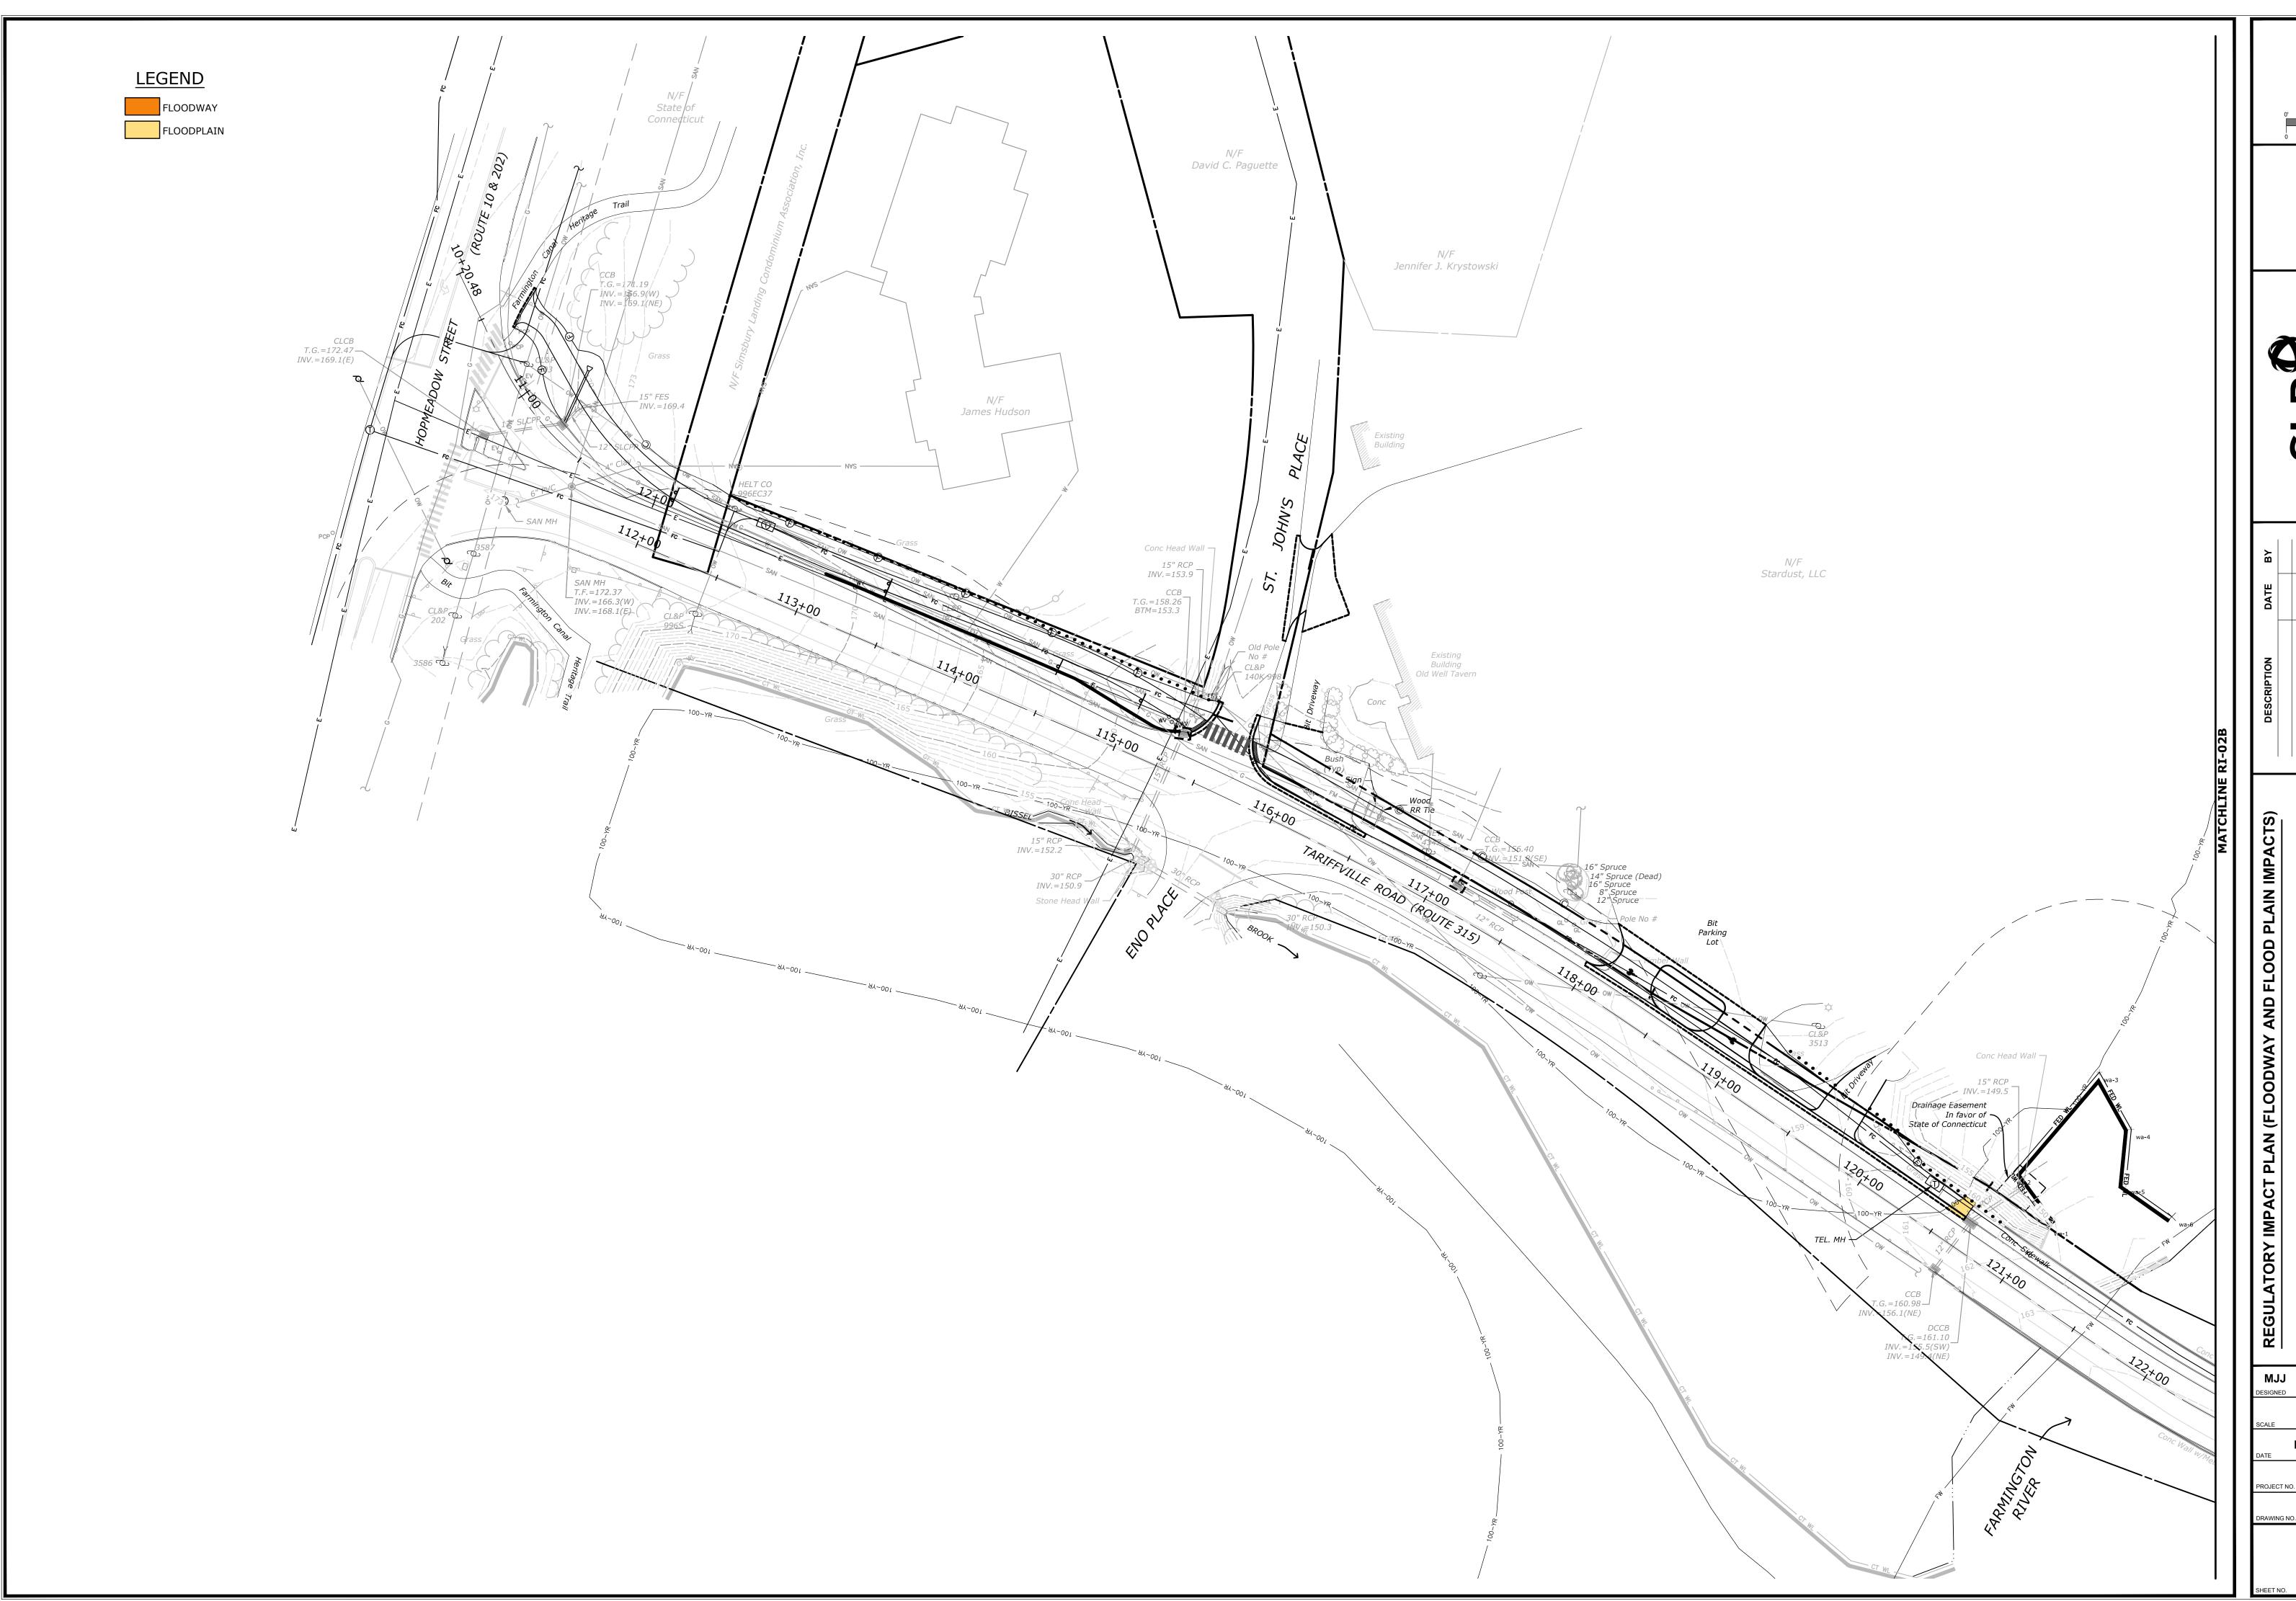

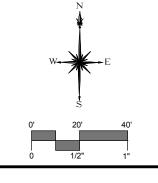

TARIFFVILLE CONNECTION, MULTI-USE TRAIL
FROM HOPMEADOW ST (RT.10) TO CURTISS AND PATTISON PARKS
TARIFFVILLE ROAD (CT ROUTE 315)
SIMSBURY, CONNECTICUT

MJJ ELF MJJ CHECKED


1"=40'
SCALE


MAY 2022
DATE


1613-20
PROJECT NO.

RI-01B
DRAWING NO.


27

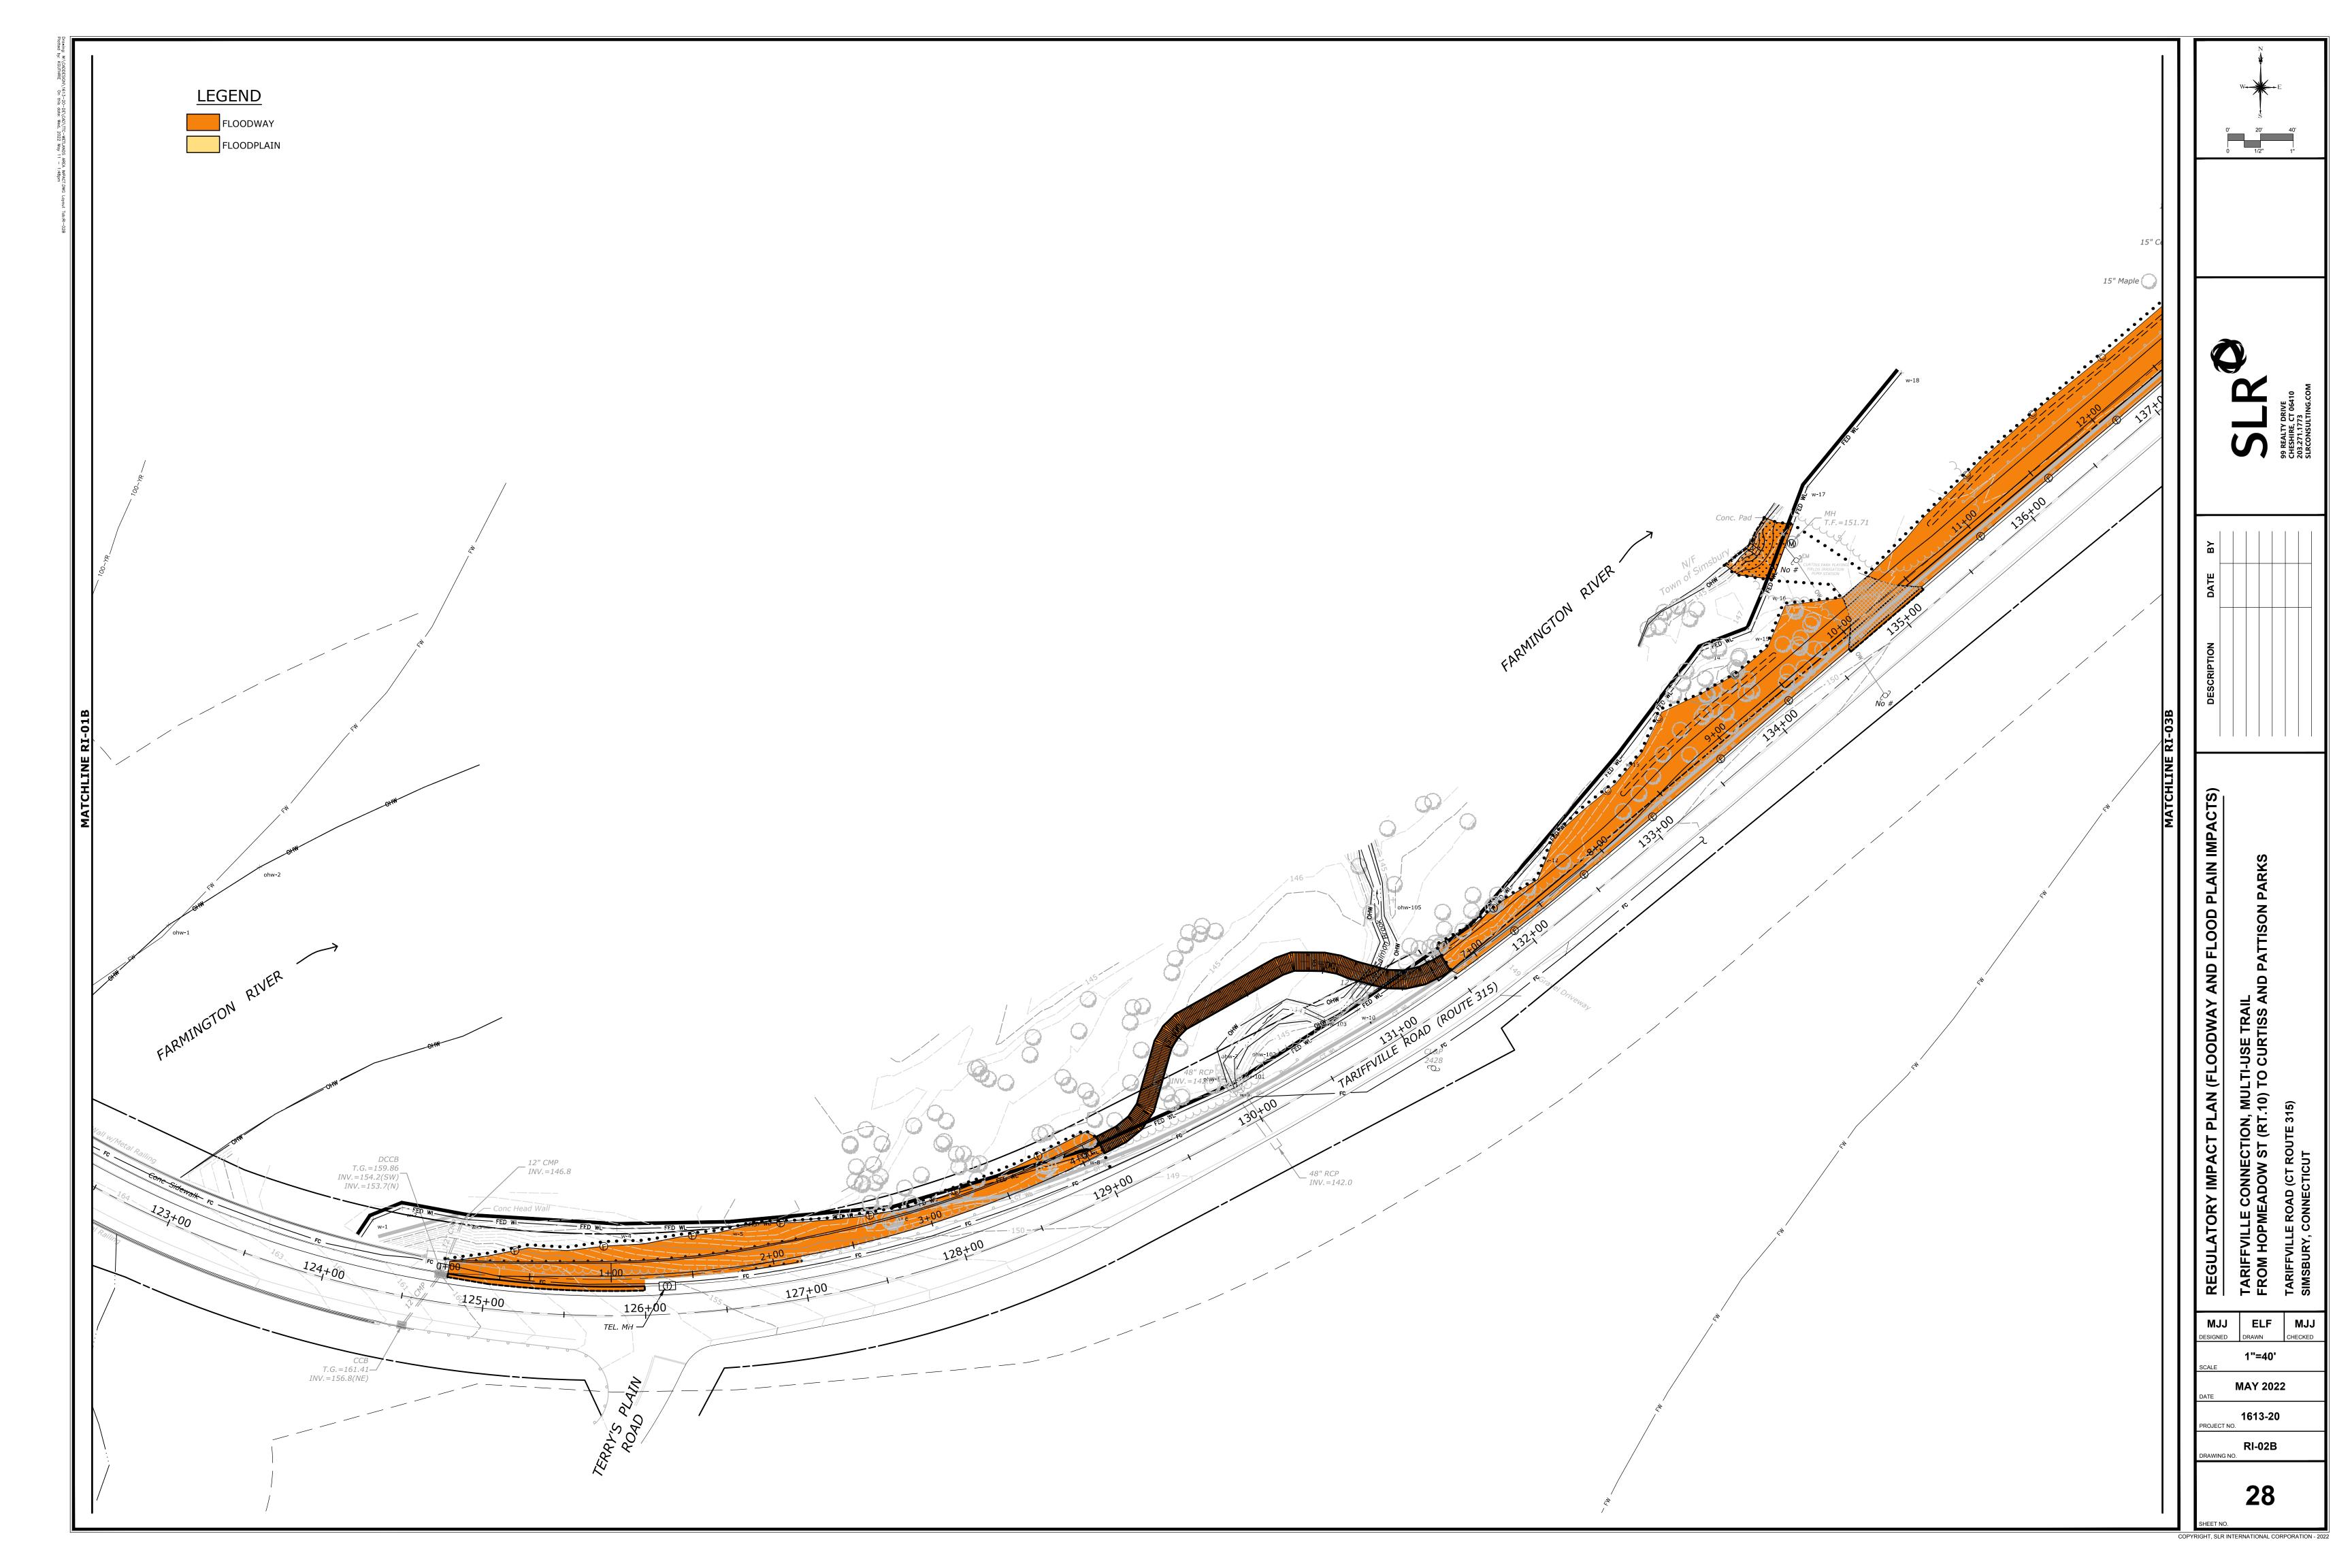

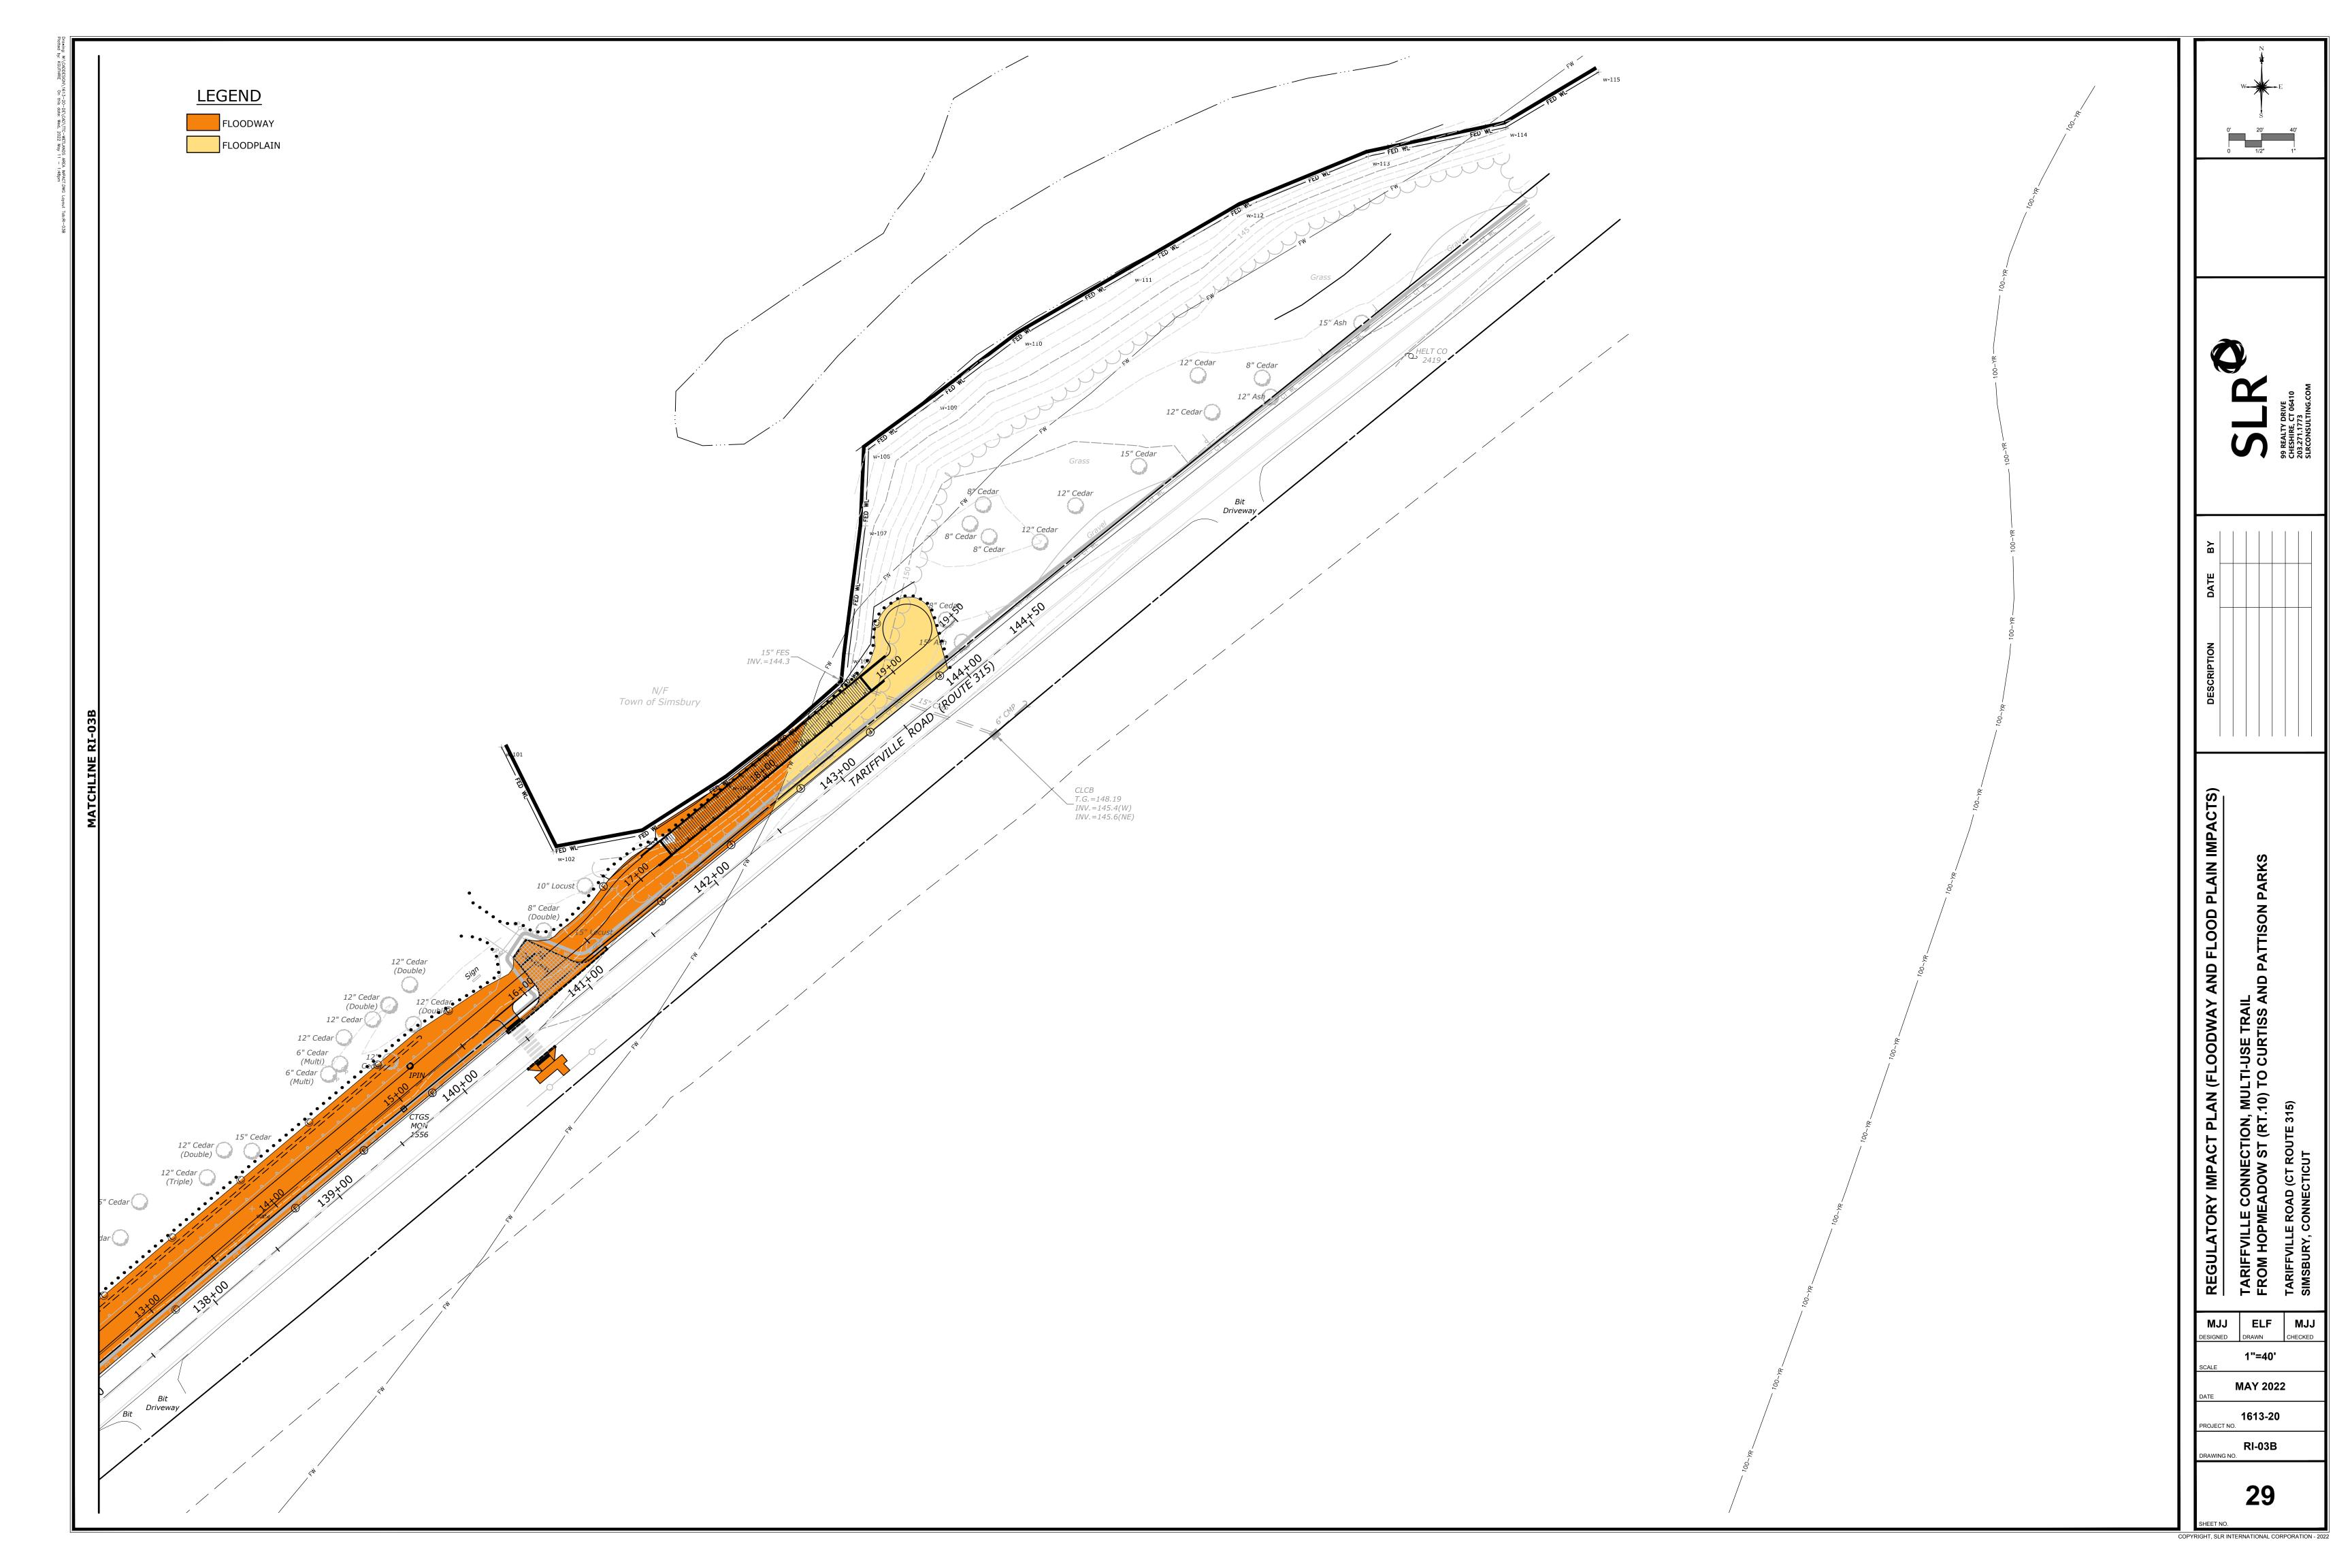

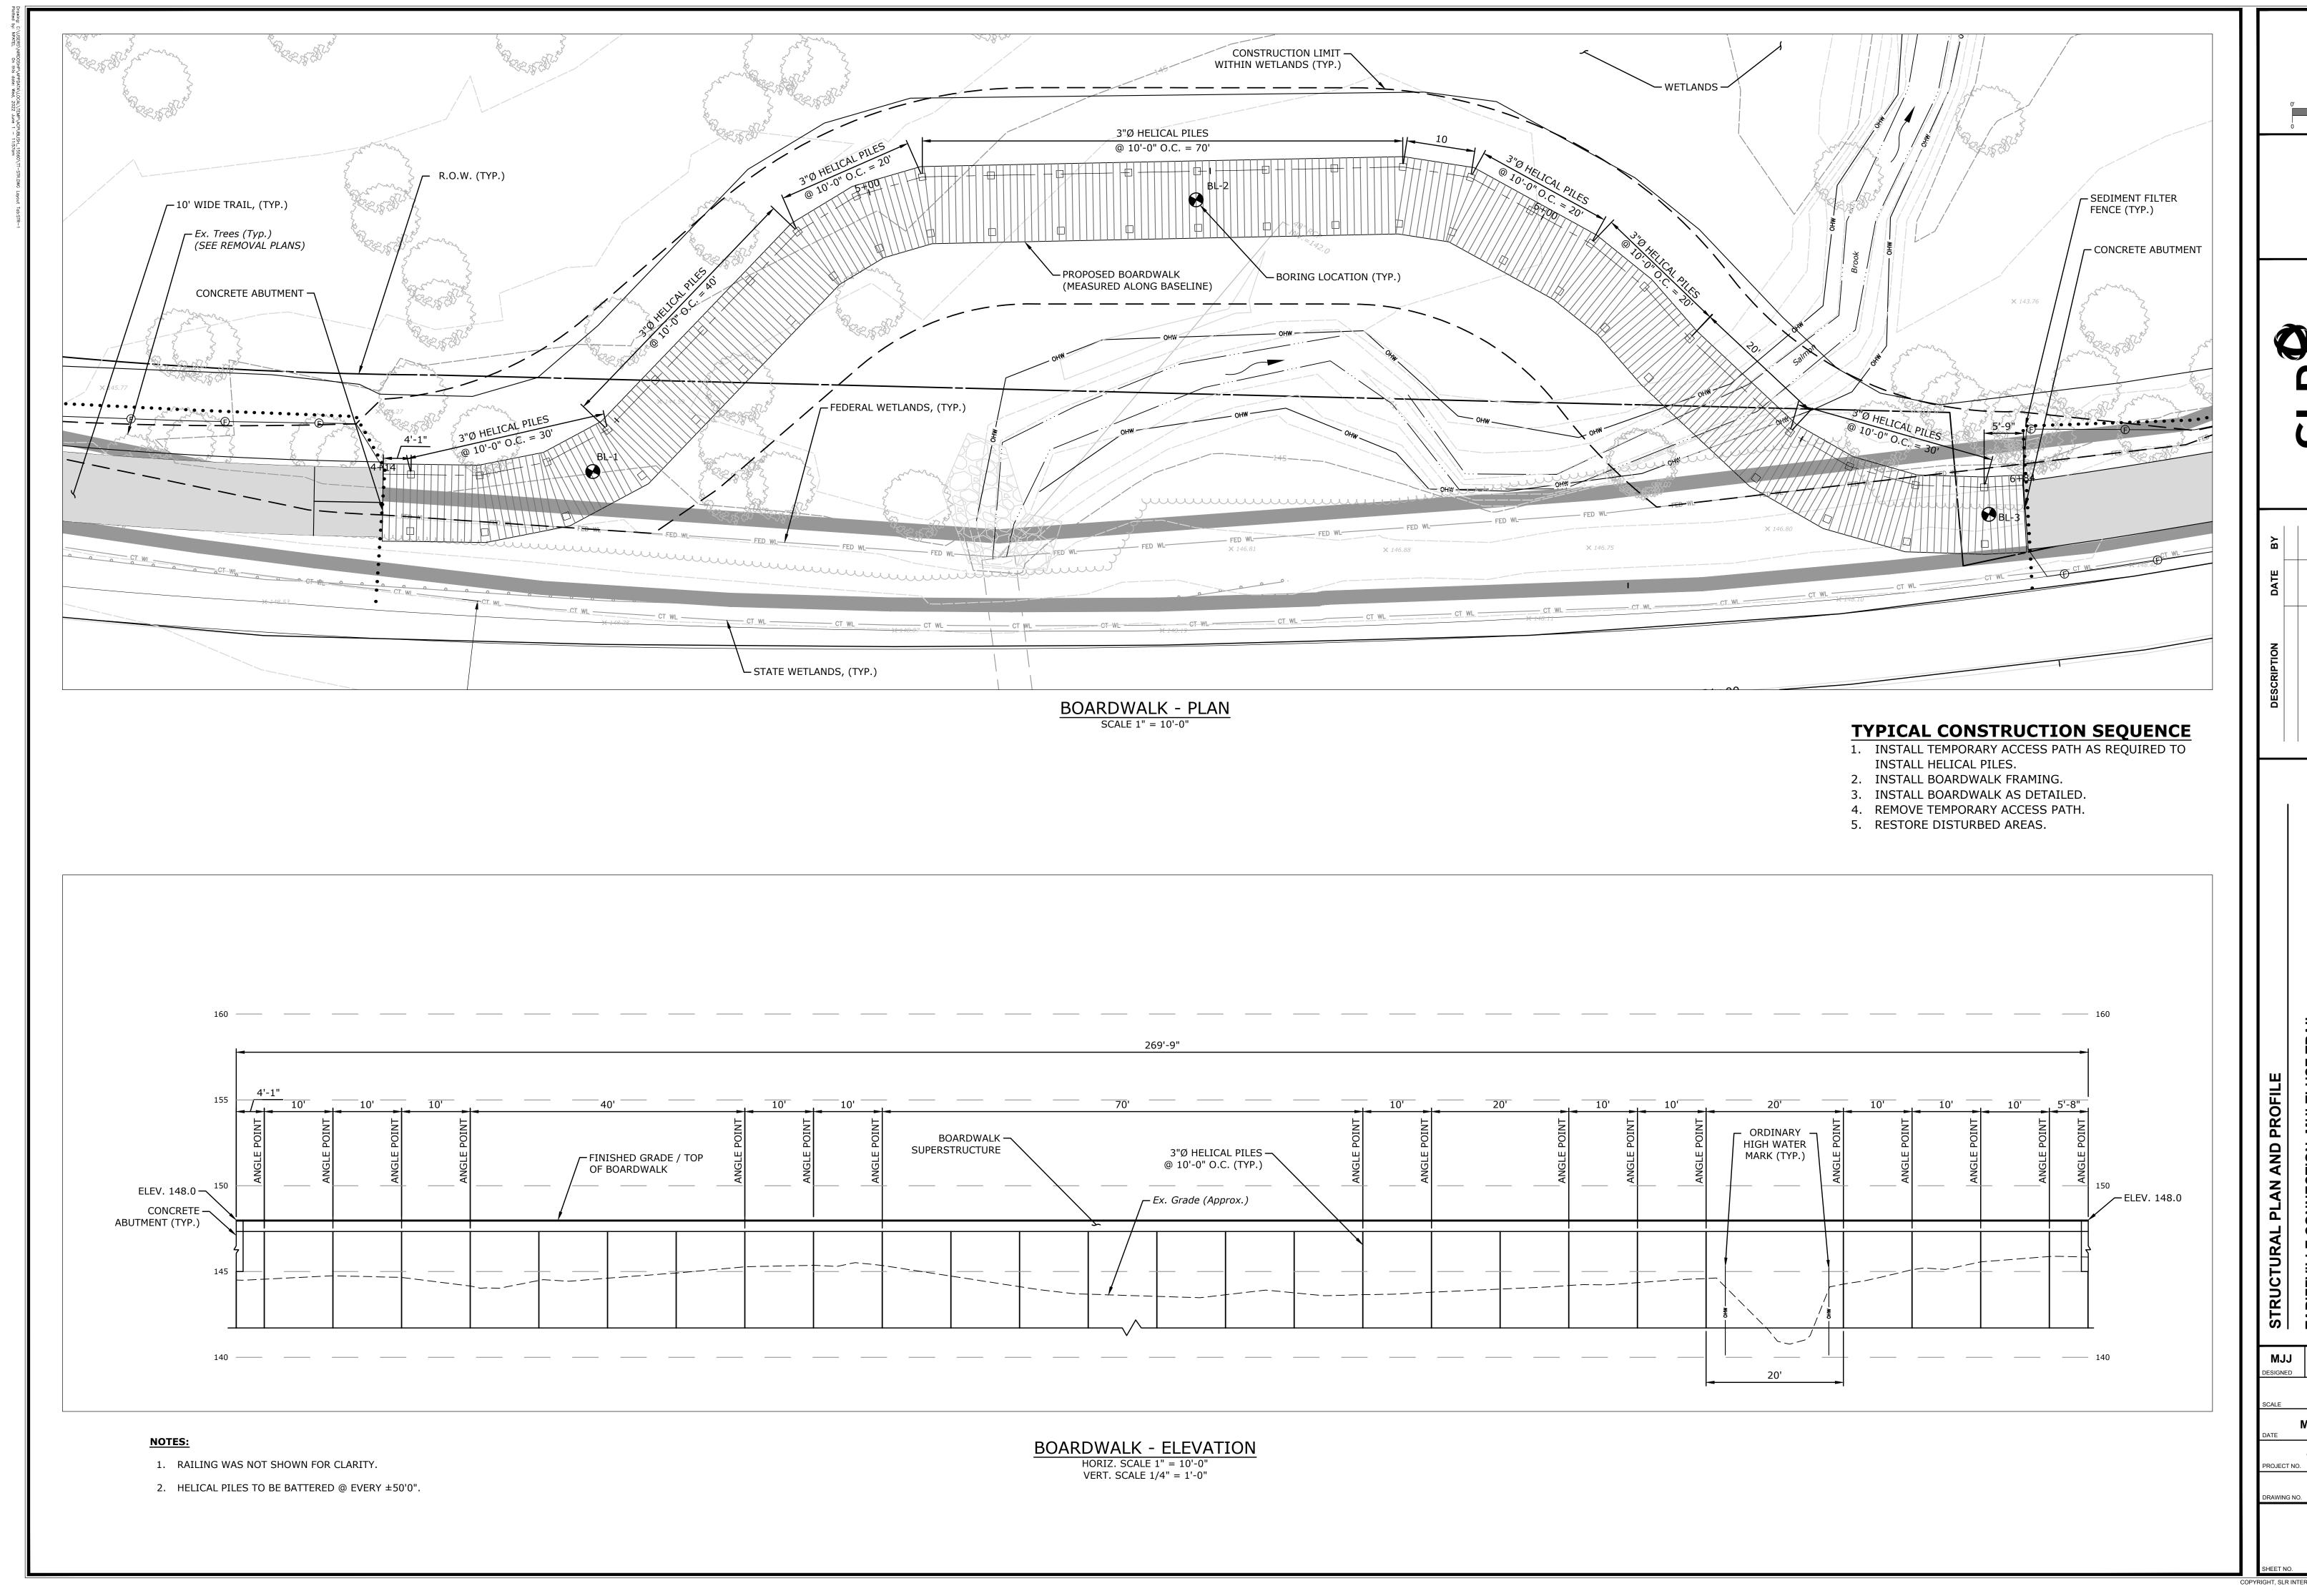




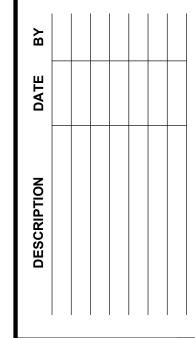

TARIFFVILLE CONNECTION, MULTI-USE TRAIL
FROM HOPMEADOW ST (RT.10) TO CURTISS AND PATTISON
TARIFFVILLE ROAD (CT ROUTE 315)
SIMSBURY, CONNECTICUT


MJJ ELF MJJ

MAY 2022

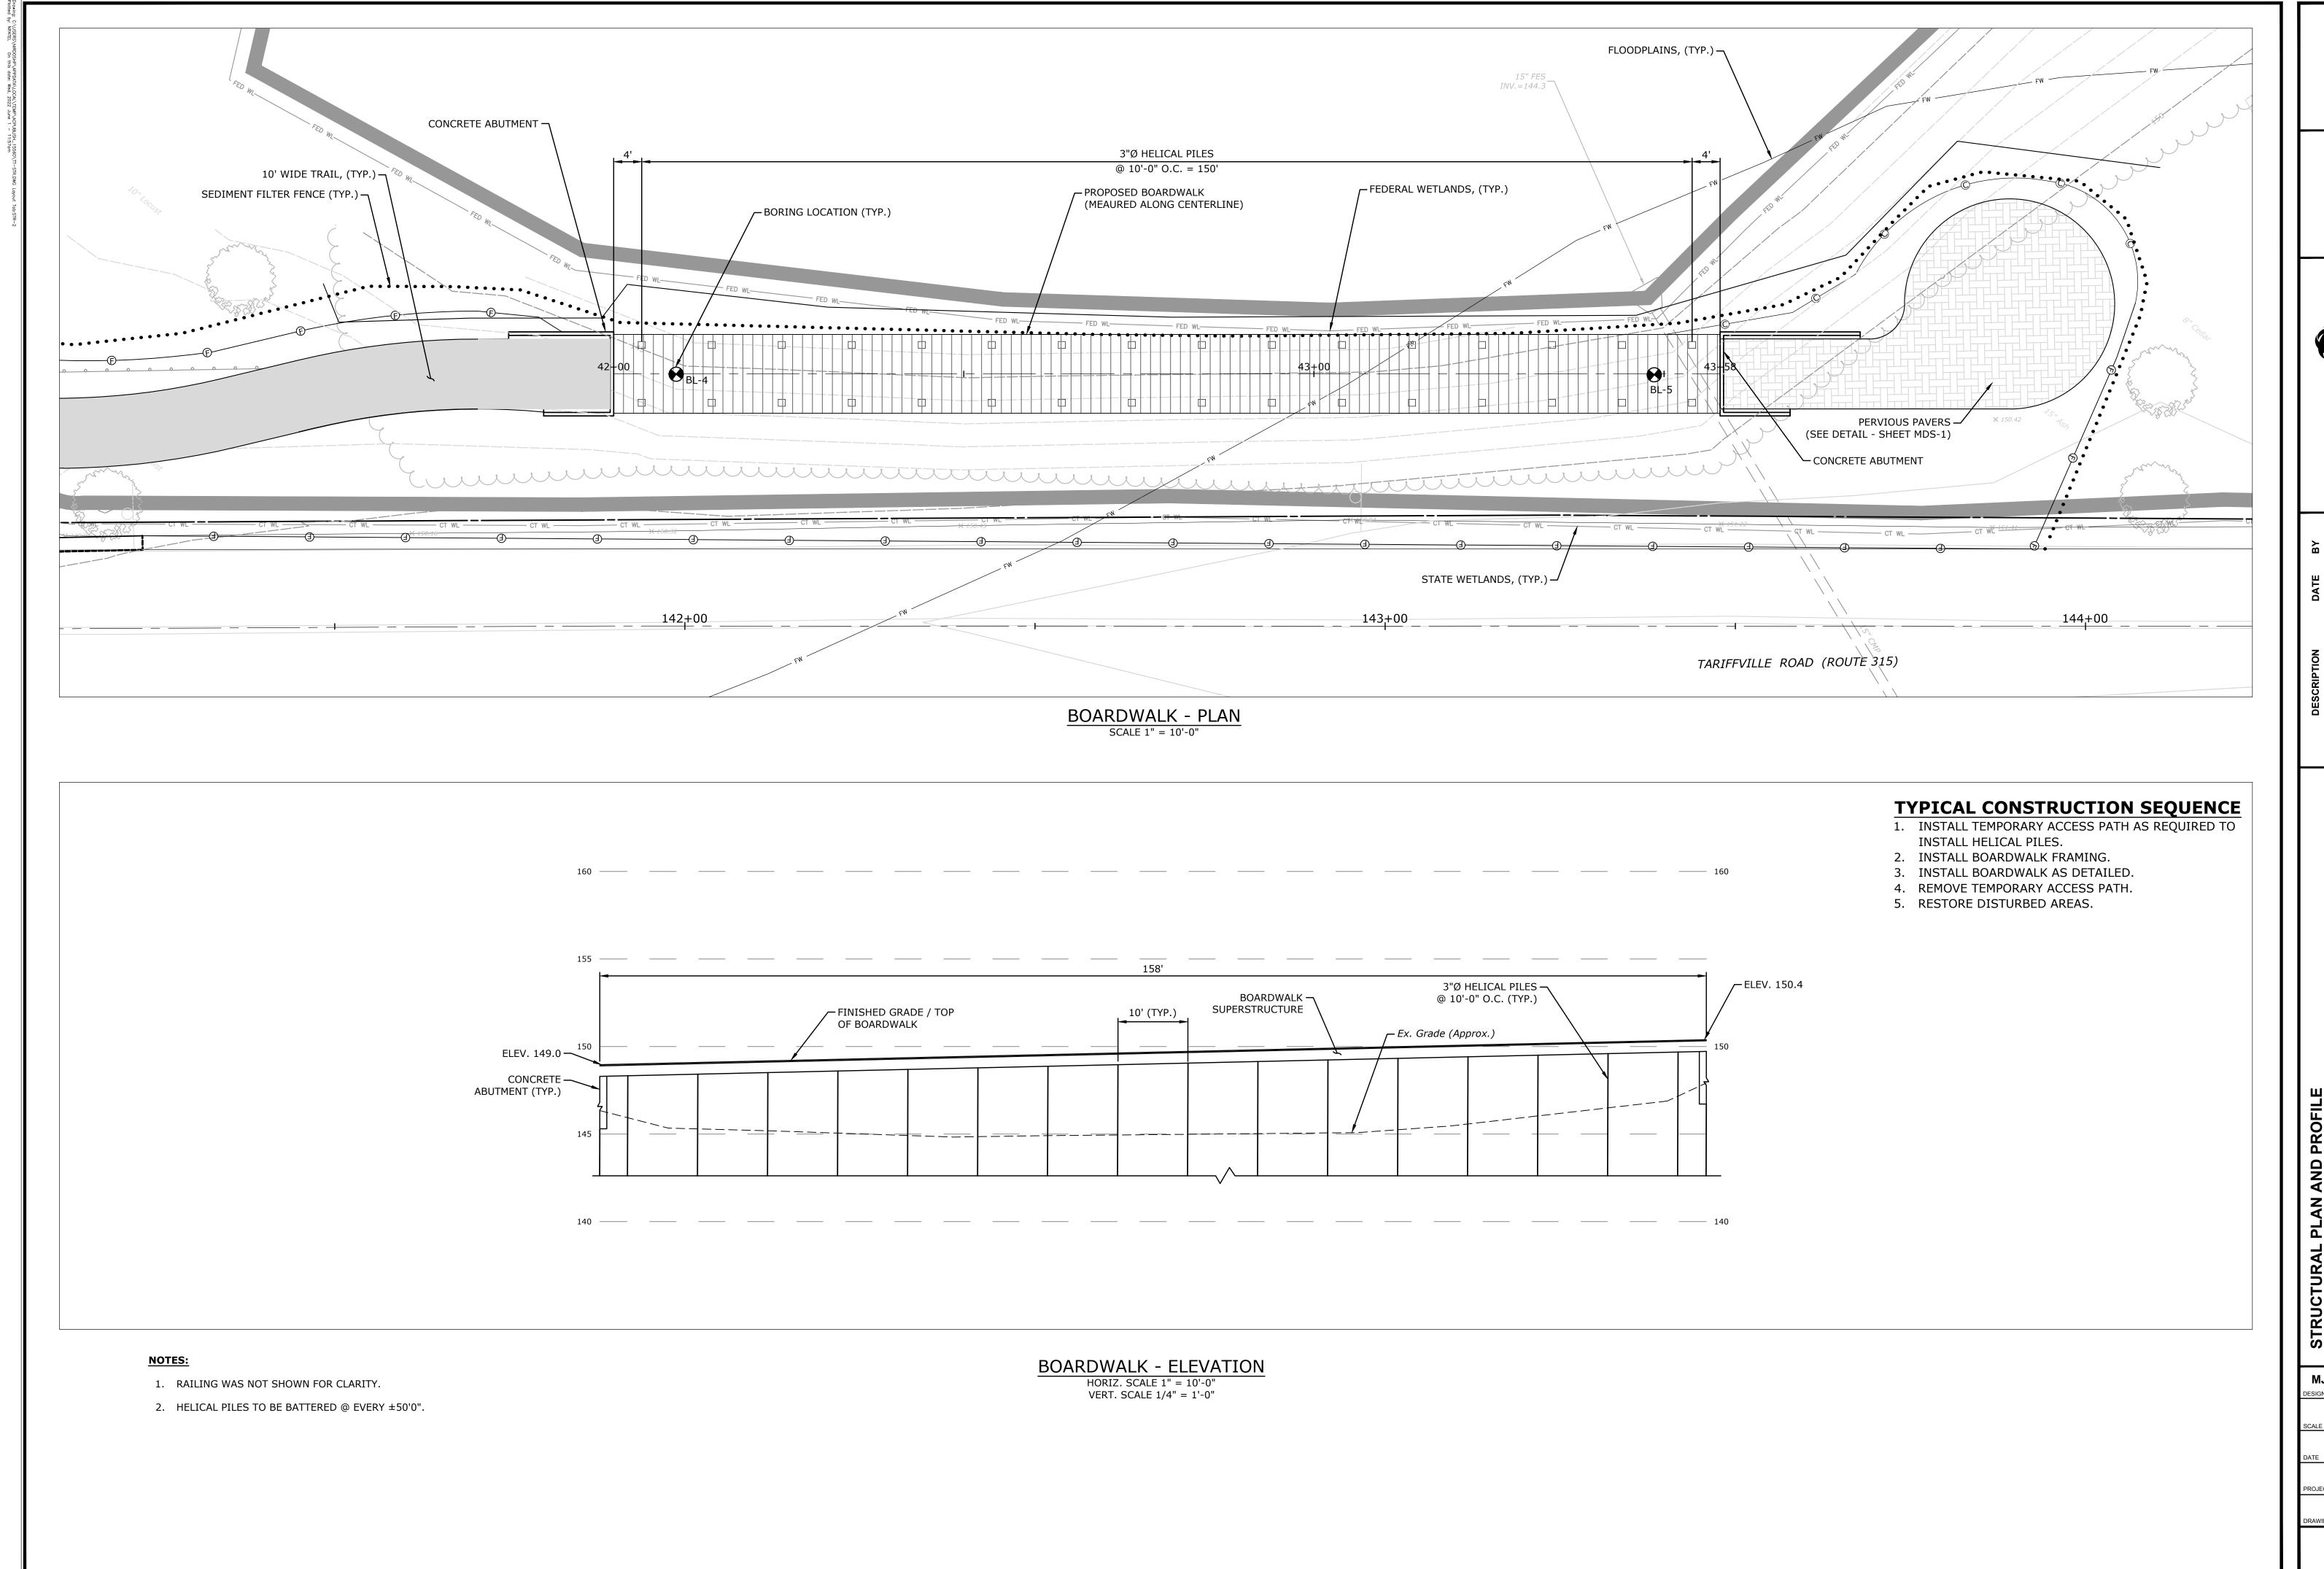

0' 5' 10'



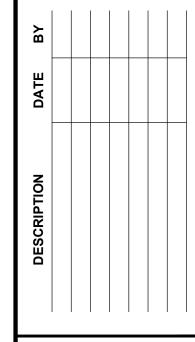

V AND PROFILE CTION, MULTI-USE TRAIL ST (RT.10) TO CURTISS AND PATTISON PARK

TARIFFVILLE CONNECTION FROM HOPMEADOW ST (RITARIFFVILLE ROAD (CT ROUTE 3

MJJ ELF MJJ CHECKED

1"=10'
SCALE

MAY 2022

DATE

1613-20
PROJECT NO.

STR-2
DRAWING NO.

COPYRIGHT, SLR INTERNATIONAL CORPORATION - 2022